

LIST OF DRAWINGS						
EXISTING (	CONDITION					
EC	EXISTING CONDITION - PLAN OF LAND					
CIVIL						
C010	UTILITIES AND DRAINAGE PLAN					
ARCHITEC	TURE					
A100	BASE FLOOR PLAN					
A100A	BASE FLOOR PLAN - A					
A100B	BASE FLOOR PLAN - B					
A101	FIRST FLOOR PLAN					
A101A	FIRST FLOOR PLAN - A					
A101B	FIRST FLOOR PLAN - B					
A101C	FIRST FLOOR PLAN - C					
A102	SECOND FLOOR PLAN					
A102A	SECOND FLOOR PLAN - A					
A102B	SECOND FLOOR PLAN - B					
A102C	SECOND FLOOR PLAN - C					
A103	THIRD FLOOR PLAN					
A103A	THIRD FLOOR PLAN - A					
A103B	THIRD FLOOR PLAN - B					
A103C	THIRD FLOOR PLAN - C					
A104	FOURTH FLOOR PLAN					
A104A	FOURTH FLOOR PLAN - A					
A104B	FOURTH FLOOR PLAN - B					
A104C	FOURTH FLOOR PLAN - C					
A105	ROOF PLAN					
A105A	ROOF PLAN - A					
A105B	ROOF PLAN - B					
A105C	ROOF PLAN - C					
A200	EXTERIOR ELEVATIONS					
A300	BUILDING SECTIONS					
A400	EXTERIOR 3D VIEWS					
A500	TYPICAL INTERIOR ELEVATIONS					
A501	TYPICAL INTERIOR ELEVATIONS					
FIRE PROT	TECTION					
FP 100	BASE FLOOR PLAN - FIRE PROTECTION					
FP 101	FIRST FLOOR PLAN - FIRE PROTECTION					
FP 102	SECOND FLOOR PLAN - FIRE PROTECTION					
FP 103	THIRD FLOOR PLAN - FIRE PROTECTION					
FP 104	FOURTH FLOOR PLAN - FIRE PROTECTION					
11 104						
PLUMBING						
P101	BASE FLOOR PLAN - PLUMBING					
P102	FIRST FLOOR PLAN - PLUMBING					
P103	SECOND FLOOR PLAN - PLUMBING					
P104	THIRD FLOOR PLAN - PLUMBING					
P105	FOURTH FLOOR PLAN - PLUMBING					
P106	ROOF PLAN - PLUMBING					

MECHANICAL

IICAL
HVAC - BASE FLOOR PLAN
HVAC - FIRST FLOOR PLAN
HVAC - SECOND FLOOR PLAN
HVAC - THIRD FLOOR PLAN
HVAC - FOURTH FLOOR PLAN
HVAC - ROOF PLAN
HVAC - ENLARGED MECHANICAL ROOM PLAN
HVAC - HYDRONIC FLOW DIAGRAM
HVAC - AHU AIRFLOW AND HYDRONIC FLOW DIAGRAMS

# ELECTRICAL

E001	ELECTRICAL SYMBOL LIST
E200	BASE FLOOR PLAN - ELECTRICAL
E201	FIRST FLOOR PLAN - ELECTRICAL
E202	SECOND FLOOR PLAN - ELECTRICAL
E203	THIRD FLOOR PLAN - ELECTRICAL
E204	FOURTH FLOOR PLAN - ELECTRICAL
E205	ROOF PLAN - ELECTRICAL
E301	ONE-LINE POWER RISER
E405	FIRE ALARM RISER AND DETAILS


SCHEMATIC DESIGN


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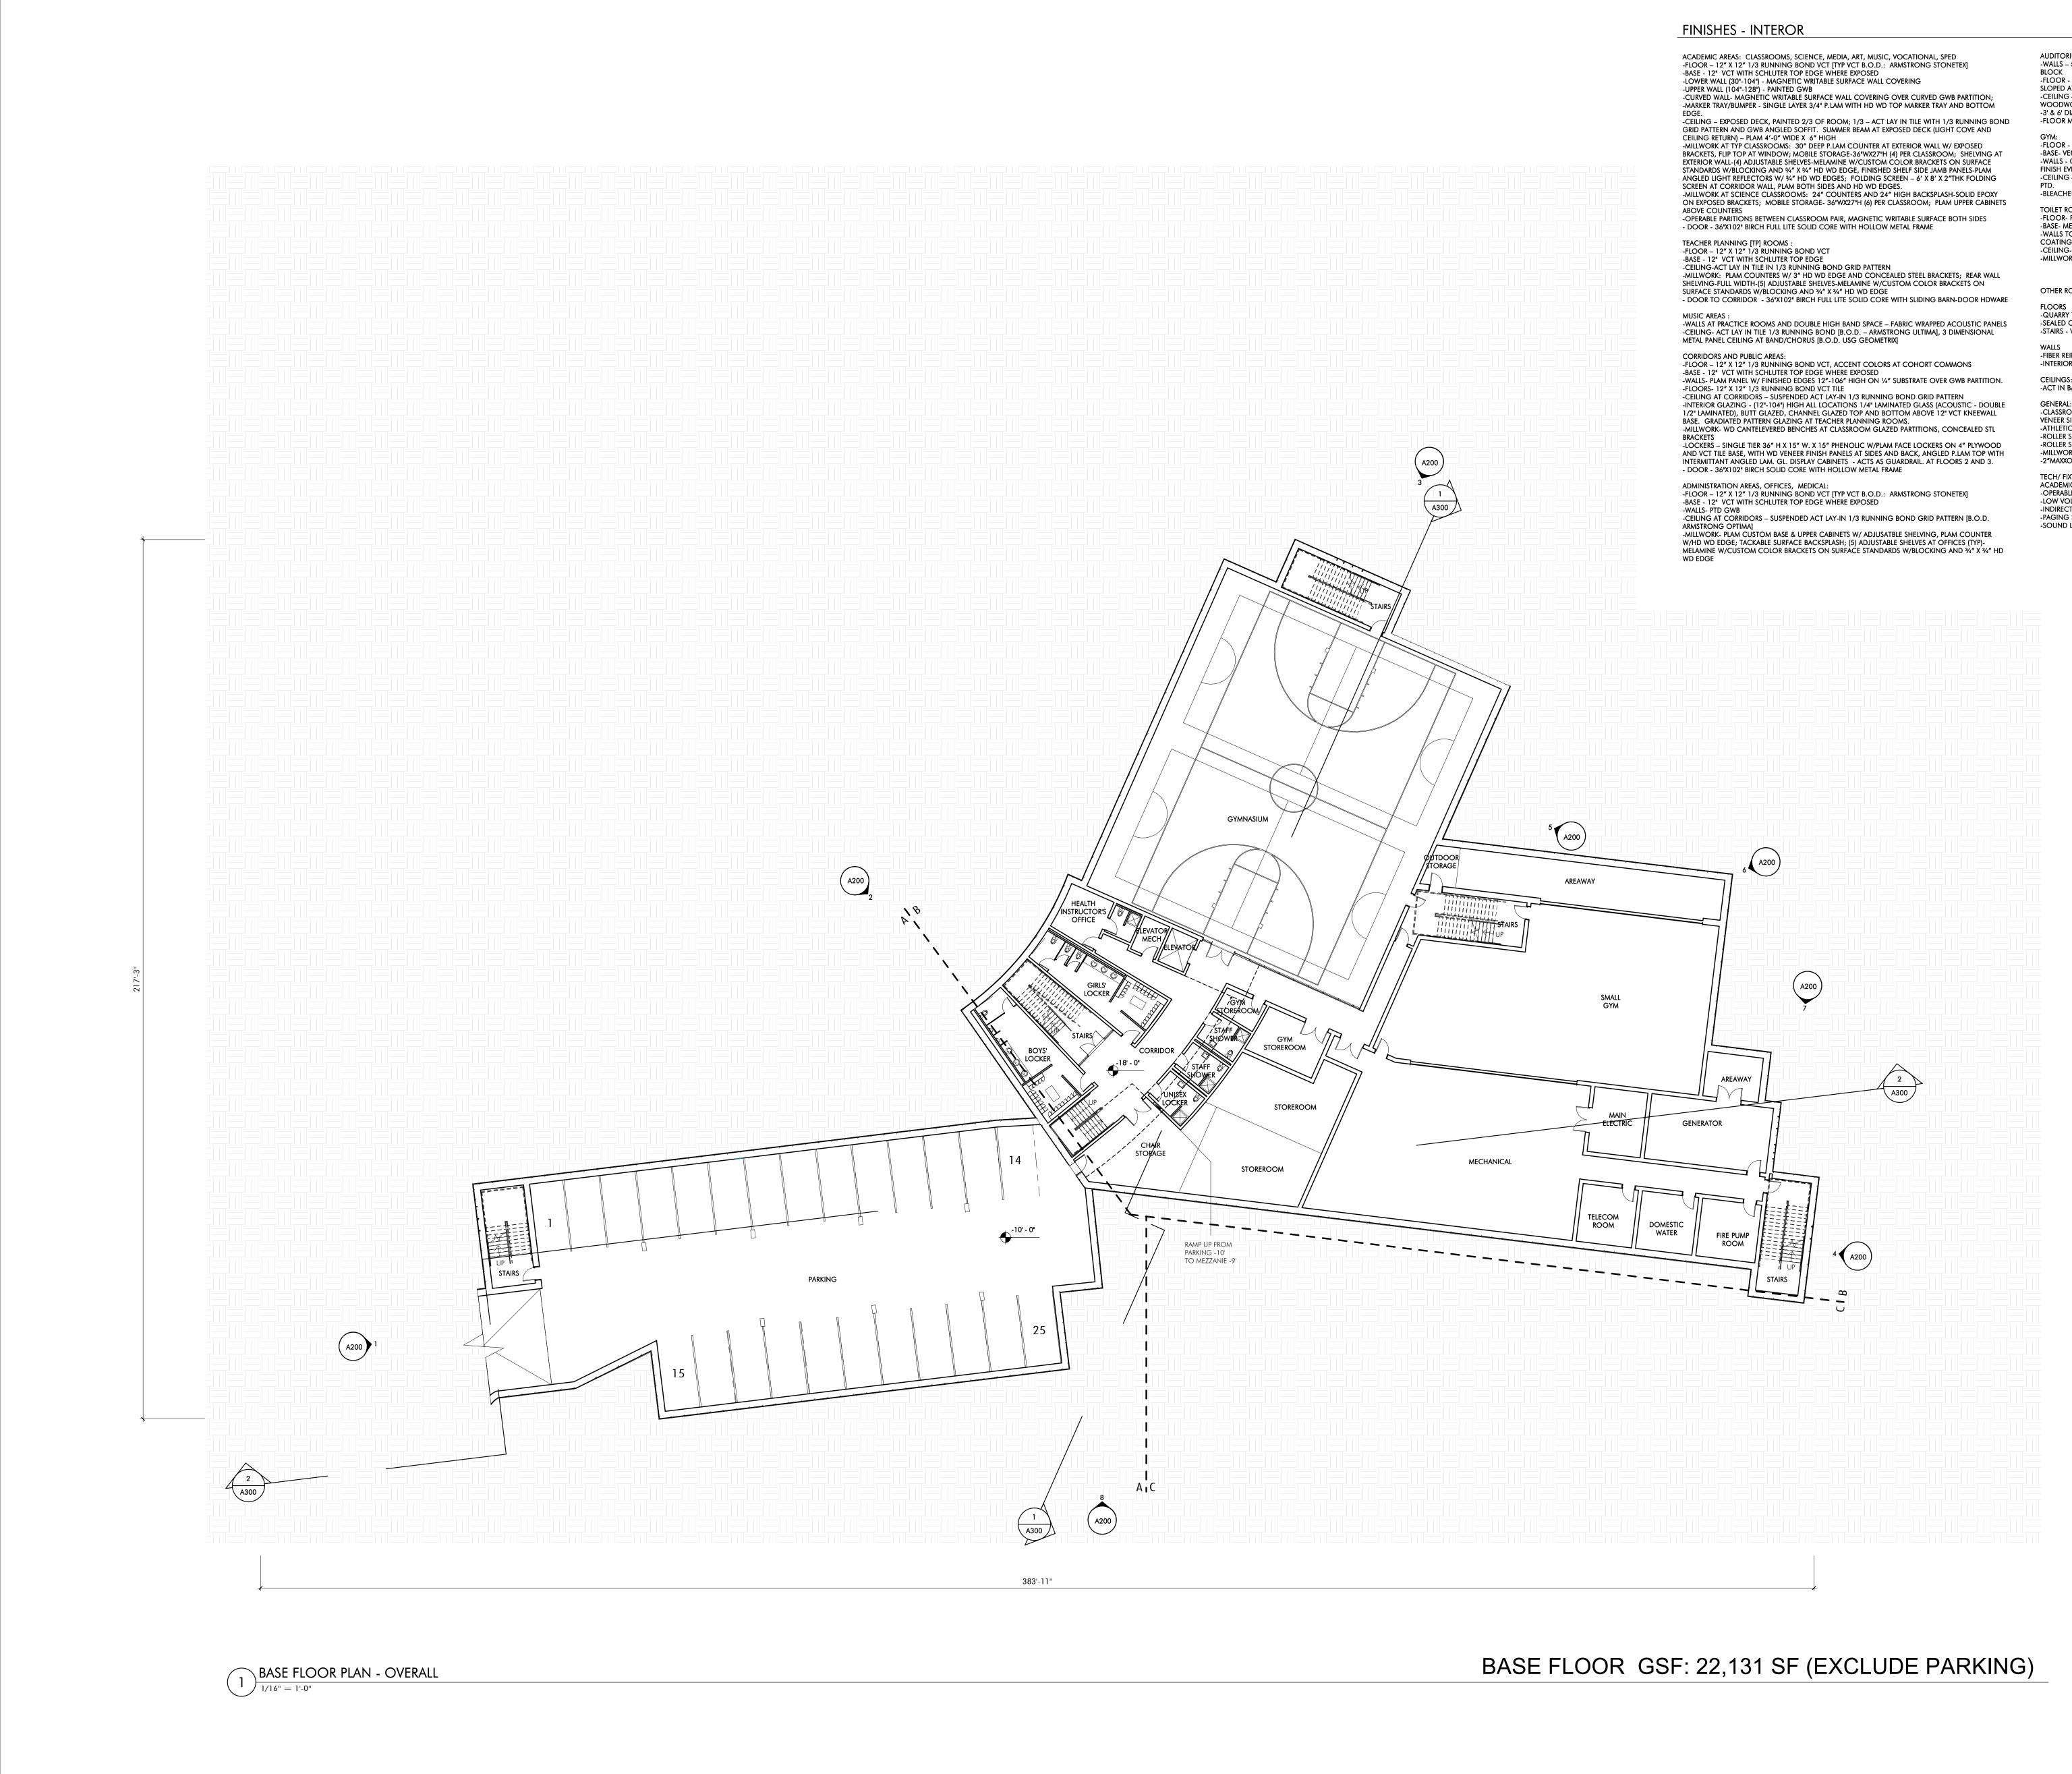
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05/22/2019





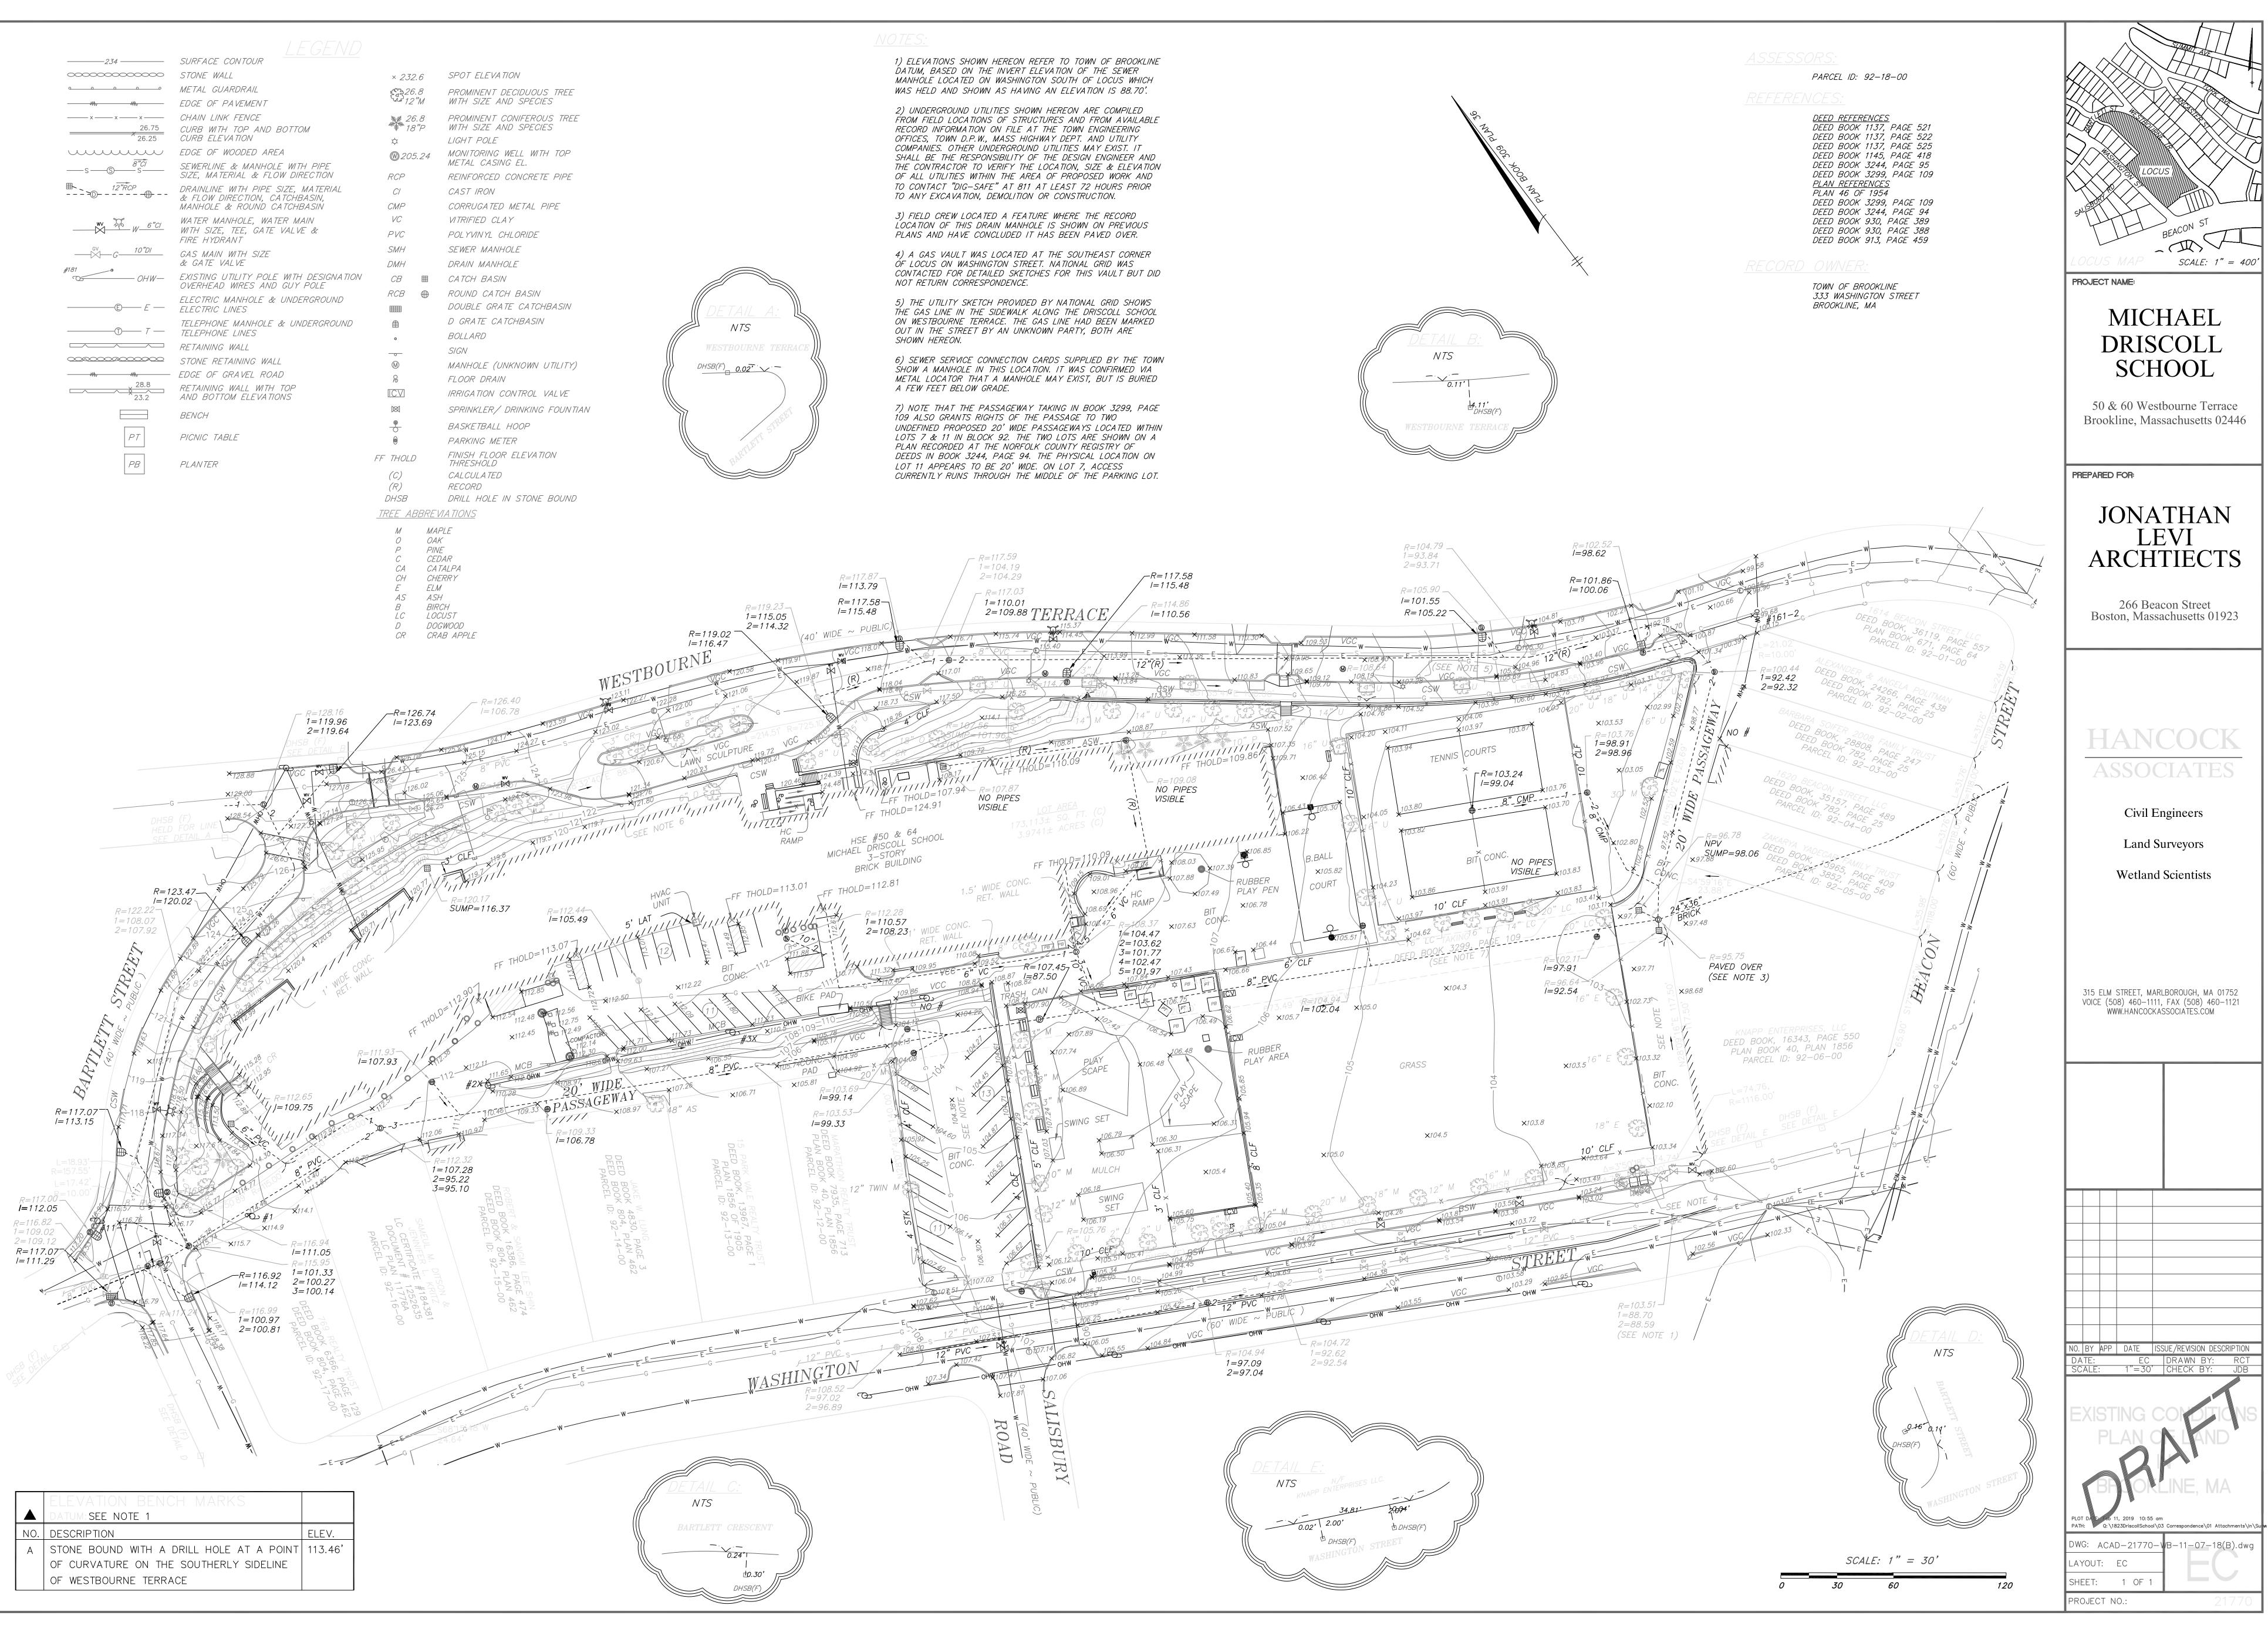

AUDITORIUM: -WALLS – 50% ACOUSTIC WOOD WALL SYSTEM [ARMSTRONG WOODWORKS], 50% GROUND FACED BLOCK -FLOOR - CARPET AT AISLES, SLAB ON GRADE POWER TROWELED CONCRETE AT SEATS (SLAB IS SLOPED AT SEATING AREA) -CEILING -PTD. EXPOSED METAL DECK WITH 50% SUSPENDED WOOD PANEL CEILING (ARMSTRONG WOODWORKS) -3' & 6' DIAMETER DOUBLE DOME ACRYLIC BUBBLE SKYLIGHT -FLOOR MOUNTED FOLD UP AUDITORIUM SEATING (420 SEATS)
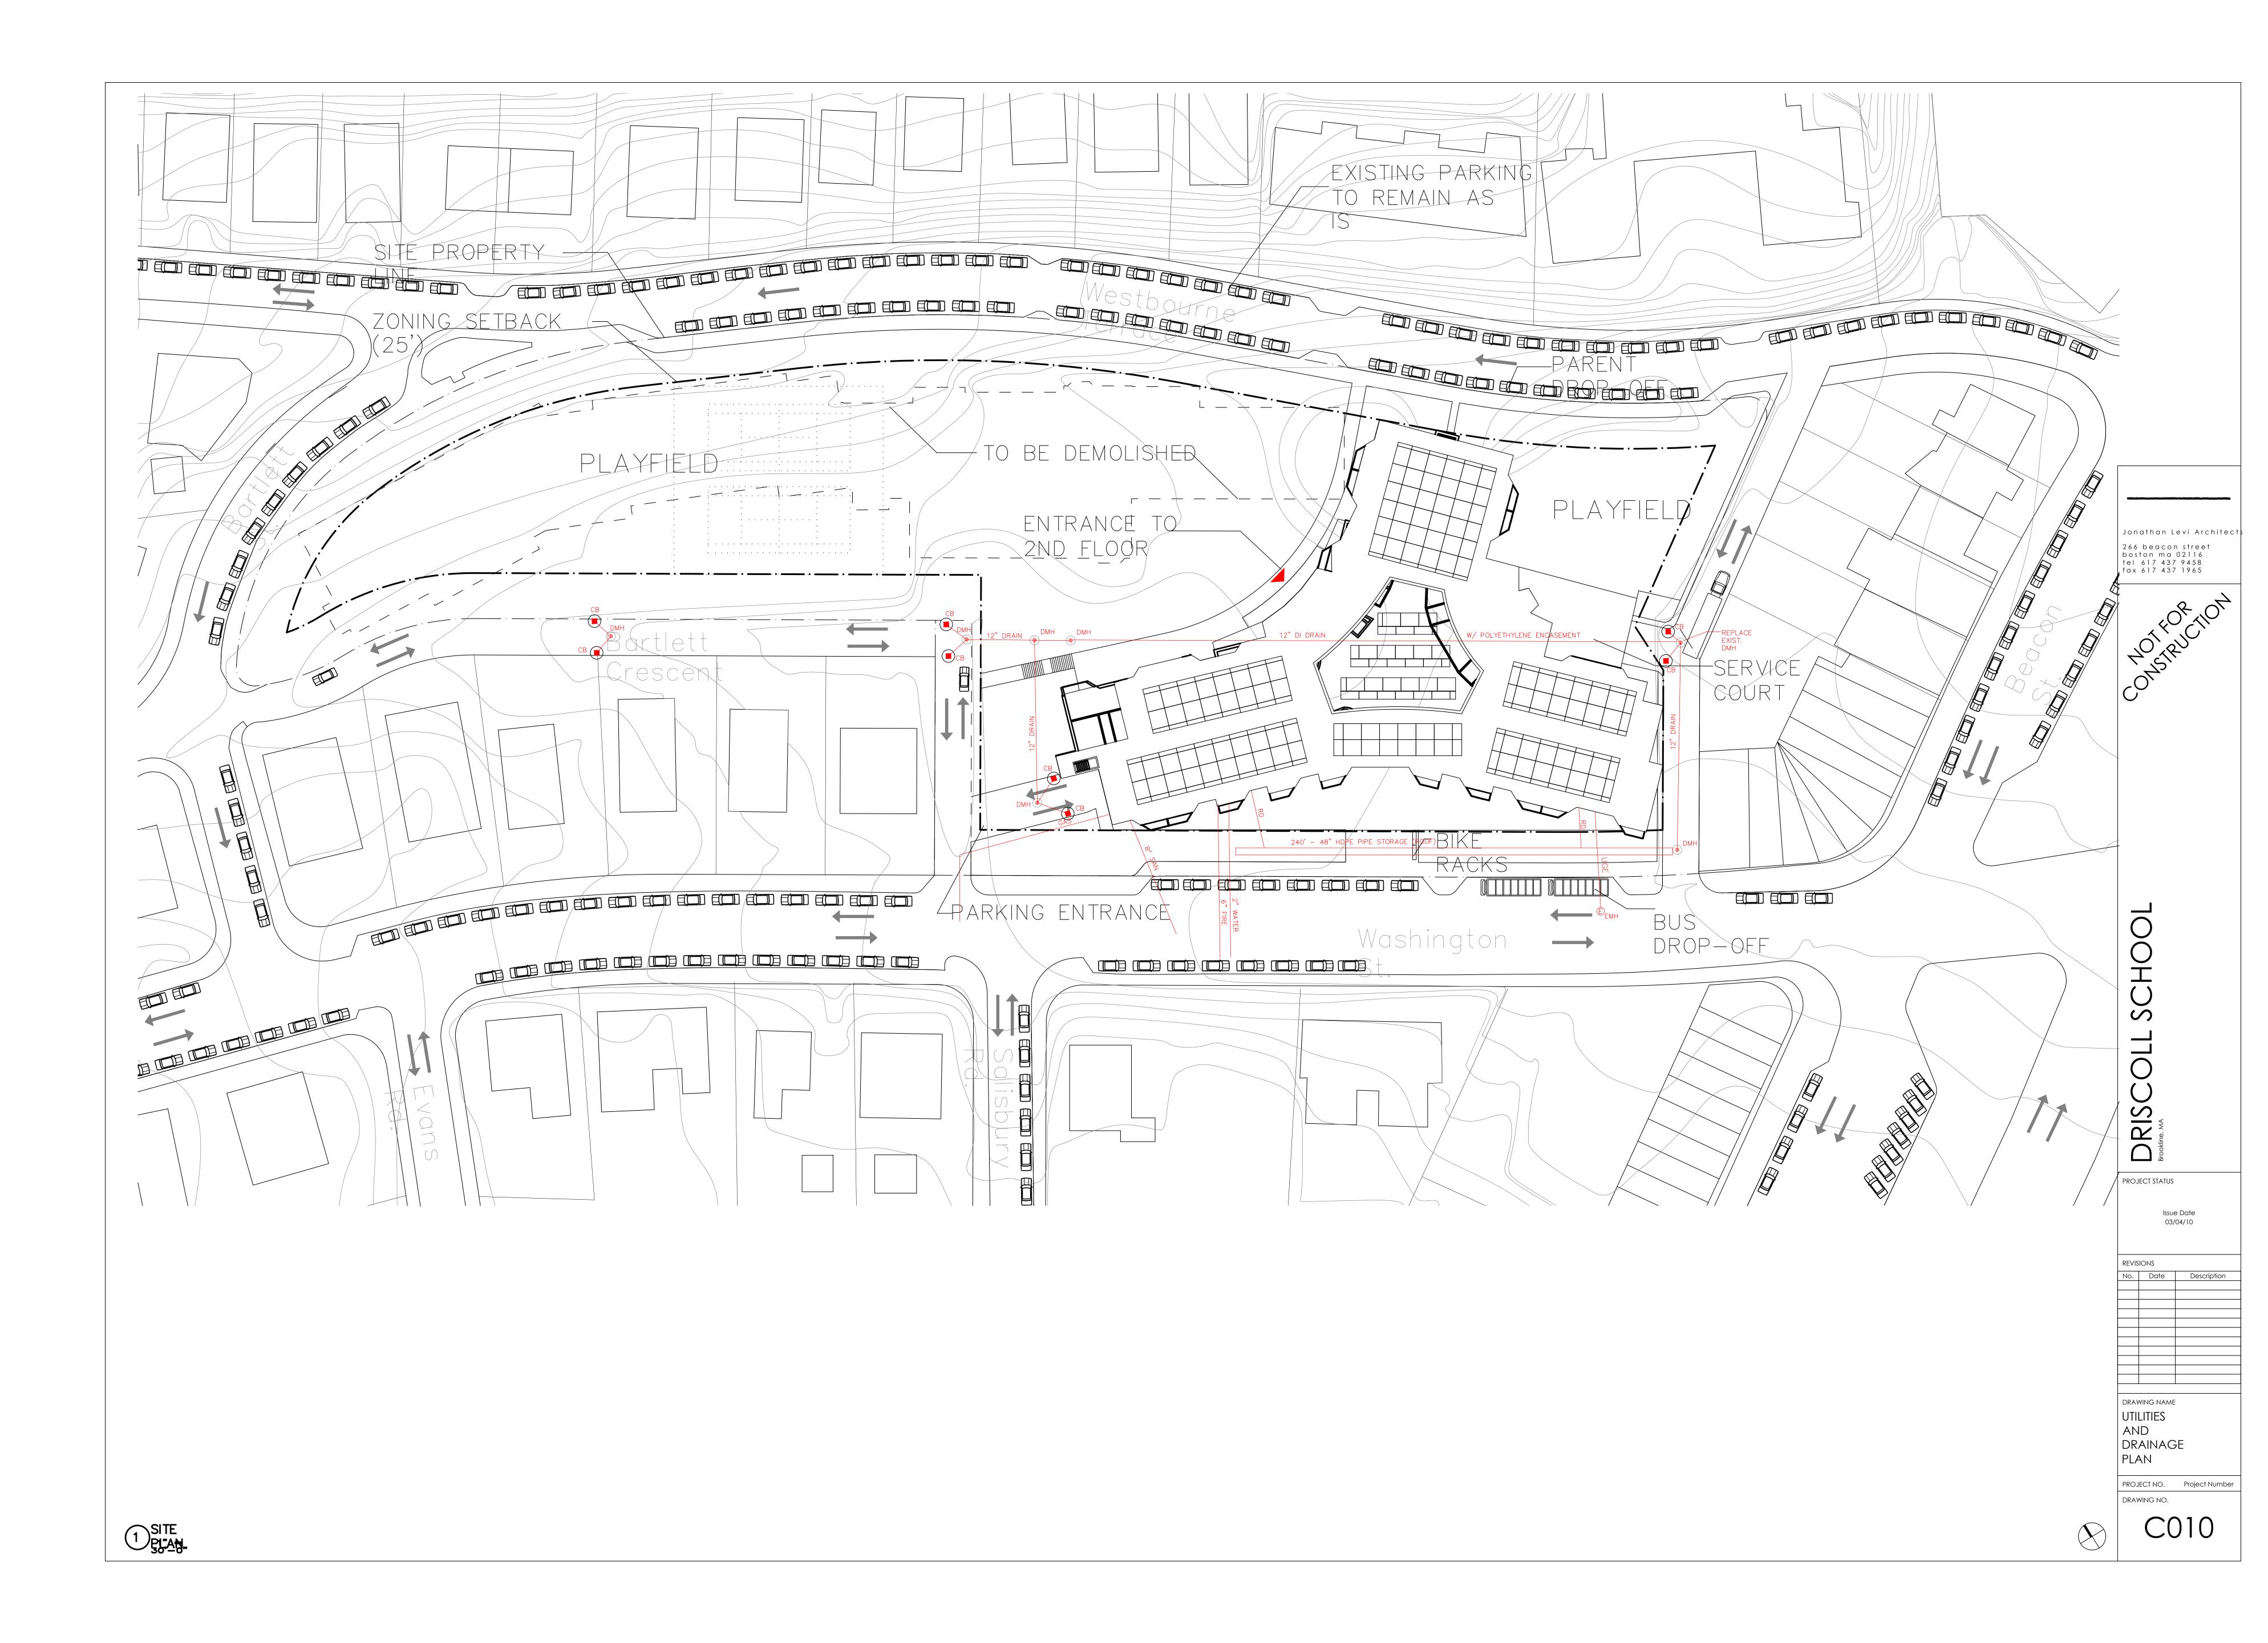
#### -FLOOR - WOOD ATHLETIC FLOORING -BASE- VENTED RUBBER BASE

-WALLS - GYM WALL PADS TO BE 8'-8" A.F.F. EXCEPT BEHIND BLEACHERS, PRE-ENGINEERED STANDARD FINISH EVERYWHERE ELSE -CEILING – SUSPENDED LAY IN PRE PAINTED TEGULAR EDGE TECTUM PLANK AND EXPOSED DECK, -BLEACHERS- TELESCOPING, WALL MOUNTED, MOTORIZED FOR UP TO 750 SEATS TOILET ROOMS: -FLOOR- PORCELAIN TILE

## -BASE- METAL COVE BASE

COATING -CEILING-PTD W/HIGH PERFORMANCE COATING -MILLWORK- SOLID SURFACE COUNTERS WITH CONCEALED STEEL BRACKETS

# OTHER ROOMS:

-QUARRY TILE AT KITCHEN. 1/3 RUNNING BOND -SEALED CONCRETE AT BACK OF HOUSE -STAIRS - VCT TREADS & RISERS WITH RUBBER NOSING, VCT TILE AT LANDINGS

-FIBER REINFORCED PANELS IN KITCHEN -INTERIOR GLAZING TO BE CHANNEL GLAZING NOT HM

CEILINGS: -ACT IN BACK OF HOUSE AREAS, LOCKER ROOMS & KITCHEN

GENERAL:


-CLASSROOM LOCKERS 15"Wx12"Dx36"H W/ANGLED TOP – PHENOLIC W/PLAM FINISH AND WD VENEER SIDES AND BACK VEINEER SIDES AND BACK -ATHLETIC / PE LOCKERS: 50 COUNT PER LOCKER ROOM - METAL 2 TIER 30"H. X 15"W X 15"D -ROLLER SHADE AT DOORS WITH LITES AND GLAZED PARTITIONS -ROLLER SHADE AT SOUTH EXTERIOR WINDOWS -MILLWORK PLAM – WD GRAIN PLAM FINISH -2"MAXXON TOPPING SLAB-ACOUSTIC AT FLOORS 2, 3, 4


TECH/ FIXTURES/ FURNISHINGS ACADEMIC AREAS: -OPERABLE WINDOWS

-LOW VOLUME DISPLACEMENT VENTILATION


-INDIRECT LED COVE LIGHTING -PAGING SYSTEM, WIRELESS DATA INTERCOM, CLOCK SYSTEM, -SOUND LIFT SYSTEM, WIRELESS ACCESS POINT, LED TOUCH SCREEN MONITOR


-WALLS TO 98"- CERAMIC TILE, W/ ACCENT COLOR. PTD GWB ABOVE W/HIGH PERFORMANCE

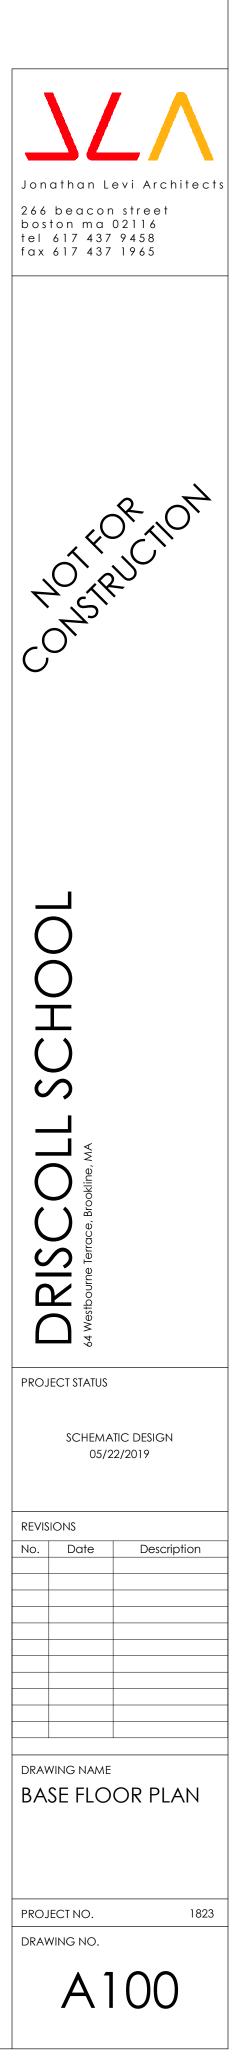


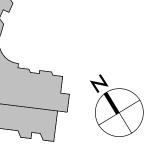





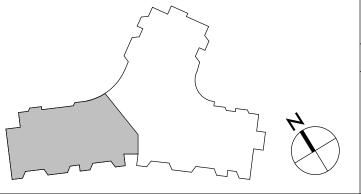

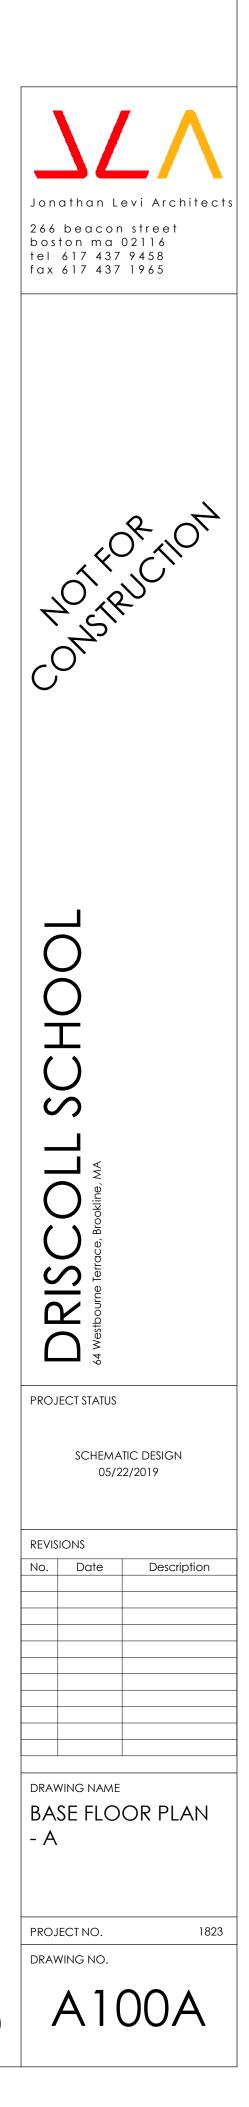

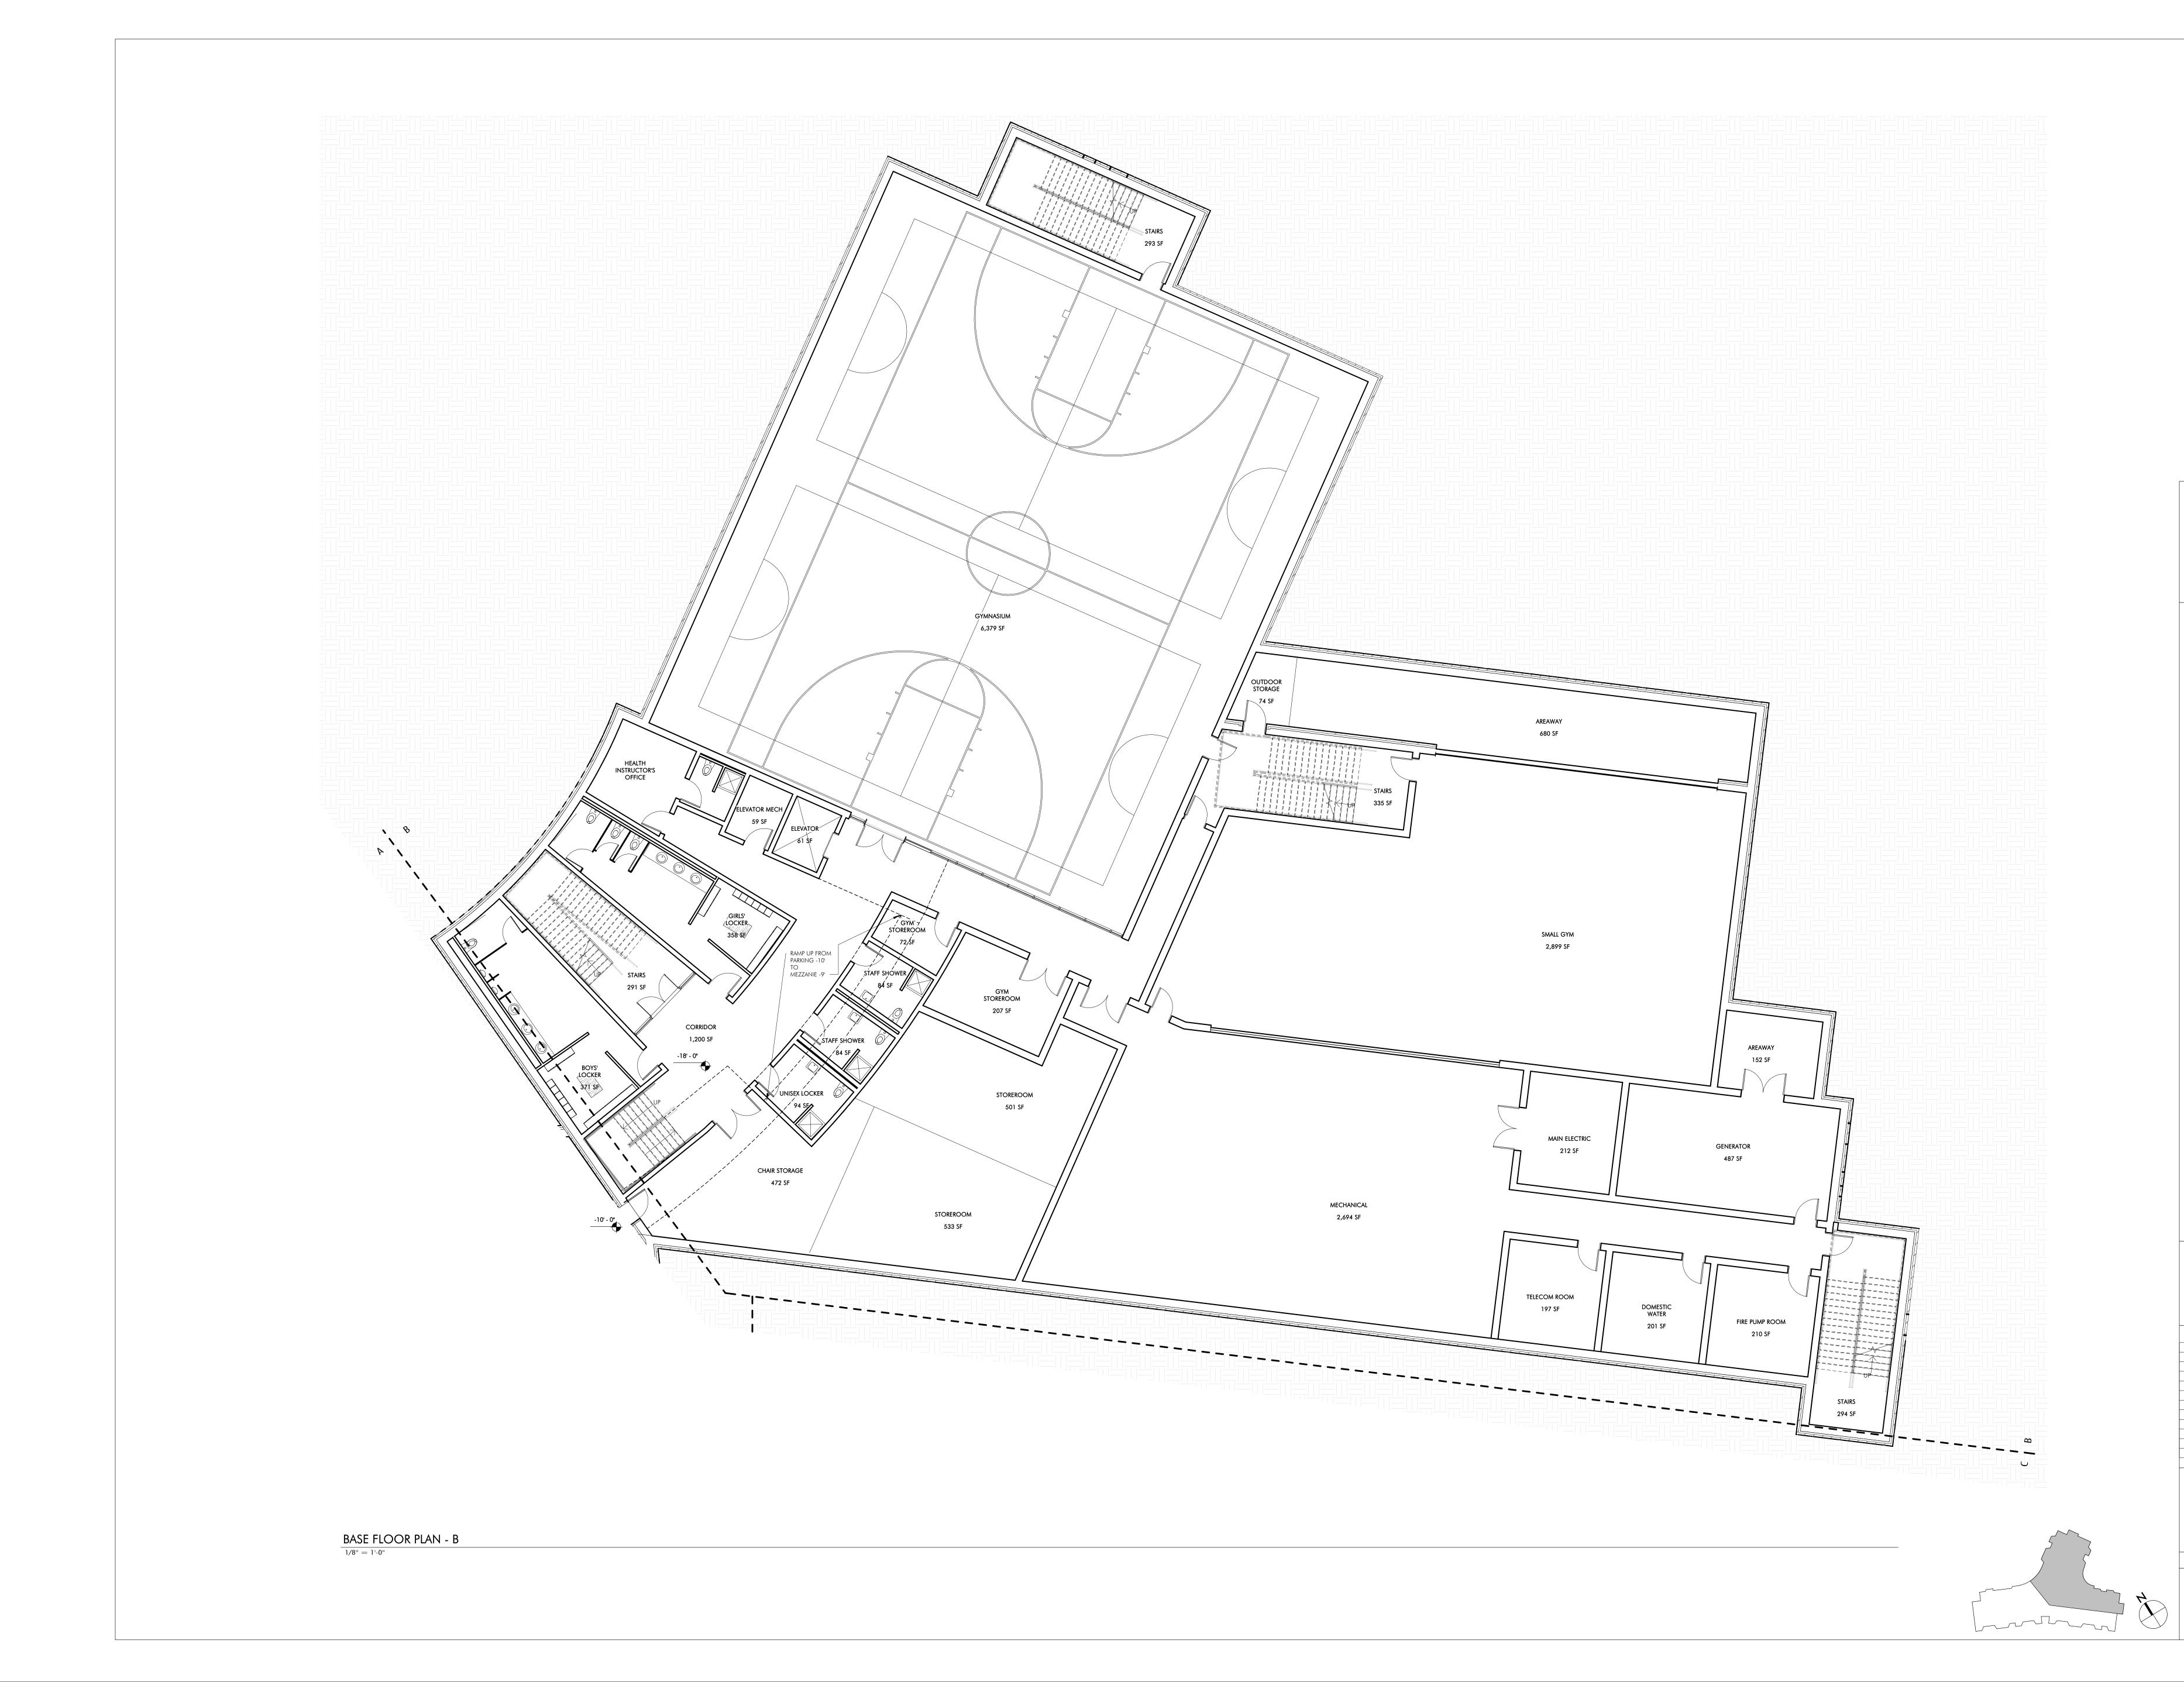

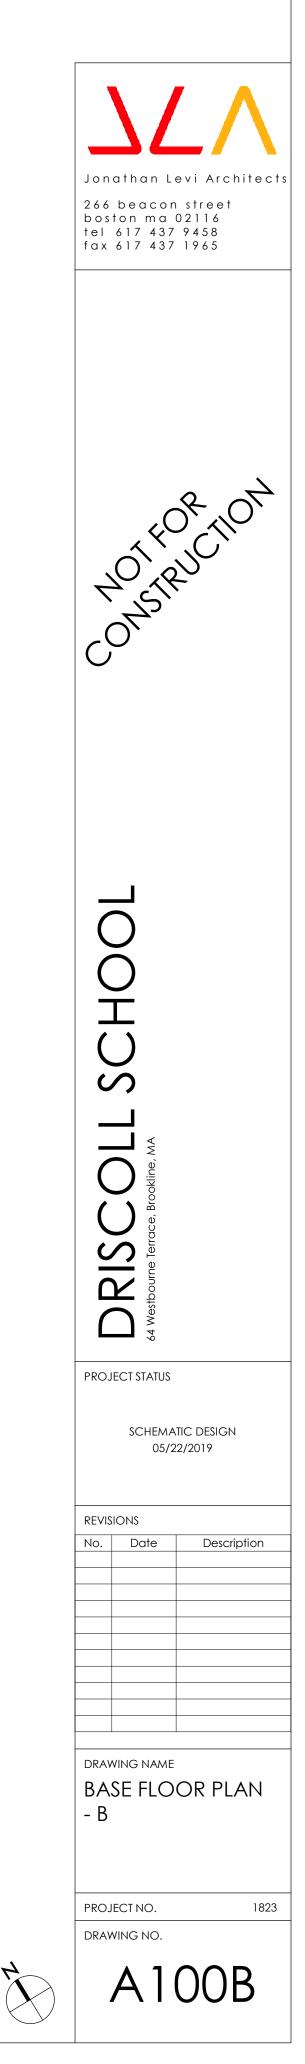

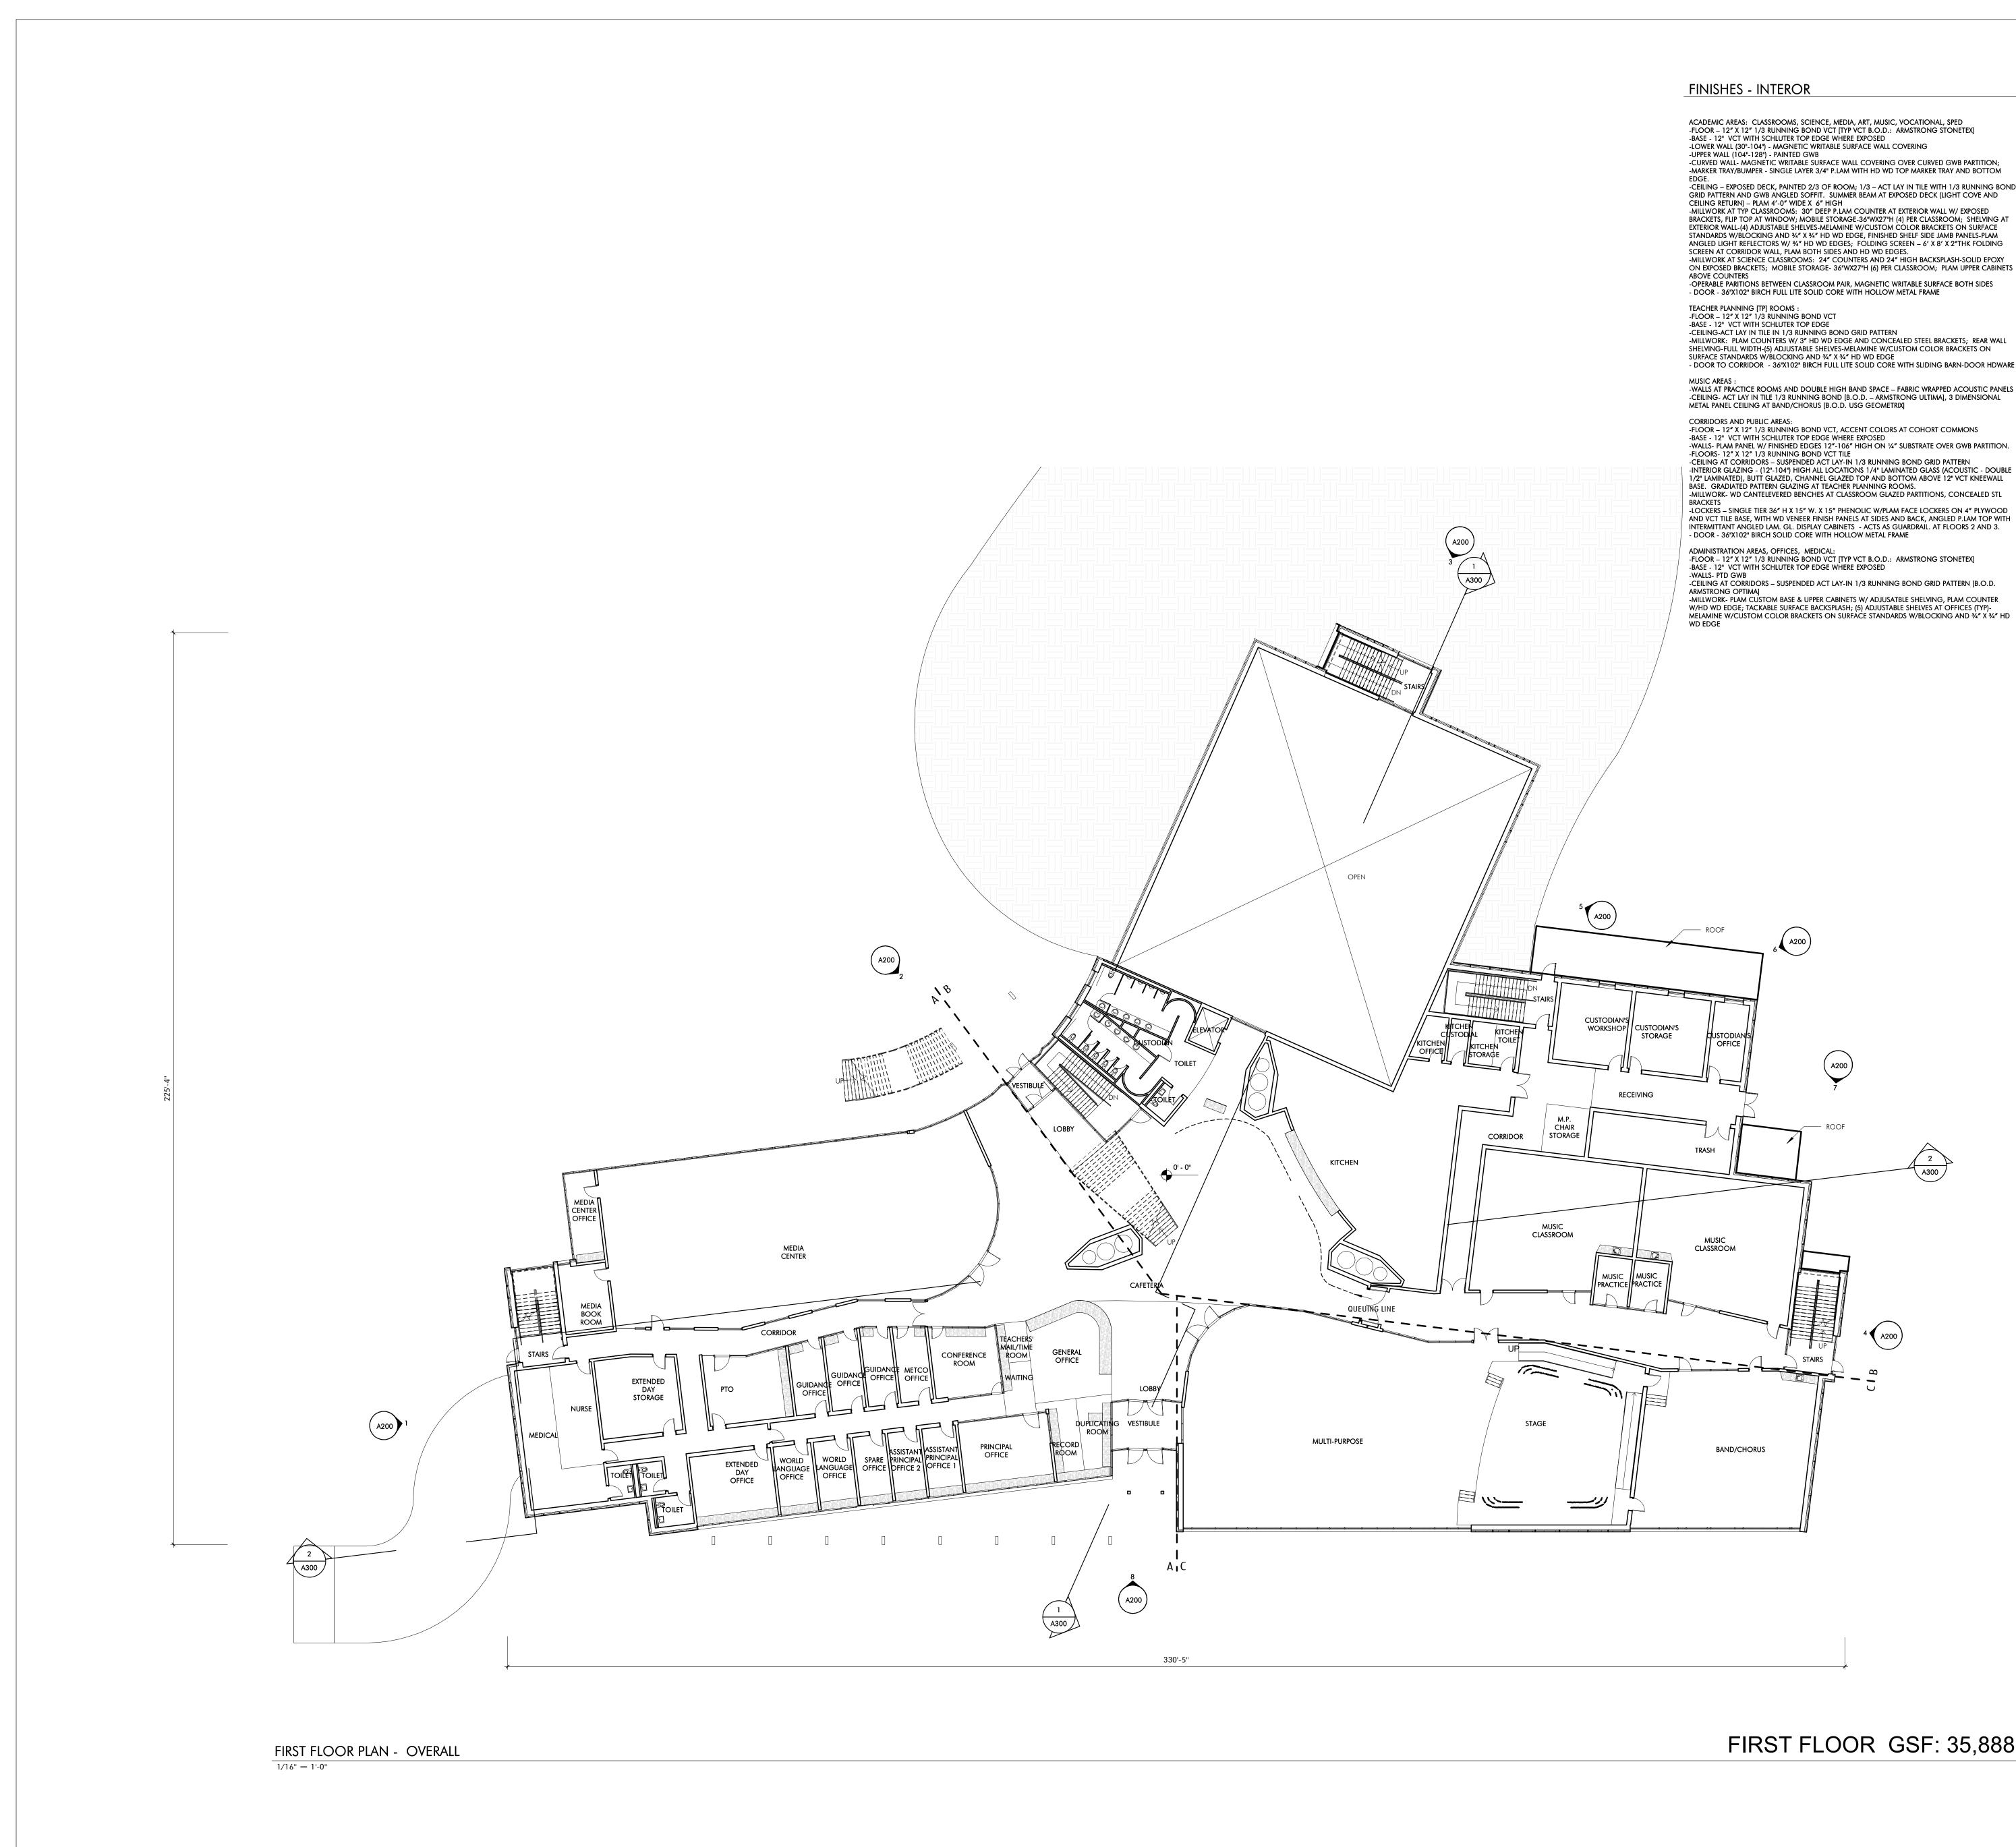

ACADEMIC AREAS: CLASSROOMS, SCIENCE, MEDIA, ART, MUSIC, VOCATIONAL, SPED -FLOOR – 12" X 12" 1/3 RUNNING BOND VCT [TYP VCT B.O.D.: ARMSTRONG STONETEX]

-CURVED WALL- MAGNETIC WRITABLE SURFACE WALL COVERING OVER CURVED GWB PARTITION; -MARKER TRAY/BUMPER - SINGLE LAYER 3/4" P.LAM WITH HD WD TOP MARKER TRAY AND BOTTOM -CEILING – EXPOSED DECK, PAINTED 2/3 OF ROOM; 1/3 – ACT LAY IN TILE WITH 1/3 RUNNING BOND GRID PATTERN AND GWB ANGLED SOFFIT. SUMMER BEAM AT EXPOSED DECK (LIGHT COVE AND

-MILLWORK AT TYP CLASSROOMS: 30" DEEP P.LAM COUNTER AT EXTERIOR WALL W/ EXPOSED BRACKETS, FLIP TOP AT WINDOW; MOBILE STORAGE-36"WX27"H (4) PER CLASSROOM; SHELVING AT EXTERIOR WALL-(4) ADJUSTABLE SHELVES-MELAMINE W/CUSTOM COLOR BRACKETS ON SURFACE STANDARDS W/BLOCKING AND 34" X 34" HD WD EDGE, FINISHED SHELF SIDE JAMB PANELS-PLAM ANGLED LIGHT REFLECTORS W/ 3/4" HD WD EDGES; FOLDING SCREEN - 6' X 8' X 2"THK FOLDING

-MILLWORK AT SCIENCE CLASSROOMS: 24" COUNTERS AND 24" HIGH BACKSPLASH-SOLID EPOXY

ON EXPOSED BRACKETS; MOBILE STORAGE- 36"WX27"H (6) PER CLASSROOM; PLAM UPPER CABINETS -OPERABLE PARITIONS BETWEEN CLASSROOM PAIR, MAGNETIC WRITABLE SURFACE BOTH SIDES

-MILLWORK: PLAM COUNTERS W/ 3" HD WD EDGE AND CONCEALED STEEL BRACKETS; REAR WALL SHELVING-FULL WIDTH-(5) ADJUSTABLE SHELVES-MELAMINE W/CUSTOM COLOR BRACKETS ON

- DOOR TO CORRIDOR - 36"X102" BIRCH FULL LITE SOLID CORE WITH SLIDING BARN-DOOR HDWARE

-WALLS AT PRACTICE ROOMS AND DOUBLE HIGH BAND SPACE - FABRIC WRAPPED ACOUSTIC PANELS -CEILING- ACT LAY IN TILE 1/3 RUNNING BOND [B.O.D. – ARMSTRONG ULTIMA], 3 DIMENSIONAL

-FLOOR – 12" X 12" 1/3 RUNNING BOND VCT, ACCENT COLORS AT COHORT COMMONS

-WALLS- PLAM PANEL W/ FINISHED EDGES 12"-106" HIGH ON 1/4" SUBSTRATE OVER GWB PARTITION. -INTERIOR GLAZING - (12"-104") HIGH ALL LOCATIONS 1/4" LAMINATED GLASS (ACOUSTIC - DOUBLE 1/2" LAMINATED), BUTT GLAZED, CHANNEL GLAZED TOP AND BOTTOM ABOVE 12" VCT KNEEWALL

-MILLWORK- WD CANTELEVERED BENCHES AT CLASSROOM GLAZED PARTITIONS, CONCEALED STL -LOCKERS – SINGLE TIER 36" H X 15" W. X 15" PHENOLIC W/PLAM FACE LOCKERS ON 4" PLYWOOD AND VCT TILE BASE, WITH WD VENEER FINISH PANELS AT SIDES AND BACK, ANGLED P.LAM TOP WITH

INTERMITTANT ANGLED LAM. GL. DISPLAY CABINETS - ACTS AS GUARDRAIL. AT FLOORS 2 AND 3.

-CEILING AT CORRIDORS - SUSPENDED ACT LAY-IN 1/3 RUNNING BOND GRID PATTERN [B.O.D. -MILLWORK- PLAM CUSTOM BASE & UPPER CABINETS W/ ADJUSATBLE SHELVING, PLAM COUNTER

AUDITORIUM: -WALLS – 50% ACOUSTIC WOOD WALL SYSTEM [ARMSTRONG WOODWORKS], 50% GROUND FACED BLOCK -FLOOR - CARPET AT AISLES, SLAB ON GRADE POWER TROWELED CONCRETE AT SEATS (SLAB IS SLOPED AT SEATING AREA) -CEILING –PTD. EXPOSED METAL DECK WITH 50% SUSPENDED WOOD PANEL CEILING (ARMSTRONG WOODWORKS) -3' & 6' DIAMETER DOUBLE DOME ACRYLIC BUBBLE SKYLIGHT -FLOOR MOUNTED FOLD UP AUDITORIUM SEATING (420 SEATS)

GYM: -FLOOR - WOOD ATHLETIC FLOORING -BASE- VENTED RUBBER BASE -WALLS - GYM WALL PADS TO BE 8'-8" A.F.F. EXCEPT BEHIND BLEACHERS, PRE-ENGINEERED STANDARD FINISH EVERYWHERE ELSE -CEILING – SUSPENDED LAY IN PRE PAINTED TEGULAR EDGE TECTUM PLANK AND EXPOSED DECK, -BLEACHERS- TELESCOPING, WALL MOUNTED, MOTORIZED FOR UP TO 750 SEATS

TOILET ROOMS: -FLOOR- PORCELAIN TILE

-BASE- METAL COVE BASE -WALLS TO 98"- CERAMIC TILE, W/ ACCENT COLOR. PTD GWB ABOVE W/HIGH PERFORMANCE COATING -CEILING-PTD W/HIGH PERFORMANCE COATING -MILLWORK- SOLID SURFACE COUNTERS WITH CONCEALED STEEL BRACKETS

OTHER ROOMS: FLOORS

-QUARRY TILE AT KITCHEN. 1/3 RUNNING BOND -SEALED CONCRETE AT BACK OF HOUSE -STAIRS - VCT TREADS & RISERS WITH RUBBER NOSING, VCT TILE AT LANDINGS WALLS

-FIBER REINFORCED PANELS IN KITCHEN -INTERIOR GLAZING TO BE CHANNEL GLAZING NOT HM


CEILINGS: -ACT IN BACK OF HOUSE AREAS, LOCKER ROOMS & KITCHEN GENERAL -CLASSROOM LOCKERS 15"Wx12"Dx36"H W/ANGLED TOP – PHENOLIC W/PLAM FINISH AND WD


VENEER SIDES AND BACK -ATHLETIC / PE LOCKERS: 50 COUNT PER LOCKER ROOM - METAL 2 TIER 30"H. X 15"W X 15"D -ROLLER SHADE AT DOORS WITH LITES AND GLAZED PARTITIONS -ROLLER SHADE AT SOUTH EXTERIOR WINDOWS -MILLWORK PLAM - WD GRAIN PLAM FINISH -2"MAXXON TOPPING SLAB-ACOUSTIC AT FLOORS 2, 3, 4 TECH/ FIXTURES/ FURNISHINGS

ACADEMIC AREAS: -OPERABLE WINDOWS -LOW VOLUME DISPLACEMENT VENTILATION

-INDIRECT LED COVE LIGHTING -PAGING SYSTEM, WIRELESS DATA INTERCOM, CLOCK SYSTEM, -SOUND LIFT SYSTEM, WIRELESS ACCESS POINT, LED TOUCH SCREEN MONITOR


FIRST FLOOR GSF: 35,888 SF

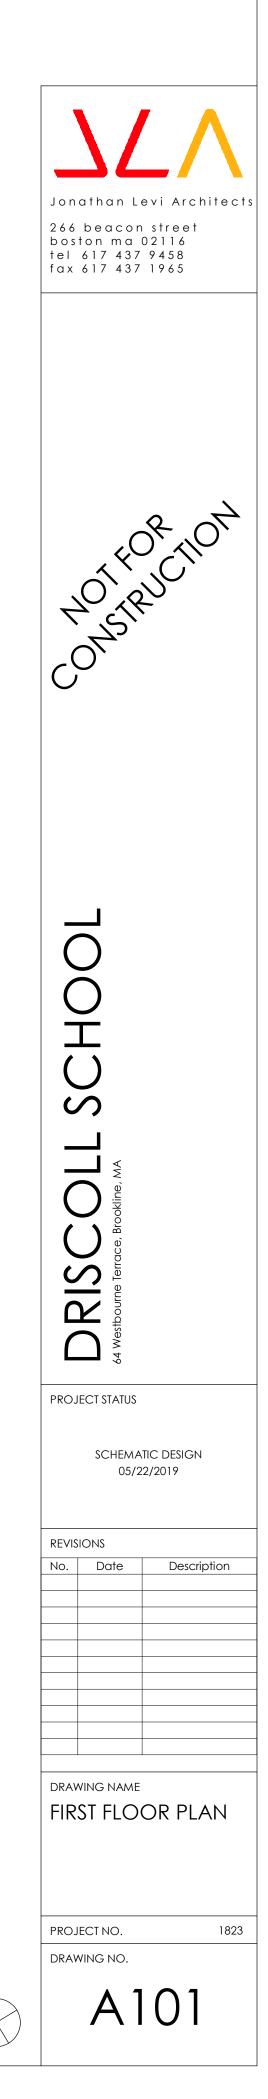

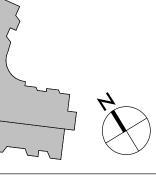







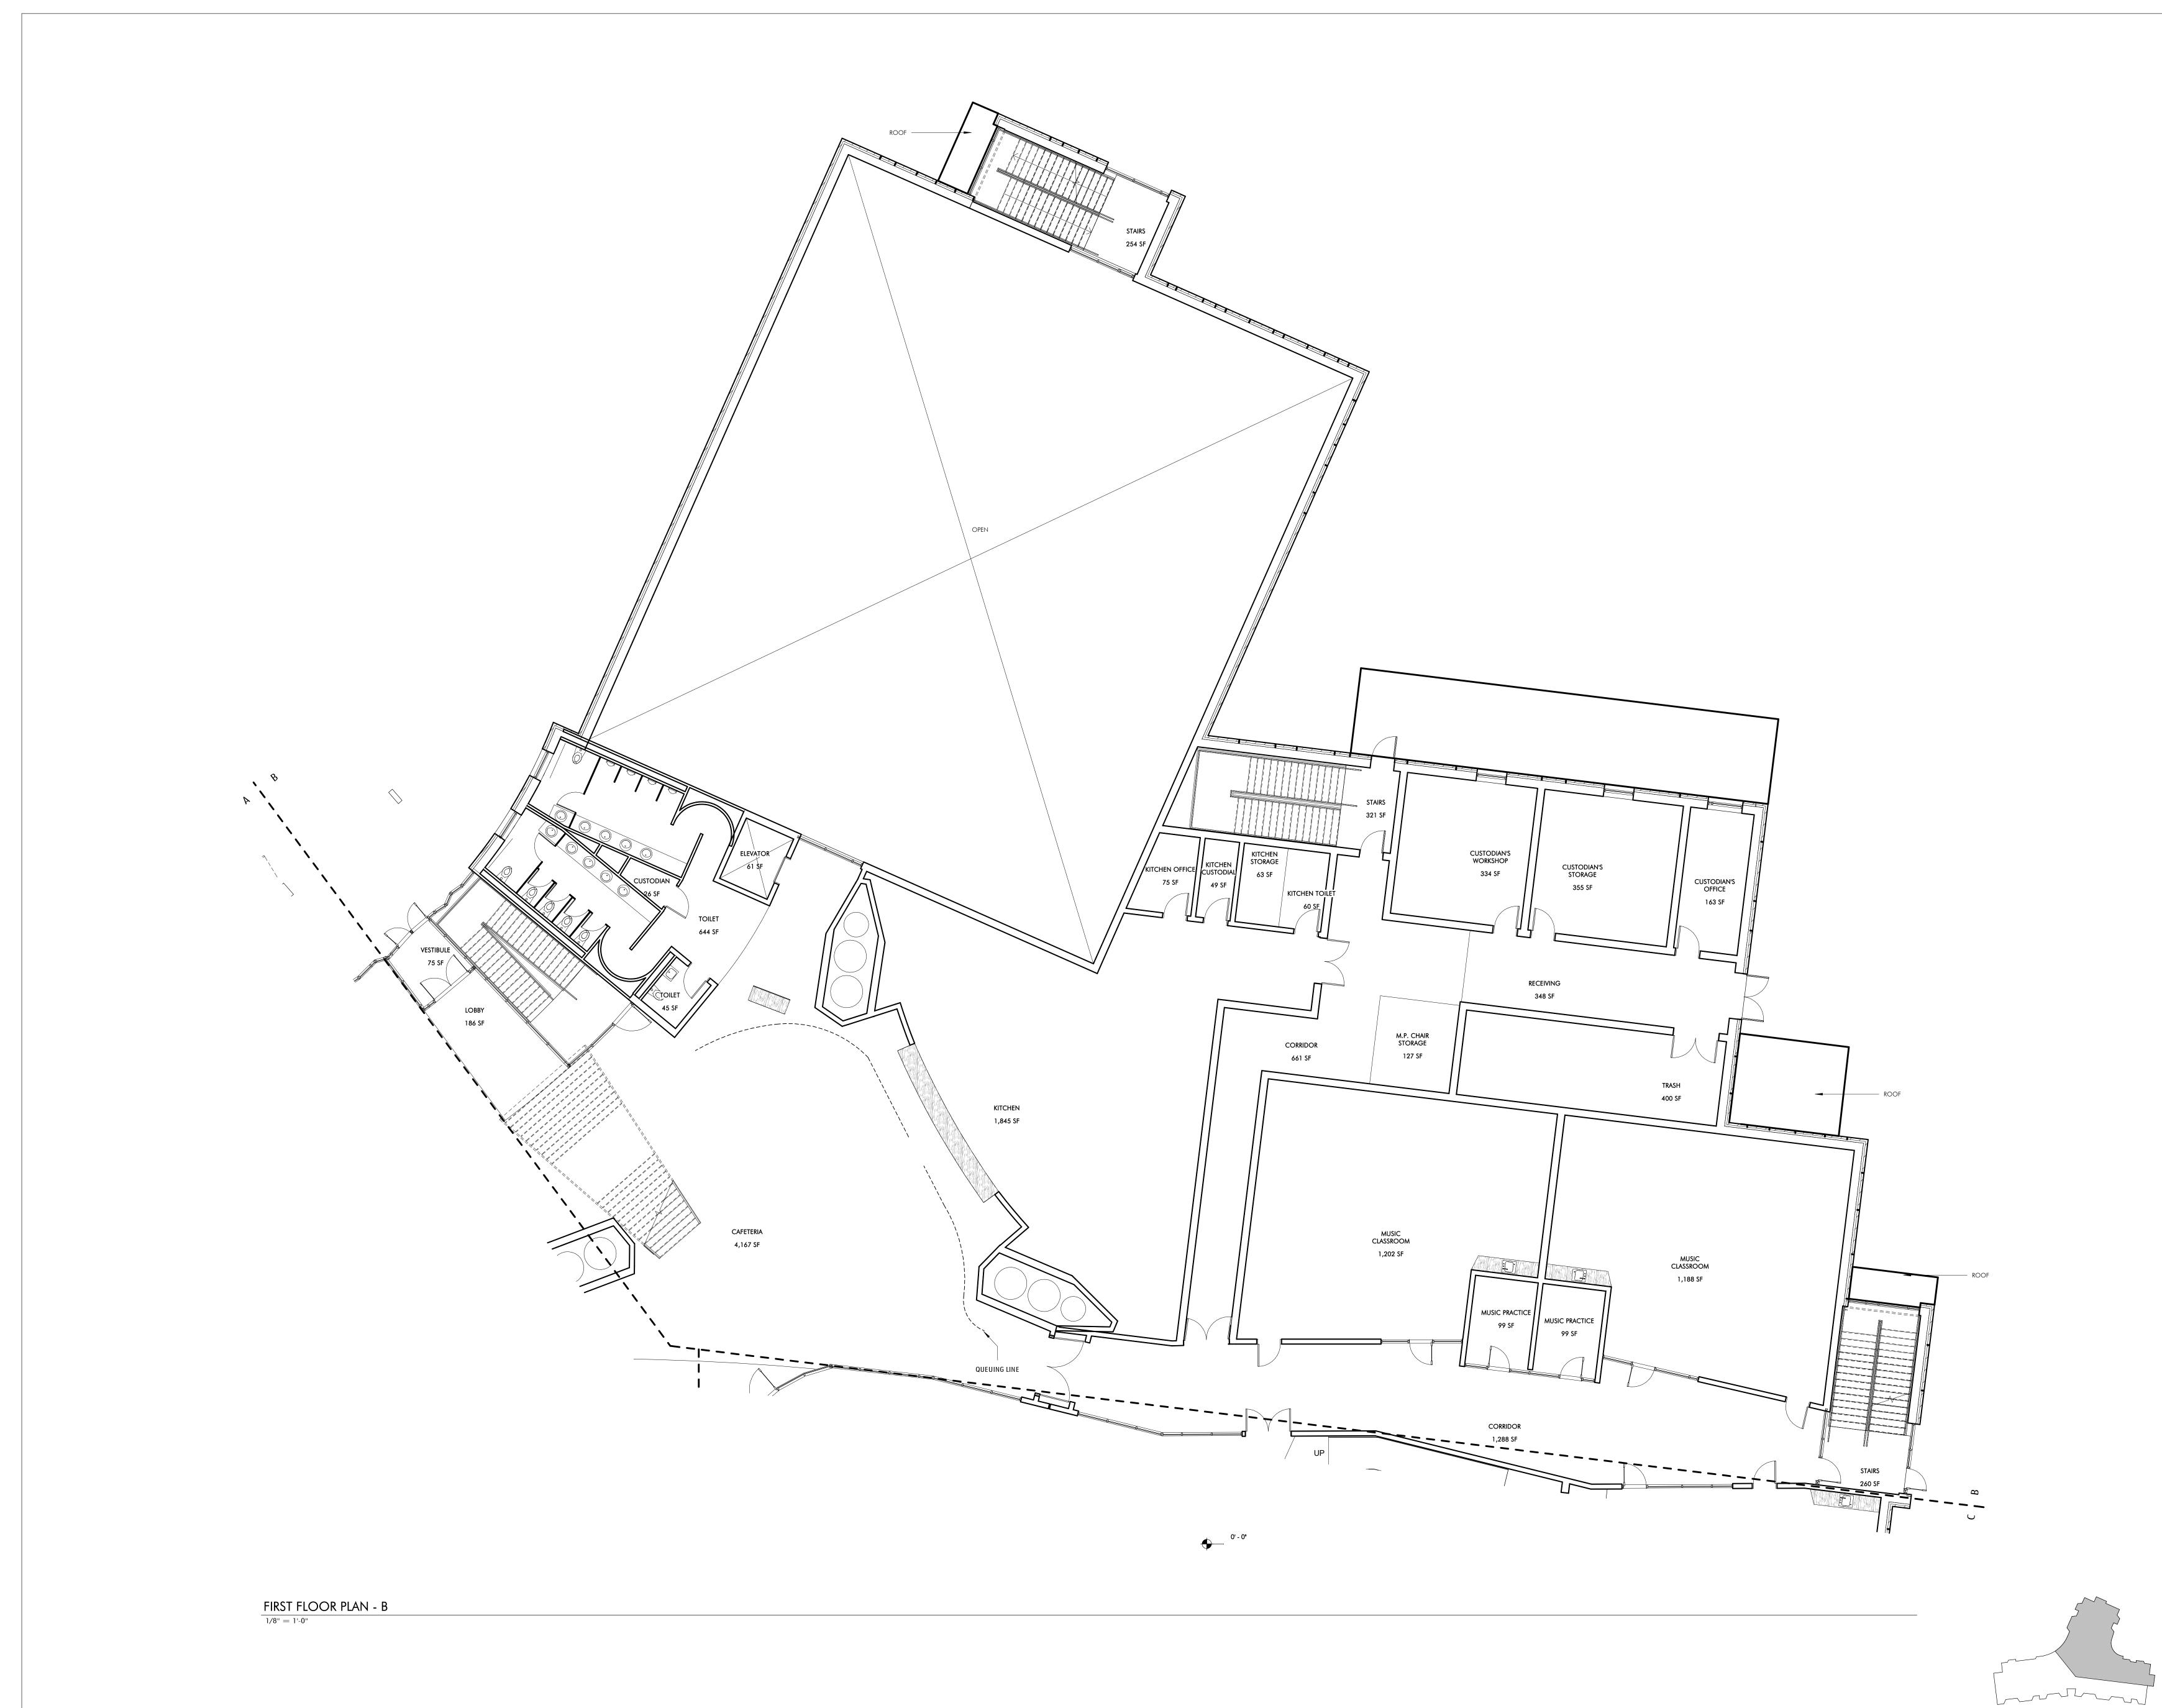




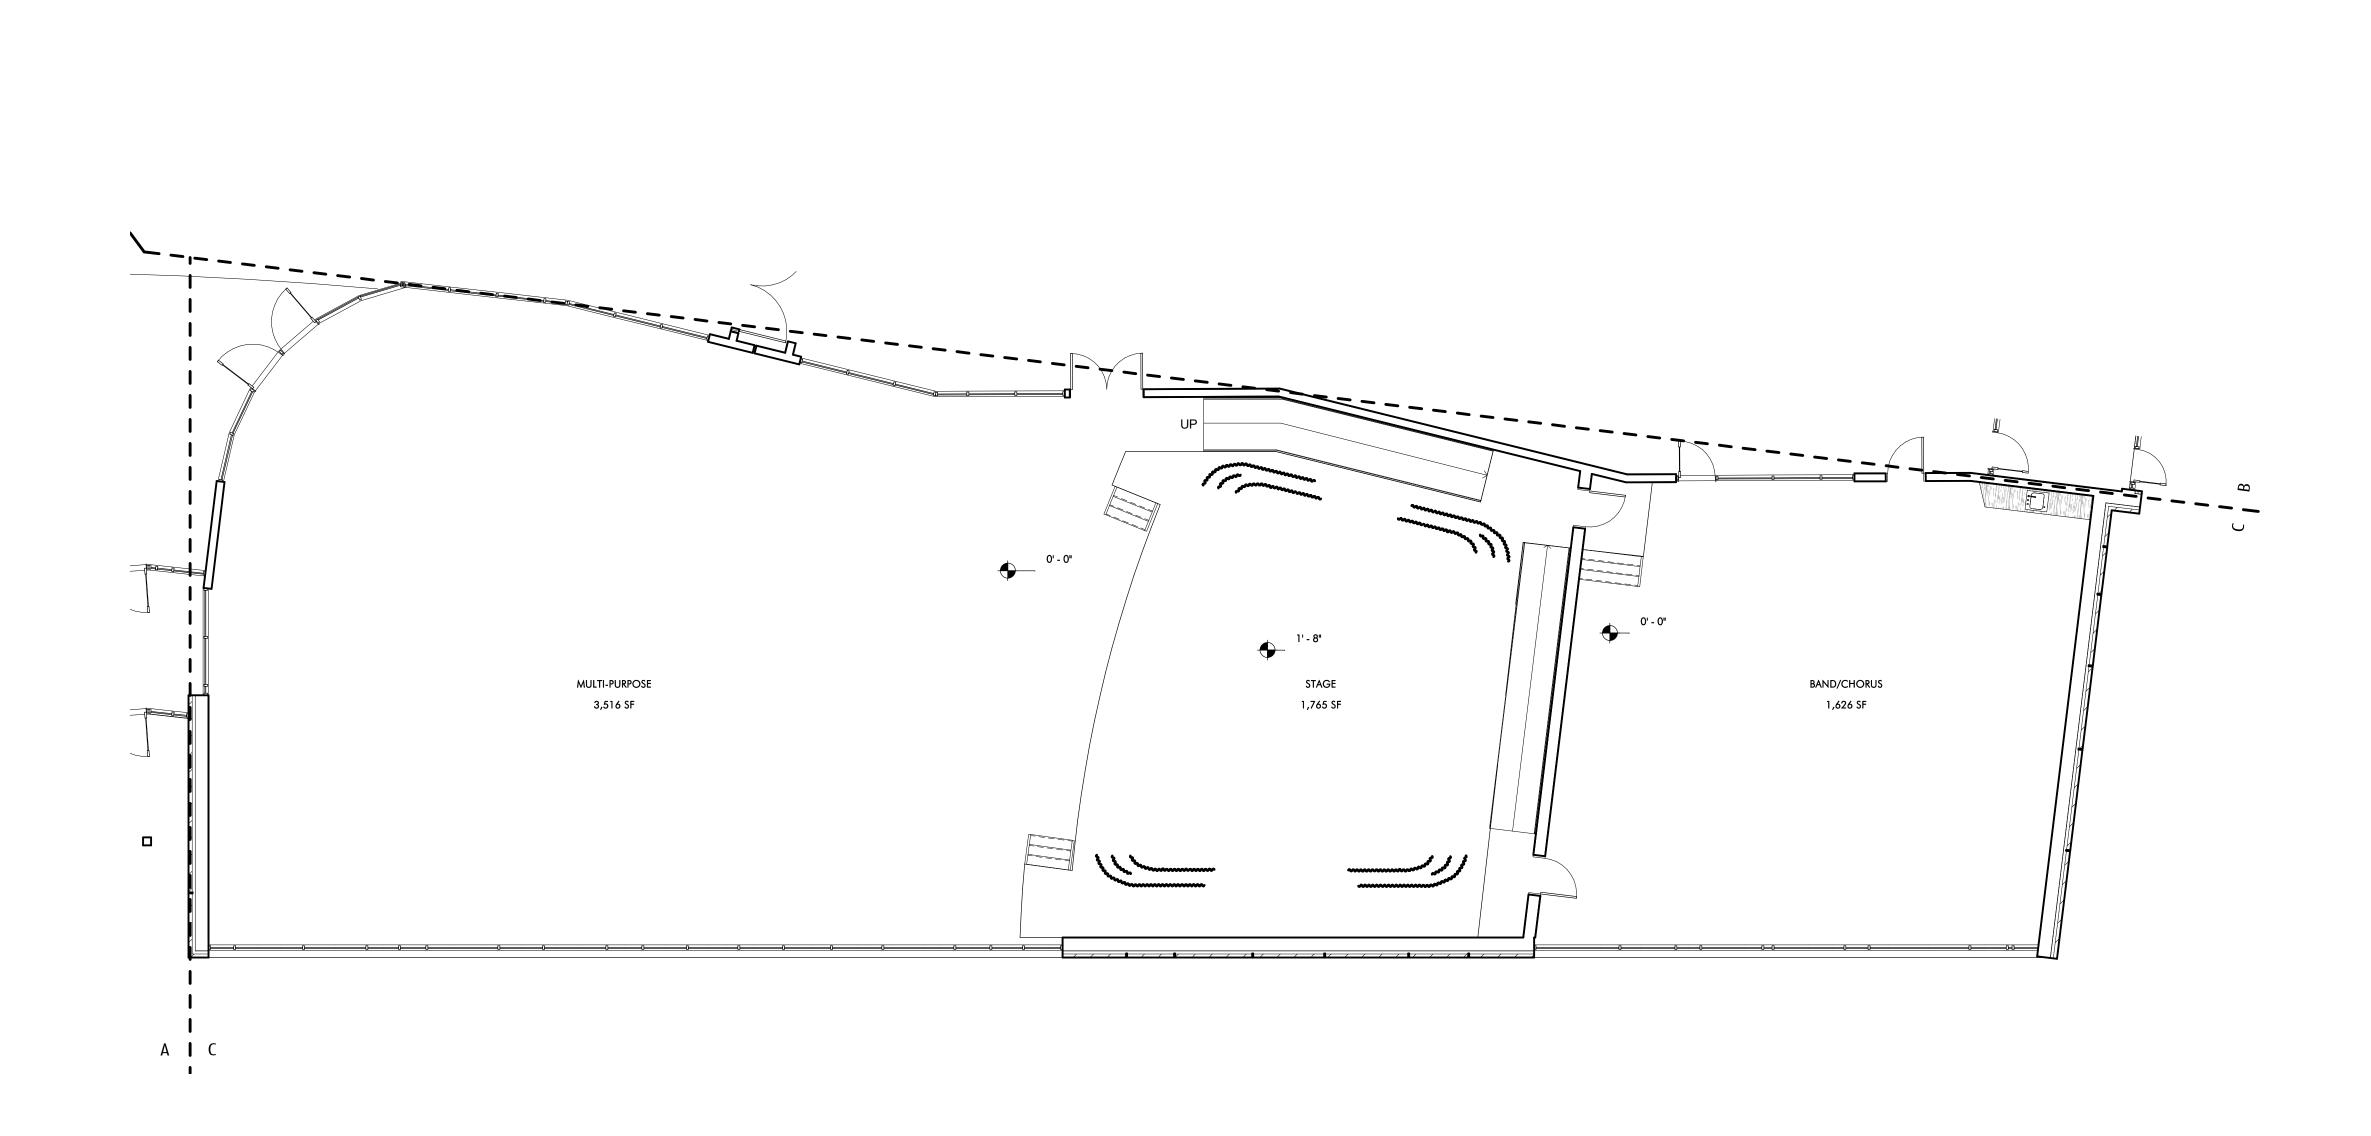

 $\frac{\text{FIRST FLOOR PLAN - C}}{1/8" = 1'-0"}$ 

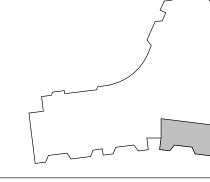

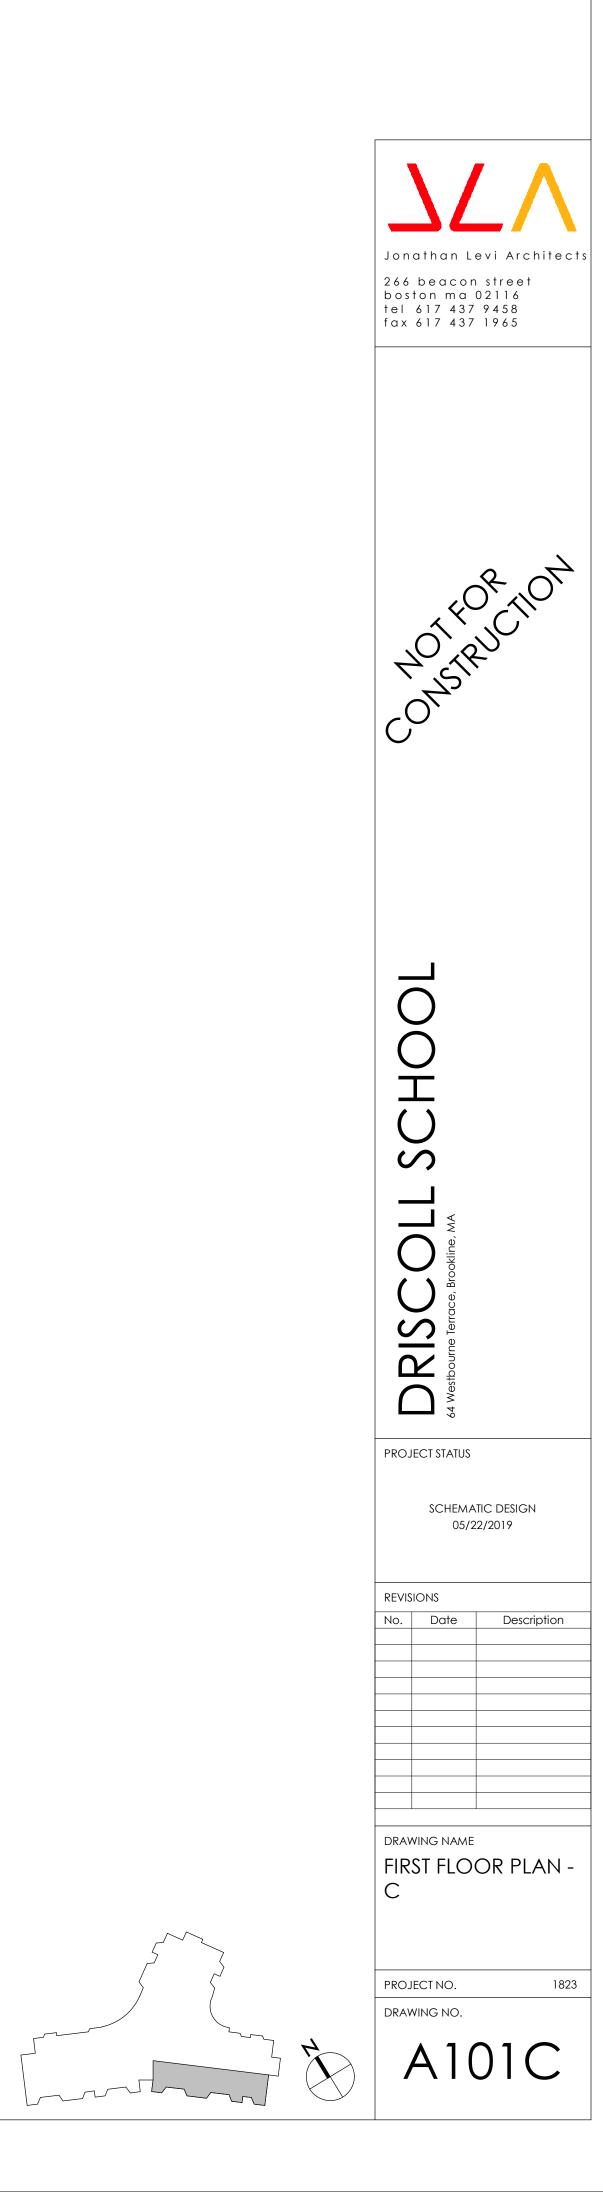



# FINISHES - INTEROR

WD EDGE

- CONCRETE PAVERS

- roof

SMALL GROUP ROOM

TERRACE

SMALL GROUP

------ CONCRETE STEPS TO SIDEWALK

6 A200

LAHB

-----

( A200 )

A300

A200)

ACADEMIC AREAS: CLASSROOMS, SCIENCE, MEDIA, ART, MUSIC, VOCATIONAL, SPED -FLOOR – 12" X 12" 1/3 RUNNING BOND VCT [TYP VCT B.O.D.: ARMSTRONG STONETEX] -BASE - 12" VCT WITH SCHLUTER TOP EDGE WHERE EXPOSED -LOWER WALL (30"-104") - MAGNETIC WRITABLE SURFACE WALL COVERING -UPPER WALL (104"-128") - PAINTED GWB -CURVED WALL- MAGNETIC WRITABLE SURFACE WALL COVERING OVER CURVED GWB PARTITION; -MARKER TRAY/BUMPER - SINGLE LAYER 3/4" P.LAM WITH HD WD TOP MARKER TRAY AND BOTTOM EDGE. -CEILING – EXPOSED DECK, PAINTED 2/3 OF ROOM; 1/3 – ACT LAY IN TILE WITH 1/3 RUNNING BOND GRID PATTERN AND GWB ANGLED SOFFIT. SUMMER BEAM AT EXPOSED DECK (LIGHT COVE AND

CEILING RETURN) - PLAM 4'-0" WIDE X 6" HIGH -MILLWORK AT TYP CLASSROOMS: 30" DEEP P.LAM COUNTER AT EXTERIOR WALL W/ EXPOSED BRACKETS, FLIP TOP AT WINDOW; MOBILE STORAGE-36"WX27"H (4) PER CLASSROOM; SHELVING AT EXTERIOR WALL-(4) ADJUSTABLE SHELVES-MELAMINE W/CUSTOM COLOR BRACKETS ON SURFACE STANDARDS W/BLOCKING AND 34" X 34" HD WD EDGE, FINISHED SHELF SIDE JAMB PANELS-PLAM ANGLED LIGHT REFLECTORS W/ 3/4" HD WD EDGES; FOLDING SCREEN - 6' X 8' X 2"THK FOLDING SCREEN AT CORRIDOR WALL, PLAM BOTH SIDES AND HD WD EDGES. -MILLWORK AT SCIENCE CLASSROOMS: 24" COUNTERS AND 24" HIGH BACKSPLASH-SOLID EPOXY ON EXPOSED BRACKETS; MOBILE STORAGE- 36"WX27"H (6) PER CLASSROOM; PLAM UPPER CABINETS ABOVE COUNTERS -OPERABLE PARITIONS BETWEEN CLASSROOM PAIR, MAGNETIC WRITABLE SURFACE BOTH SIDES - DOOR - 36"X102" BIRCH FULL LITE SOLID CORE WITH HOLLOW METAL FRAME TEACHER PLANNING [TP] ROOMS : -FLOOR – 12" X 12" 1/3 RUNNING BOND VCT

-BASE - 12" VCT WITH SCHLUTER TOP EDGE -CEILING-ACT LAY IN TILE IN 1/3 RUNNING BOND GRID PATTERN -MILLWORK: PLAM COUNTERS W/ 3" HD WD EDGE AND CONCEALED STEEL BRACKETS; REAR WALL SHELVING-FULL WIDTH-(5) ADJUSTABLE SHELVES-MELAMINE W/CUSTOM COLOR BRACKETS ON SURFACE STANDARDS W/BLOCKING AND 34" X 34" HD WD EDGE - DOOR TO CORRIDOR - 36"X102" BIRCH FULL LITE SOLID CORE WITH SLIDING BARN-DOOR HDWARE

MUSIC AREAS : -WALLS AT PRACTICE ROOMS AND DOUBLE HIGH BAND SPACE - FABRIC WRAPPED ACOUSTIC PANELS -CEILING- ACT LAY IN TILE 1/3 RUNNING BOND [B.O.D. – ARMSTRONG ULTIMA], 3 DIMENSIONAL METAL PANEL CEILING AT BAND/CHORUS [B.O.D. USG GEOMETRIX] CORRIDORS AND PUBLIC AREAS: -FLOOR – 12" X 12" 1/3 RUNNING BOND VCT, ACCENT COLORS AT COHORT COMMONS

-BASE - 12" VCT WITH SCHLUTER TOP EDGE WHERE EXPOSED -WALLS- PLAM PANEL W/ FINISHED EDGES 12"-106" HIGH ON 1/4" SUBSTRATE OVER GWB PARTITION. -FLOORS- 12" X 12" 1/3 RUNNING BOND VCT TILE -CEILING AT CORRIDORS – SUSPENDED ACT LAY-IN 1/3 RUNNING BOND GRID PATTERN -INTERIOR GLAZING - (12"-104") HIGH ALL LOCATIONS 1/4" LAMINATED GLASS (ACOUSTIC - DOUBLE 1/2" LAMINATED), BUTT GLAZED, CHANNEL GLAZED TOP AND BOTTOM ABOVE 12" VCT KNEEWALL BASE. GRADIATED PATTERN GLAZING AT TEACHER PLANNING ROOMS. -MILLWORK- WD CANTELEVERED BENCHES AT CLASSROOM GLAZED PARTITIONS, CONCEALED STL BRACKETS -LOCKERS – SINGLE TIER 36" H X 15" W. X 15" PHENOLIC W/PLAM FACE LOCKERS ON 4" PLYWOOD AND VCT TILE BASE, WITH WD VENEER FINISH PANELS AT SIDES AND BACK, ANGLED P.LAM TOP WITH INTERMITTANT ANGLED LAM. GL. DISPLAY CABINETS - ACTS AS GUARDRAIL. AT FLOORS 2 AND 3. - DOOR - 36"X102" BIRCH SOLID CORE WITH HOLLOW METAL FRAME

ADMINISTRATION AREAS, OFFICES, MEDICAL: -FLOOR – 12" X 12" 1/3 RUNNING BOND VCT [TYP VCT B.O.D.: ARMSTRONG STONETEX] -BASE - 12" VCT WITH SCHLUTER TOP EDGE WHERE EXPOSED -WALLS- PTD GWB -CEILING AT CORRIDORS - SUSPENDED ACT LAY-IN 1/3 RUNNING BOND GRID PATTERN [B.O.D. ARMSTRONG OPTIMA] -MILLWORK- PLAM CUSTOM BASE & UPPER CABINETS W/ ADJUSATBLE SHELVING, PLAM COUNTER W/HD WD EDGE; TACKABLE SURFACE BACKSPLASH; (5) ADJUSTABLE SHELVES AT OFFICES (TYP)-MELAMINE W/CUSTOM COLOR BRACKETS ON SURFACE STANDARDS W/BLOCKING AND 34" X 34" HD AUDITORIUM: -WALLS – 50% ACOUSTIC WOOD WALL SYSTEM [ARMSTRONG WOODWORKS], 50% GROUND FACED BLOCI -FLOOR - CARPET AT AISLES, SLAB ON GRADE POWER TROWELED CONCRETE AT SEATS (SLAB IS SLOPED AT SEATING AREA) -CEILING -PTD. EXPOSED METAL DECK WITH 50% SUSPENDED WOOD PANEL CEILING (ARMSTRONG WOODWORKS) -3' & 6' DIAMETER DOUBLE DOME ACRYLIC BUBBLE SKYLIGHT -FLOOR MOUNTED FOLD UP AUDITORIUM SEATING (420 SEATS)

#### GYM: -FLOOR - WOOD ATHLETIC FLOORING -BASE- VENTED RUBBER BASE

-WALLS - GYM WALL PADS TO BE 8'-8" A.F.F. EXCEPT BEHIND BLEACHERS, PRE-ENGINEERED STANDARD FINISH EVERYWHERE ELSE -CEILING – SUSPENDED LAY IN PRE PAINTED TEGULAR EDGE TECTUM PLANK AND EXPOSED DECK, -BLEACHERS- TELESCOPING, WALL MOUNTED, MOTORIZED FOR UP TO 750 SEATS TOILET ROOMS:

#### -FLOOR- PORCELAIN TILE -BASE- METAL COVE BASE

-WALLS TO 98"- CERAMIC TILE, W/ ACCENT COLOR. PTD GWB ABOVE W/HIGH PERFORMANCE COATING -CEILING-PTD W/HIGH PERFORMANCE COATING -MILLWORK- SOLID SURFACE COUNTERS WITH CONCEALED STEEL BRACKETS

### OTHER ROOMS:

FLOORS -QUARRY TILE AT KITCHEN. 1/3 RUNNING BOND -SEALED CONCRETE AT BACK OF HOUSE -STAIRS - VCT TREADS & RISERS WITH RUBBER NOSING, VCT TILE AT LANDINGS

WALLS -FIBER REINFORCED PANELS IN KITCHEN -INTERIOR GLAZING TO BE CHANNEL GLAZING NOT HM

CEILINGS: -ACT IN BACK OF HOUSE AREAS, LOCKER ROOMS & KITCHEN


GENERA -CLASSROOM LOCKERS 15"Wx12"Dx36"H W/ANGLED TOP – PHENOLIC W/PLAM FINISH AND WD VENEER SIDES AND BACK -ATHLETIC / PE LOCKERS: 50 COUNT PER LOCKER ROOM - METAL 2 TIER 30"H. X 15"W X 15"D -ROLLER SHADE AT DOORS WITH LITES AND GLAZED PARTITIONS -ROLLER SHADE AT SOUTH EXTERIOR WINDOWS -MILLWORK PLAM – WD GRAIN PLAM FINISH -2"MAXXON TOPPING SLAB-ACOUSTIC AT FLOORS 2, 3, 4


TECH/ FIXTURES/ FURNISHINGS

ACADEMIC AREAS: -OPERABLE WINDOWS -LOW VOLUME DISPLACEMENT VENTILATION

-INDIRECT LED COVE LIGHTING -PAGING SYSTEM, WIRELESS DATA INTERCOM, CLOCK SYSTEM, -SOUND LIFT SYSTEM, WIRELESS ACCESS POINT, LED TOUCH SCREEN MONITOR

SECOND FLOOR GSF: 31,900 SF

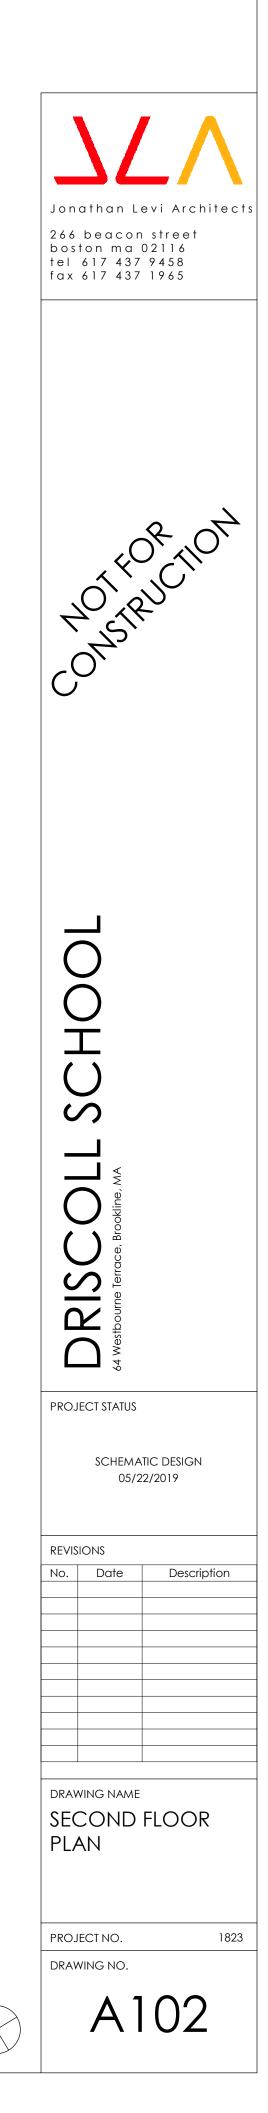

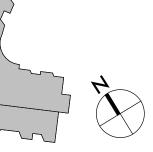

# $\frac{\text{SECOND FLOOR PLAN - A}}{1/8" = 1'-0"}$





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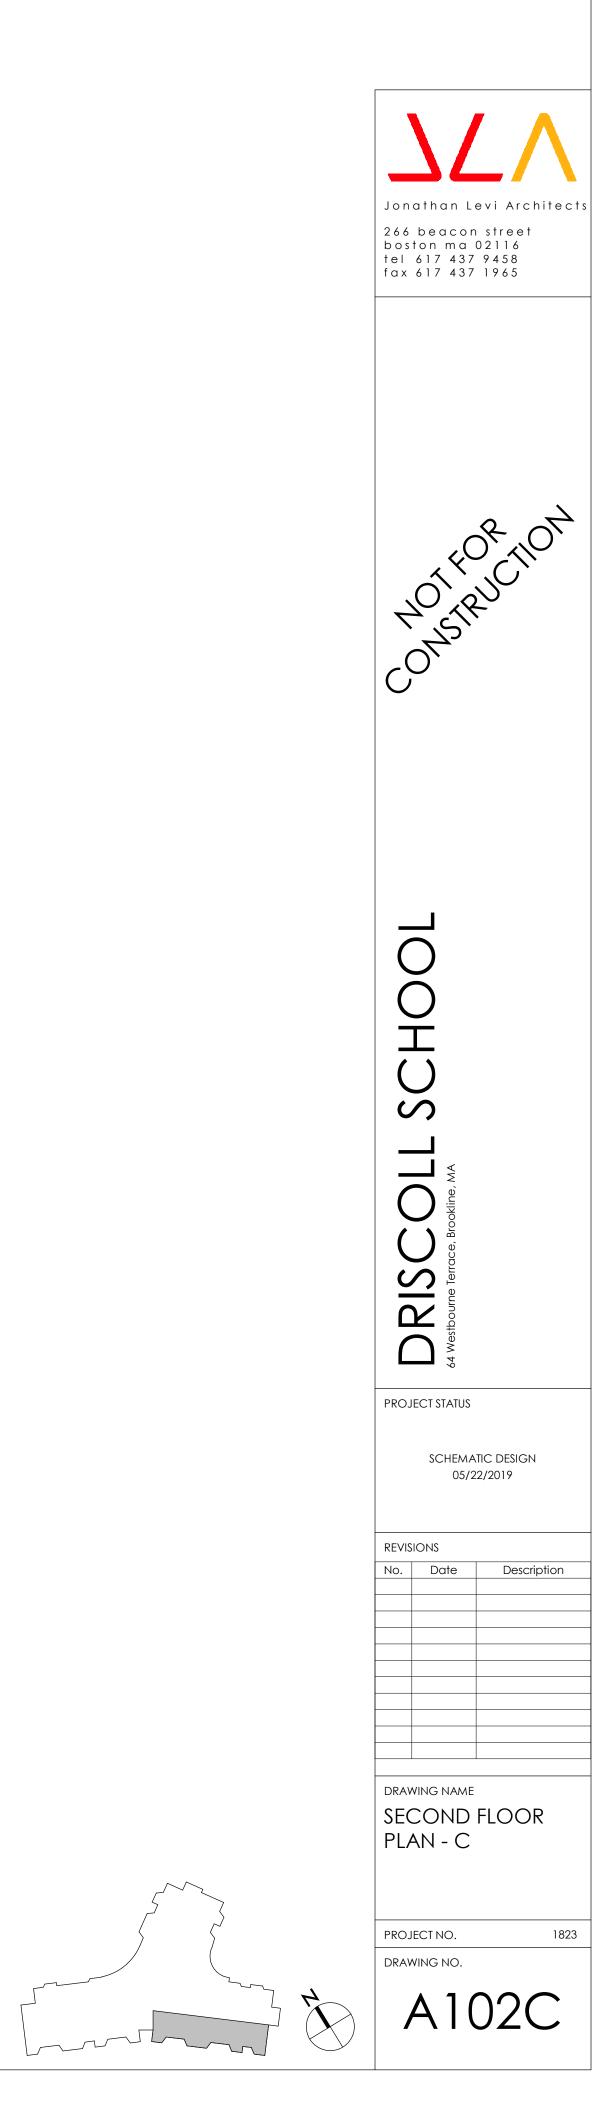









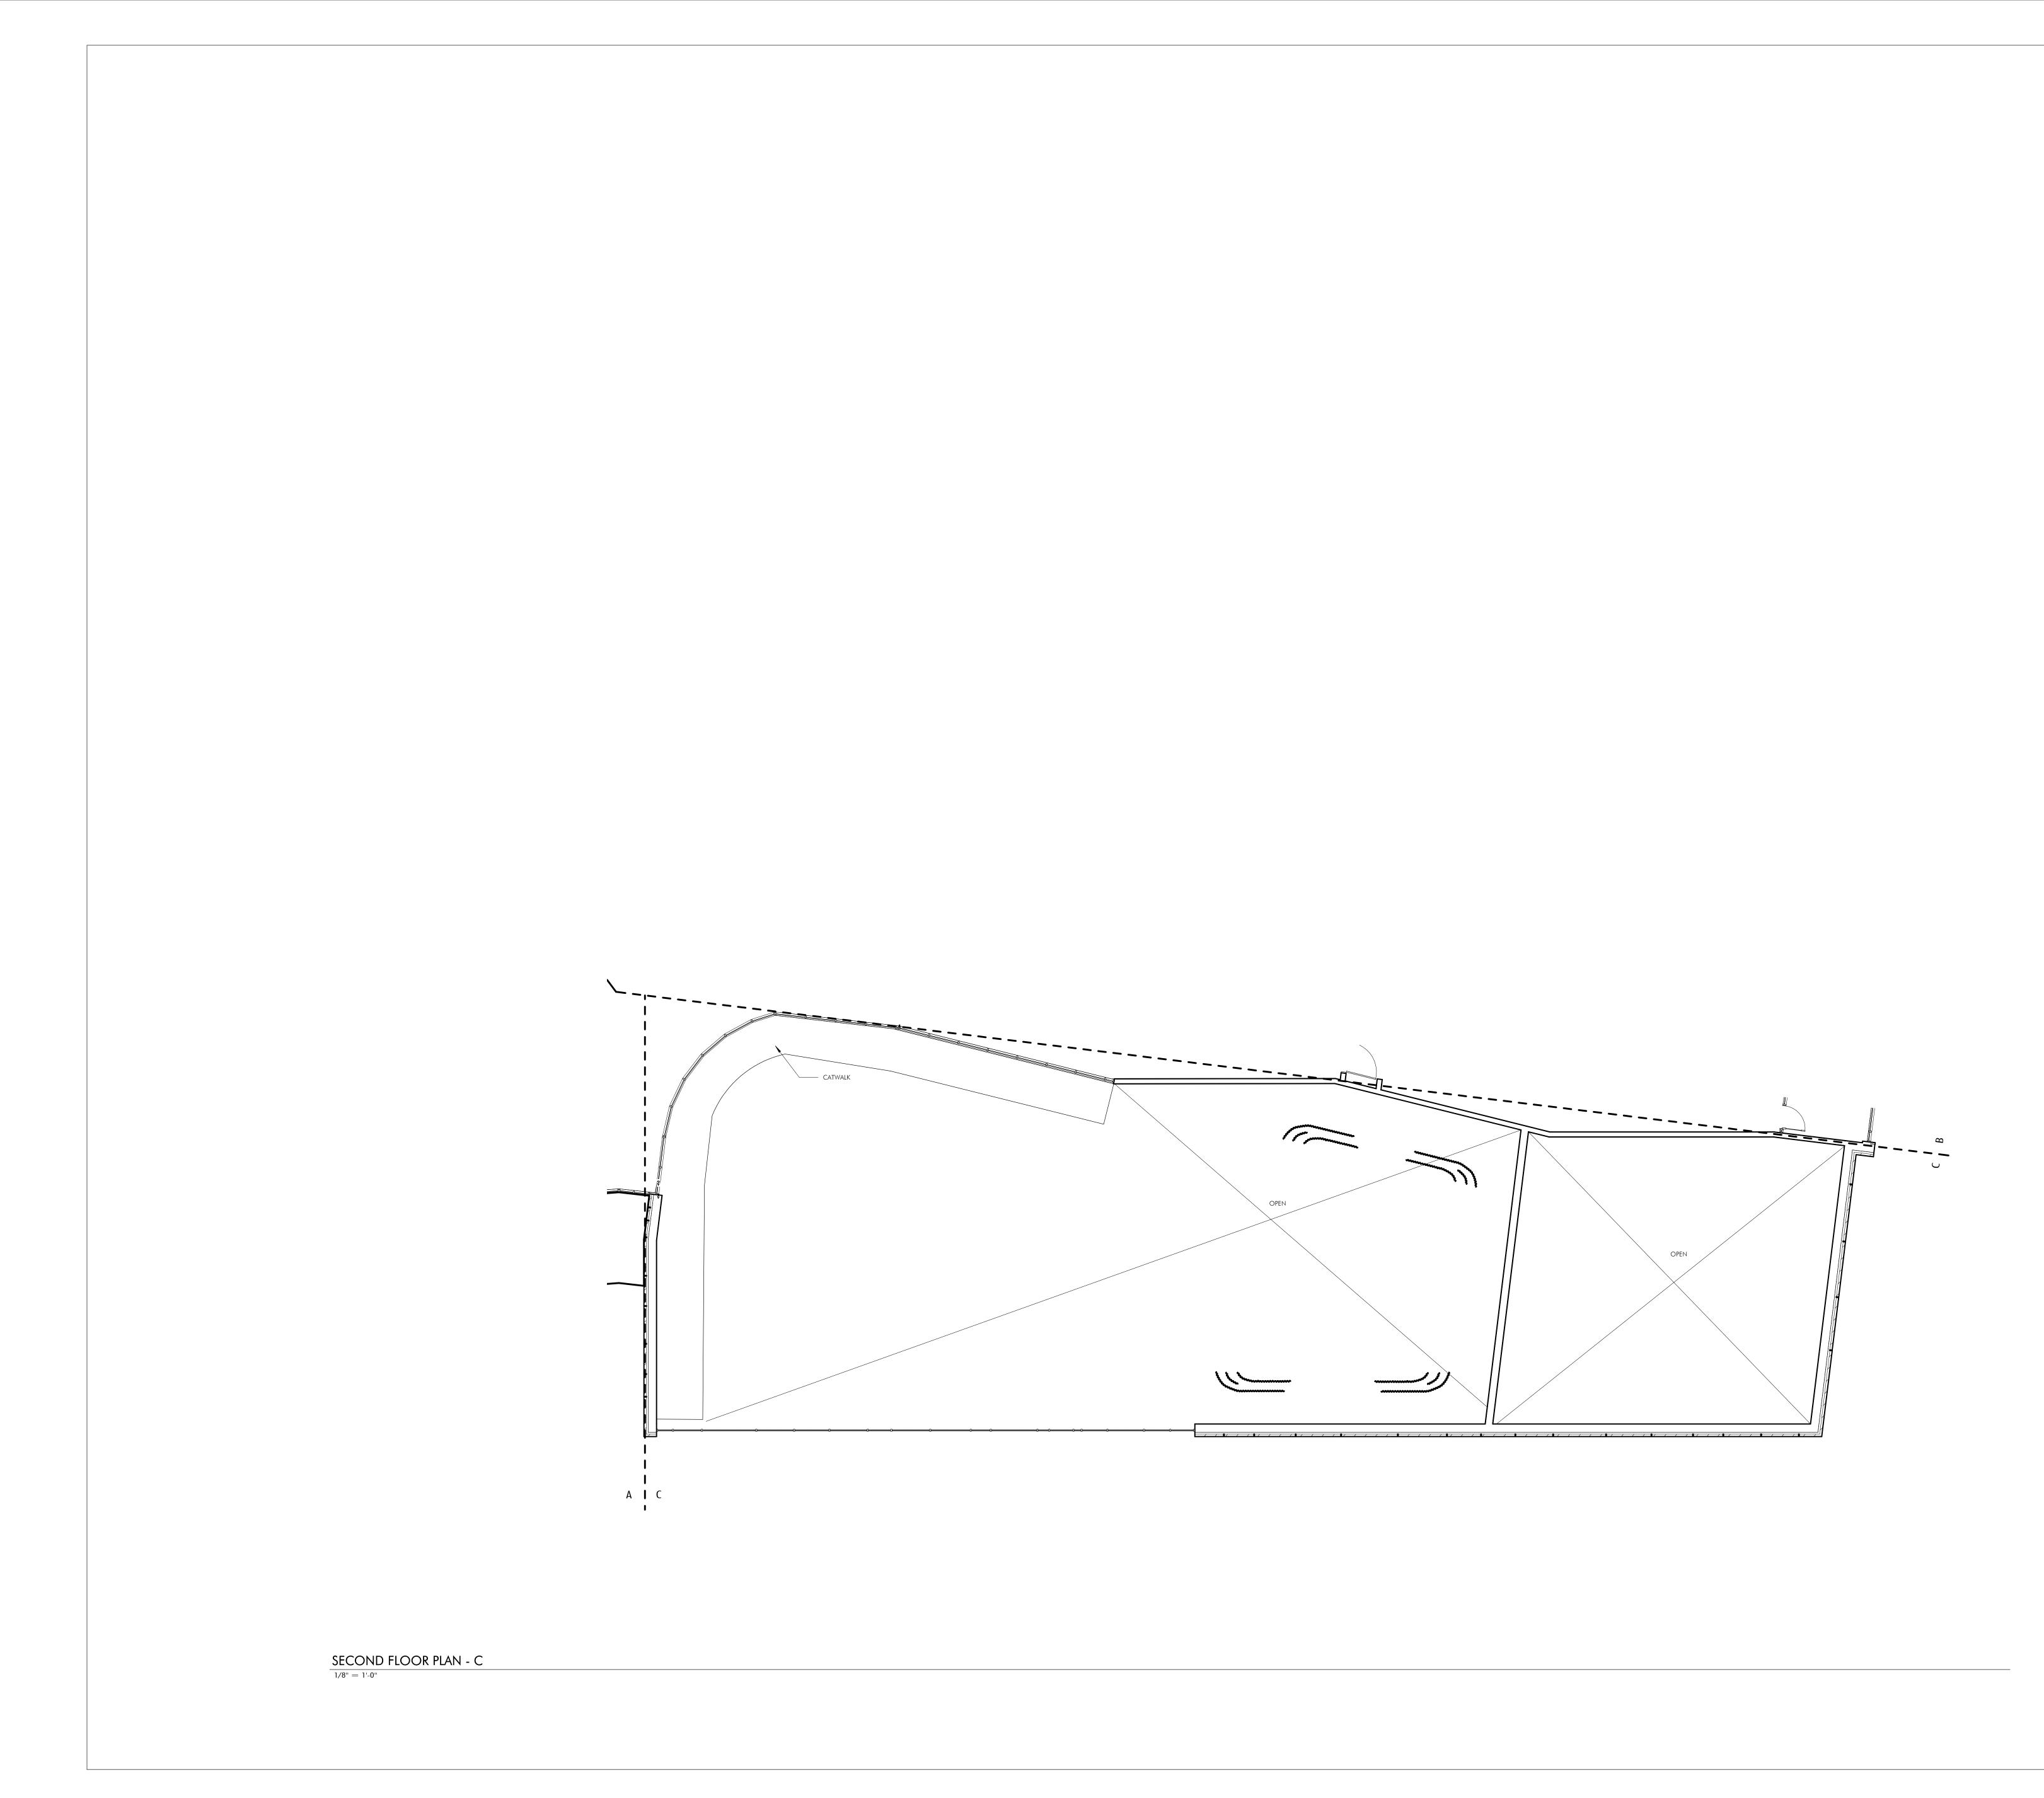

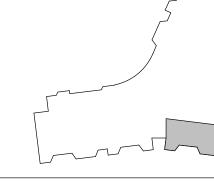



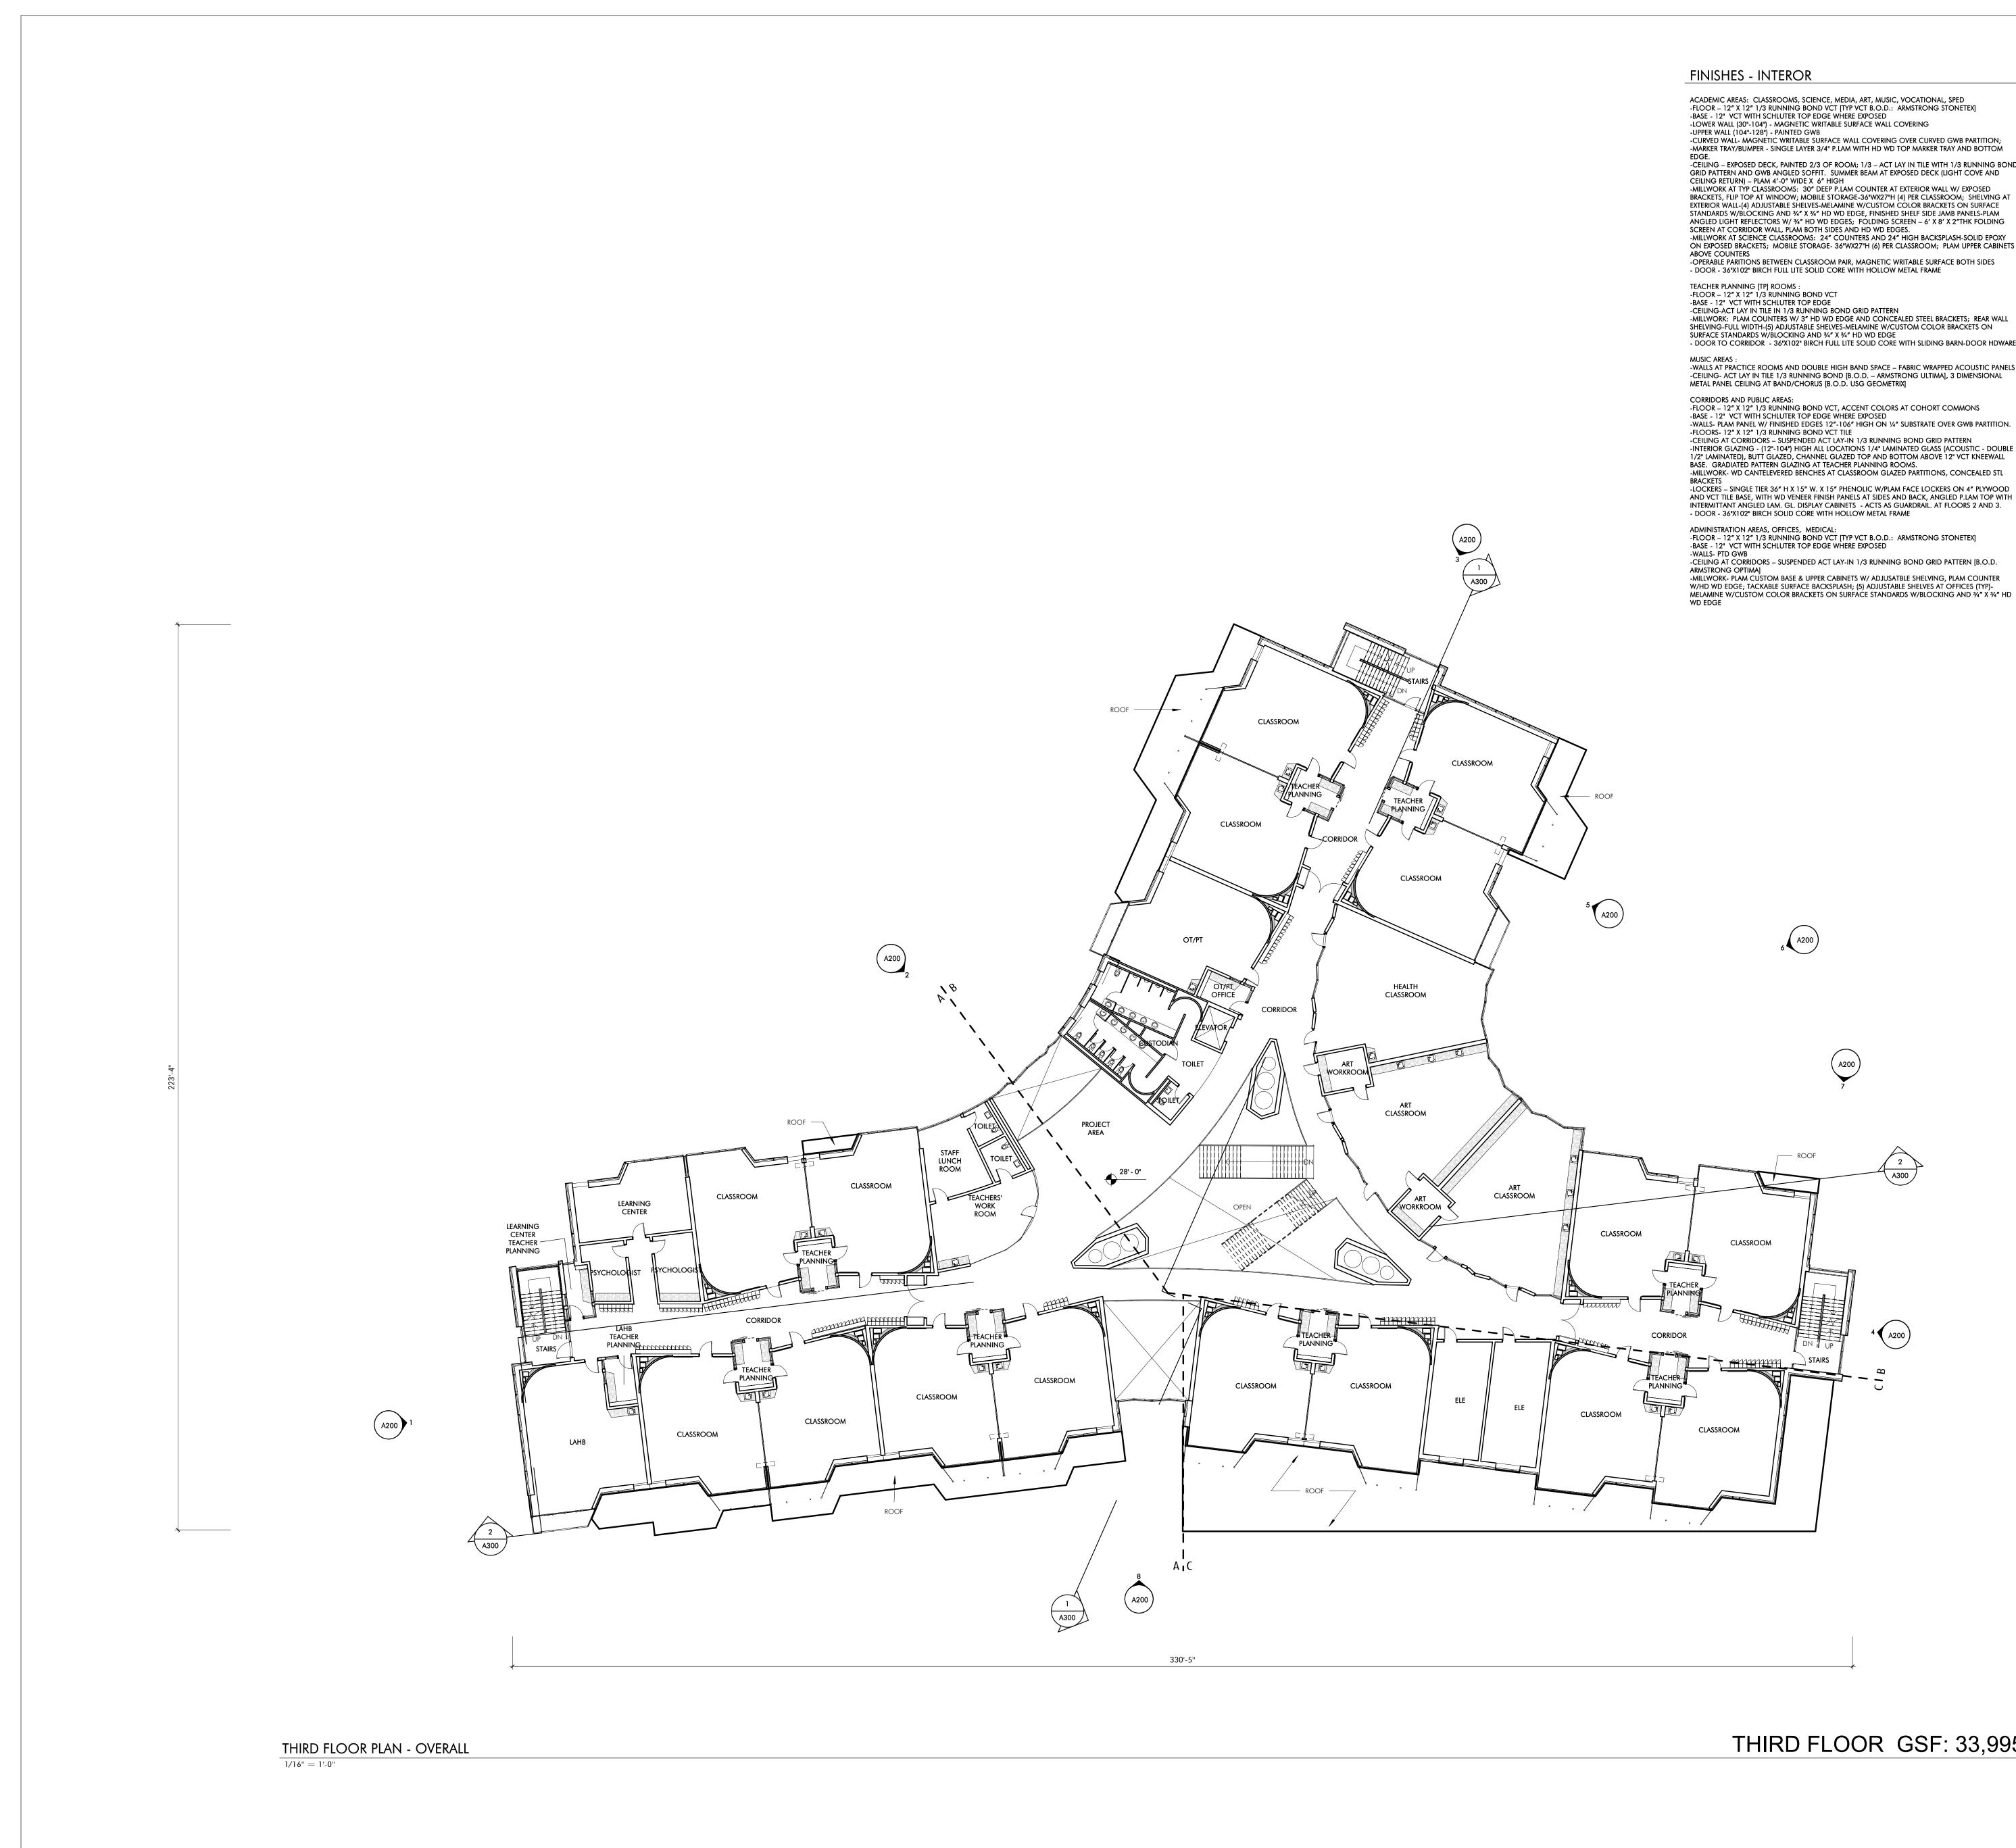

# ACADEMIC AREAS: CLASSROOMS, SCIENCE, MEDIA, ART, MUSIC, VOCATIONAL, SPED -FLOOR – 12" X 12" 1/3 RUNNING BOND VCT [TYP VCT B.O.D.: ARMSTRONG STONETEX]

-CURVED WALL- MAGNETIC WRITABLE SURFACE WALL COVERING OVER CURVED GWB PARTITION; -MARKER TRAY/BUMPER - SINGLE LAYER 3/4" P.LAM WITH HD WD TOP MARKER TRAY AND BOTTOM -CEILING – EXPOSED DECK, PAINTED 2/3 OF ROOM; 1/3 – ACT LAY IN TILE WITH 1/3 RUNNING BOND GRID PATTERN AND GWB ANGLED SOFFIT. SUMMER BEAM AT EXPOSED DECK (LIGHT COVE AND

BRACKETS, FLIP TOP AT WINDOW; MOBILE STORAGE-36"WX27"H (4) PER CLASSROOM; SHELVING AT EXTERIOR WALL-(4) ADJUSTABLE SHELVES-MELAMINE W/CUSTOM COLOR BRACKETS ON SURFACE STANDARDS W/BLOCKING AND ¾" X ¾" HD WD EDGE, FINISHED SHELF SIDE JAMB PANELS-PLAM ANGLED LIGHT REFLECTORS W/ 3/4" HD WD EDGES; FOLDING SCREEN - 6' X 8' X 2"THK FOLDING -MILLWORK AT SCIENCE CLASSROOMS: 24" COUNTERS AND 24" HIGH BACKSPLASH-SOLID EPOXY ON EXPOSED BRACKETS; MOBILE STORAGE- 36"WX27"H (6) PER CLASSROOM; PLAM UPPER CABINETS -OPERABLE PARITIONS BETWEEN CLASSROOM PAIR, MAGNETIC WRITABLE SURFACE BOTH SIDES - DOOR - 36"X102" BIRCH FULL LITE SOLID CORE WITH HOLLOW METAL FRAME

SHELVING-FULL WIDTH-(5) ADJUSTABLE SHELVES-MELAMINE W/CUSTOM COLOR BRACKETS ON - DOOR TO CORRIDOR - 36"X102" BIRCH FULL LITE SOLID CORE WITH SLIDING BARN-DOOR HDWARE

-WALLS AT PRACTICE ROOMS AND DOUBLE HIGH BAND SPACE – FABRIC WRAPPED ACOUSTIC PANELS -CEILING- ACT LAY IN TILE 1/3 RUNNING BOND [B.O.D. – ARMSTRONG ULTIMA], 3 DIMENSIONAL

-FLOOR – 12" X 12" 1/3 RUNNING BOND VCT, ACCENT COLORS AT COHORT COMMONS -BASE - 12" VCT WITH SCHLUTER TOP EDGE WHERE EXPOSED -WALLS- PLAM PANEL W/ FINISHED EDGES 12"-106" HIGH ON 1/4" SUBSTRATE OVER GWB PARTITION. -CEILING AT CORRIDORS – SUSPENDED ACT LAY-IN 1/3 RUNNING BOND GRID PATTERN -INTERIOR GLAZING - (12"-104") HIGH ALL LOCATIONS 1/4" LAMINATED GLASS (ACOUSTIC - DOUBLE 1/2" LAMINATED), BUTT GLAZED, CHANNEL GLAZED TOP AND BOTTOM ABOVE 12" VCT KNEEWALL -MILLWORK- WD CANTELEVERED BENCHES AT CLASSROOM GLAZED PARTITIONS, CONCEALED STL -LOCKERS – SINGLE TIER 36" H X 15" W. X 15" PHENOLIC W/PLAM FACE LOCKERS ON 4" PLYWOOD AND VCT TILE BASE, WITH WD VENEER FINISH PANELS AT SIDES AND BACK, ANGLED P. LAM TOP WITH INTERMITTANT ANGLED LAM. GL. DISPLAY CABINETS - ACTS AS GUARDRAIL. AT FLOORS 2 AND 3.

-FLOOR – 12" X 12" 1/3 RUNNING BOND VCT [TYP VCT B.O.D.: ARMSTRONG STONETEX]

-MILLWORK- PLAM CUSTOM BASE & UPPER CABINETS W/ ADJUSATBLE SHELVING, PLAM COUNTER W/HD WD EDGE; TACKABLE SURFACE BACKSPLASH; (5) ADJUSTABLE SHELVES AT OFFICES (TYP)-

#### AUDITORIUM: -WALLS – 50% ACOUSTIC WOOD WALL SYSTEM [ARMSTRONG WOODWORKS], 50% GROUND FACED BLOCK -FLOOR - CARPET AT AISLES, SLAB ON GRADE POWER TROWELED CONCRETE AT SEATS (SLAB IS SLOPED AT SEATING AREA) -CEILING --PTD. EXPOSED METAL DECK WITH 50% SUSPENDED WOOD PANEL CEILING (ARMSTRONG WOODWORKS) -3' & 6' DIAMETER DOUBLE DOME ACRYLIC BUBBLE SKYLIGHT -FLOOR MOUNTED FOLD UP AUDITORIUM SEATING (420 SEATS)

#### GYM: -FLOOR - WOOD ATHLETIC FLOORING

-BASE- VENTED RUBBER BASE -WALLS - GYM WALL PADS TO BE 8'-8" A.F.F. EXCEPT BEHIND BLEACHERS, PRE-ENGINEERED STANDARD FINISH EVERYWHERE ELSE -CEILING - SUSPENDED LAY IN PRE PAINTED TEGULAR EDGE TECTUM PLANK AND EXPOSED DECK, -BLEACHERS- TELESCOPING, WALL MOUNTED, MOTORIZED FOR UP TO 750 SEATS TOILET ROOMS: -FLOOR- PORCELAIN TILE

## -BASE- METAL COVE BASE

-WALLS TO 98"- CERAMIC TILE, W/ ACCENT COLOR. PTD GWB ABOVE W/HIGH PERFORMANCE COATING -CEILING-PTD W/HIGH PERFORMANCE COATING -MILLWORK- SOLID SURFACE COUNTERS WITH CONCEALED STEEL BRACKETS

# OTHER ROOMS:

GENERA

FLOORS -QUARRY TILE AT KITCHEN. 1/3 RUNNING BOND -SEALED CONCRETE AT BACK OF HOUSE

#### WALLS -FIBER REINFORCED PANELS IN KITCHEN

-INTERIOR GLAZING TO BE CHANNEL GLAZING NOT HM CEILINGS

-ACT IN BACK OF HOUSE AREAS, LOCKER ROOMS & KITCHEN


-CLASSROOM LOCKERS 15"Wx12"Dx36"H W/ANGLED TOP – PHENOLIC W/PLAM FINISH AND WD VENEER SIDES AND BACK -ATHLETIC / PE LOCKERS: 50 COUNT PER LOCKER ROOM - METAL 2 TIER 30"H. X 15"W X 15"D -ROLLER SHADE AT DOORS WITH LITES AND GLAZED PARTITIONS -ROLLER SHADE AT SOUTH EXTERIOR WINDOWS -MILLWORK PLAM – WD GRAIN PLAM FINISH -2"MAXXON TOPPING SLAB-ACOUSTIC AT FLOORS 2, 3, 4


## TECH/ FIXTURES/ FURNISHINGS ACADEMIC AREAS: -OPERABLE WINDOWS

-LOW VOLUME DISPLACEMENT VENTILATION -INDIRECT LED COVE LIGHTING -PAGING SYSTEM, WIRELESS DATA INTERCOM, CLOCK SYSTEM, -SOUND LIFT SYSTEM, WIRELESS ACCESS POINT, LED TOUCH SCREEN MONITOR


THIRD FLOOR GSF: 33,995 SF


-STAIRS - VCT TREADS & RISERS WITH RUBBER NOSING, VCT TILE AT LANDINGS

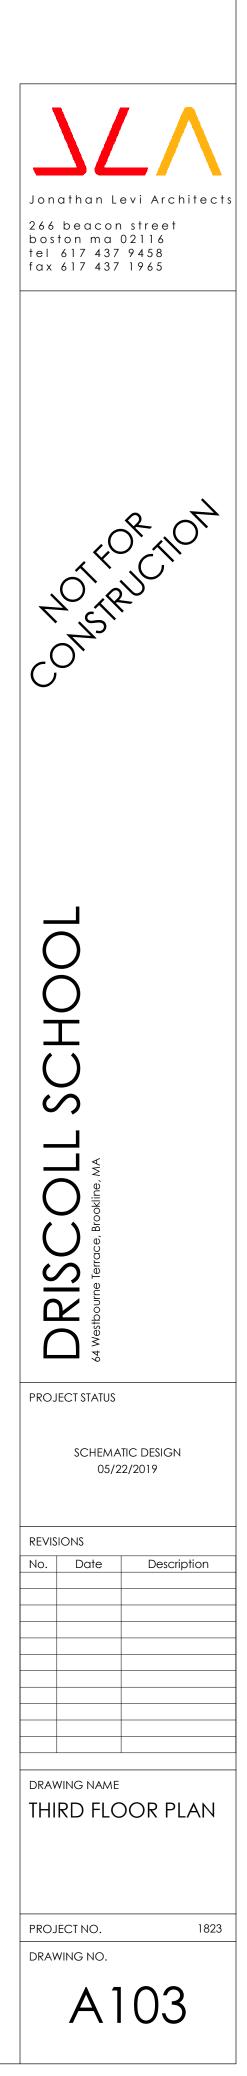

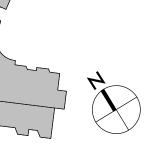


THIRD FLOOR PLAN - A 1/8" = 1'-0"

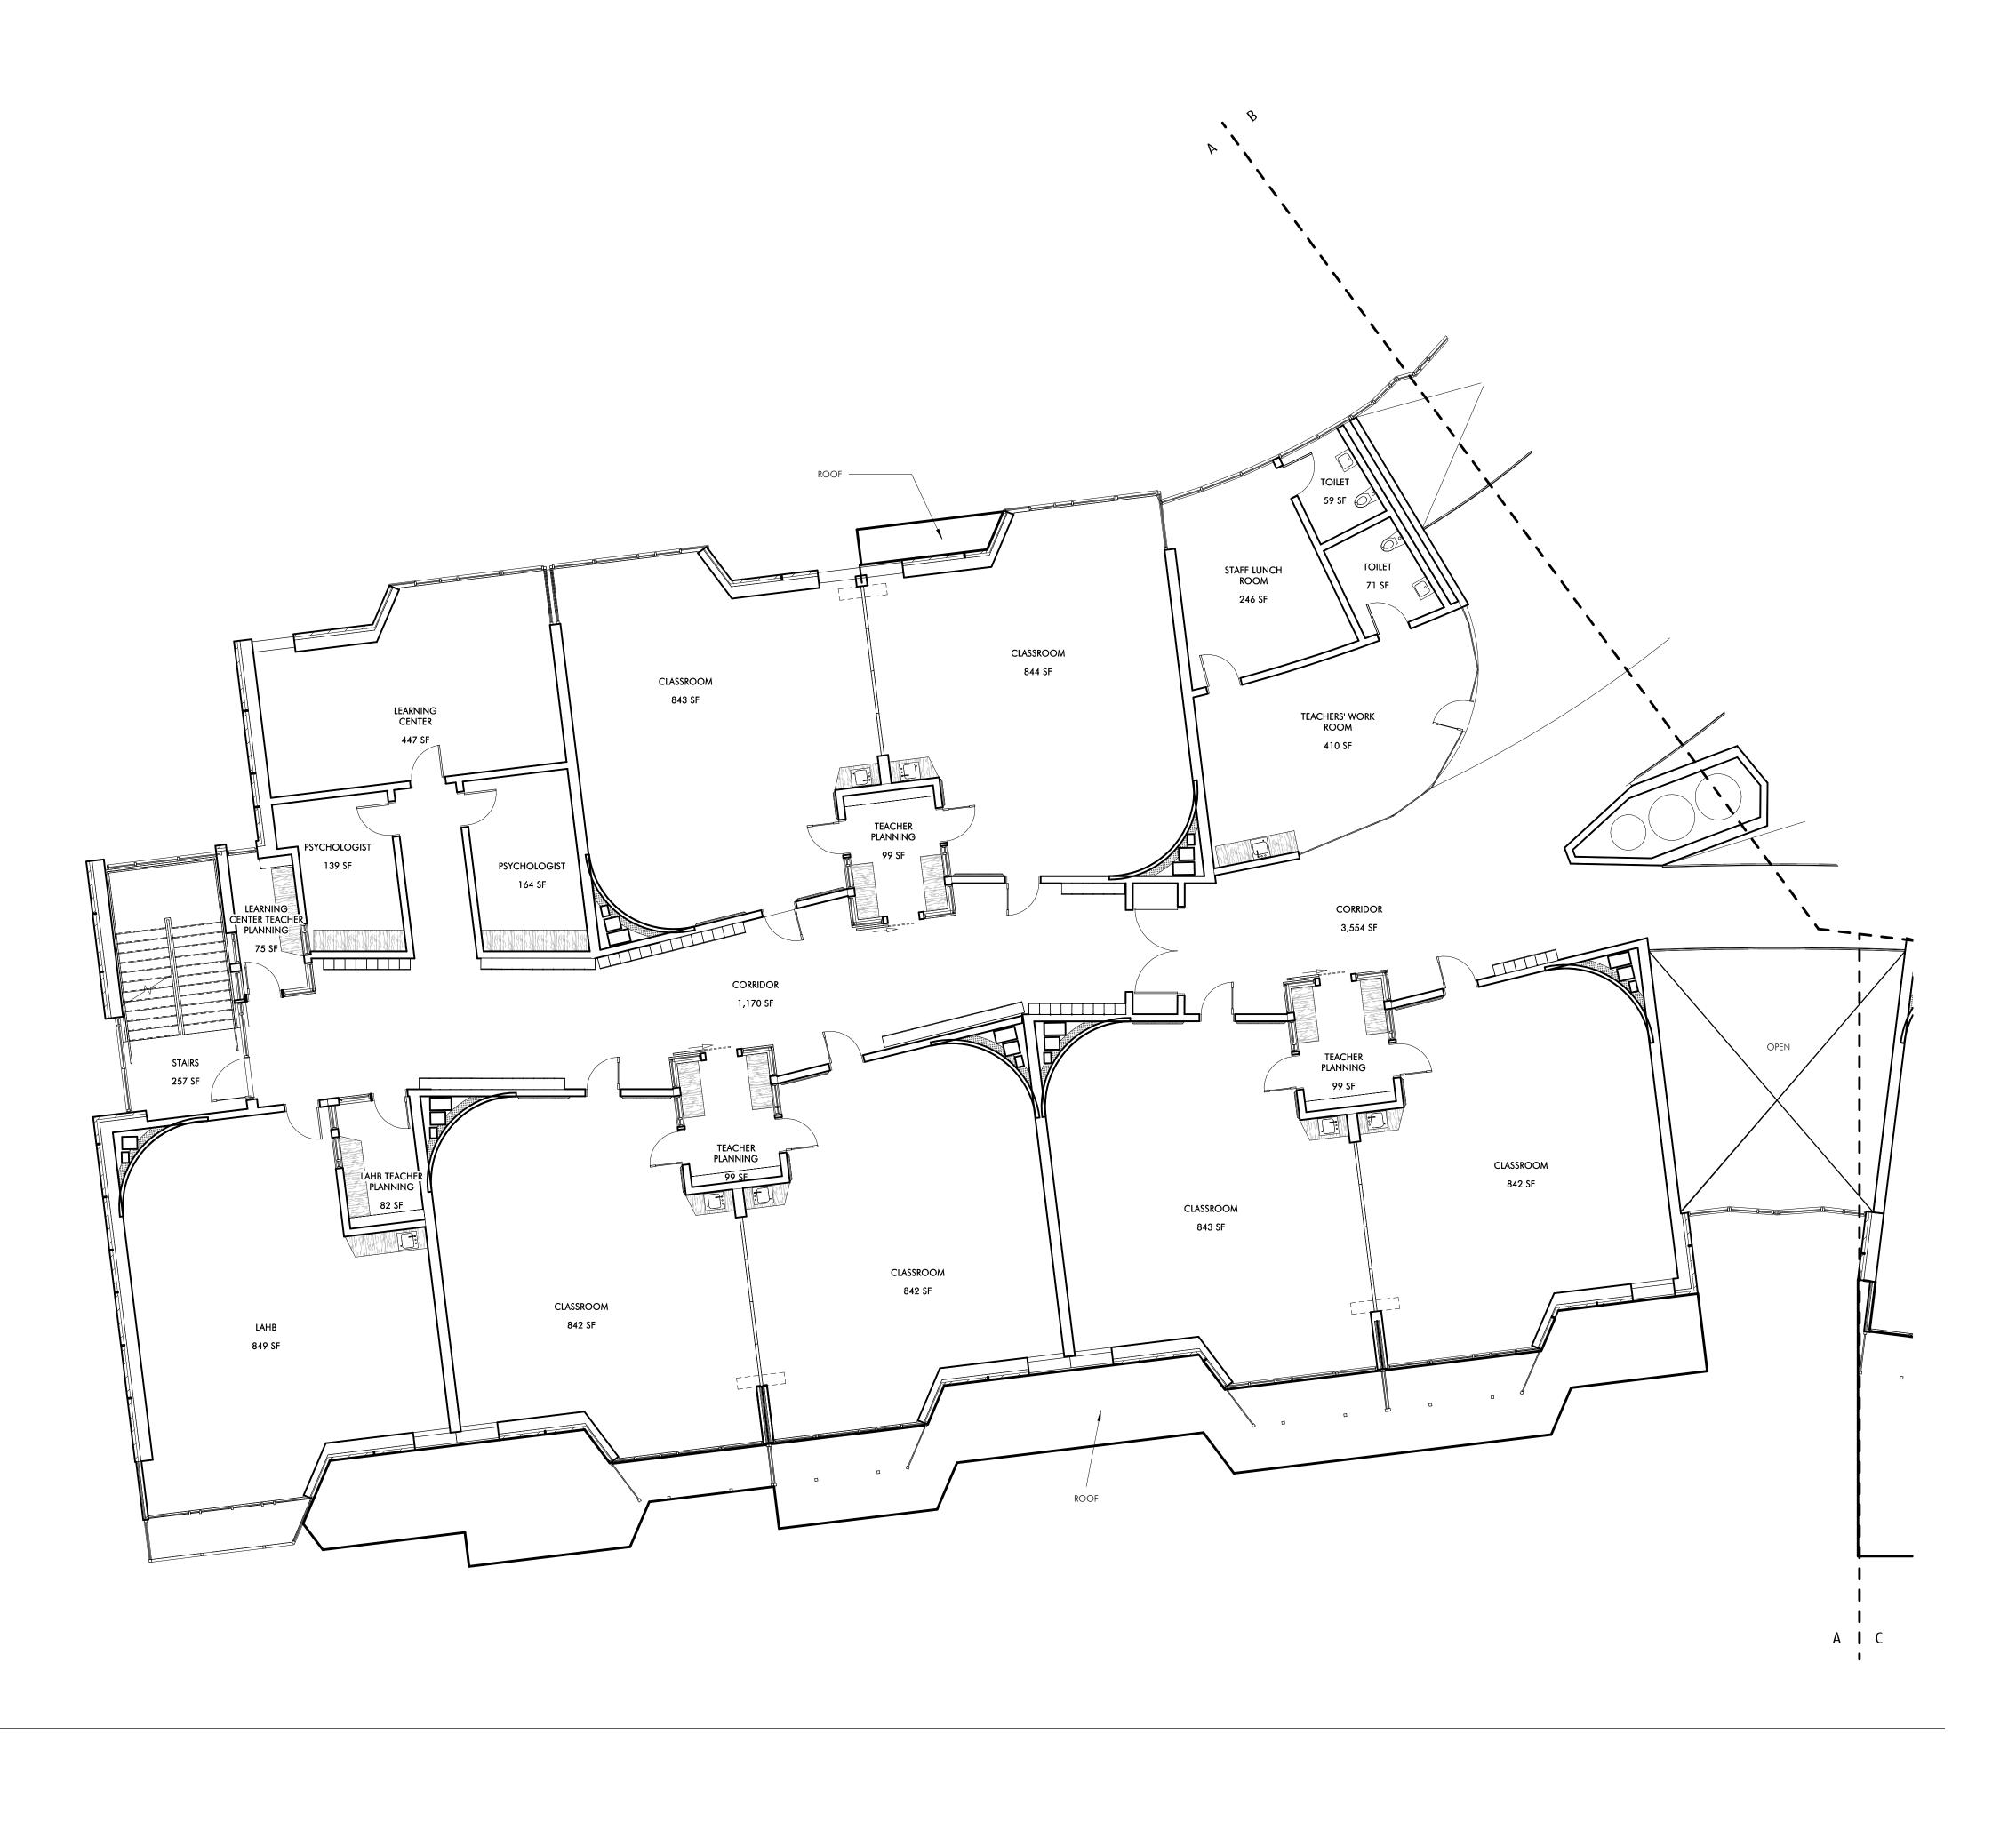

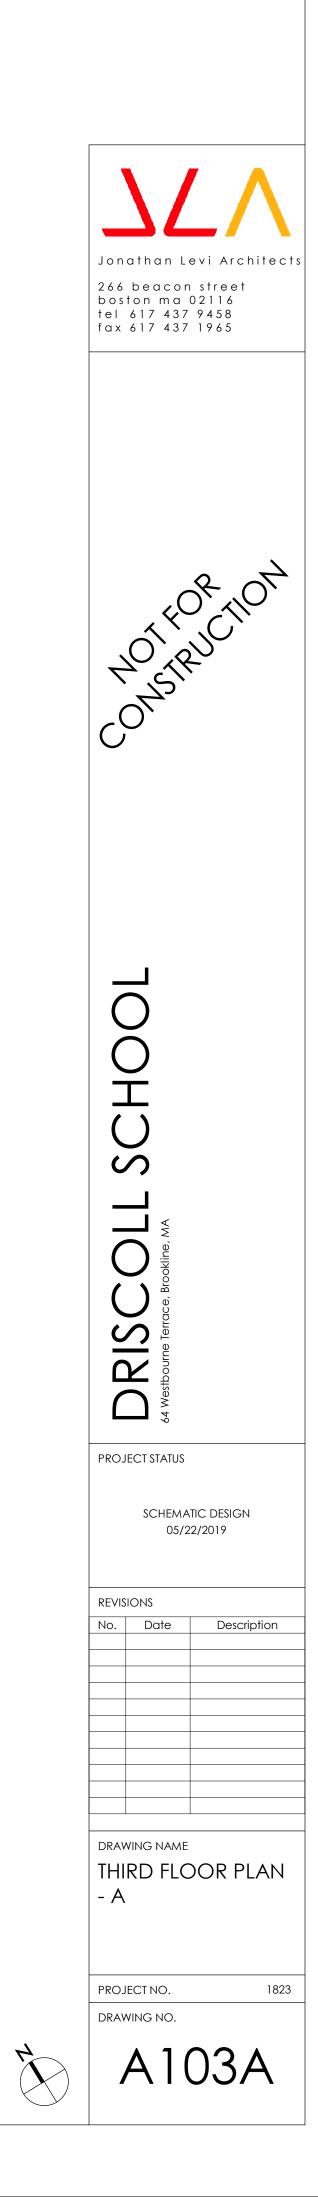







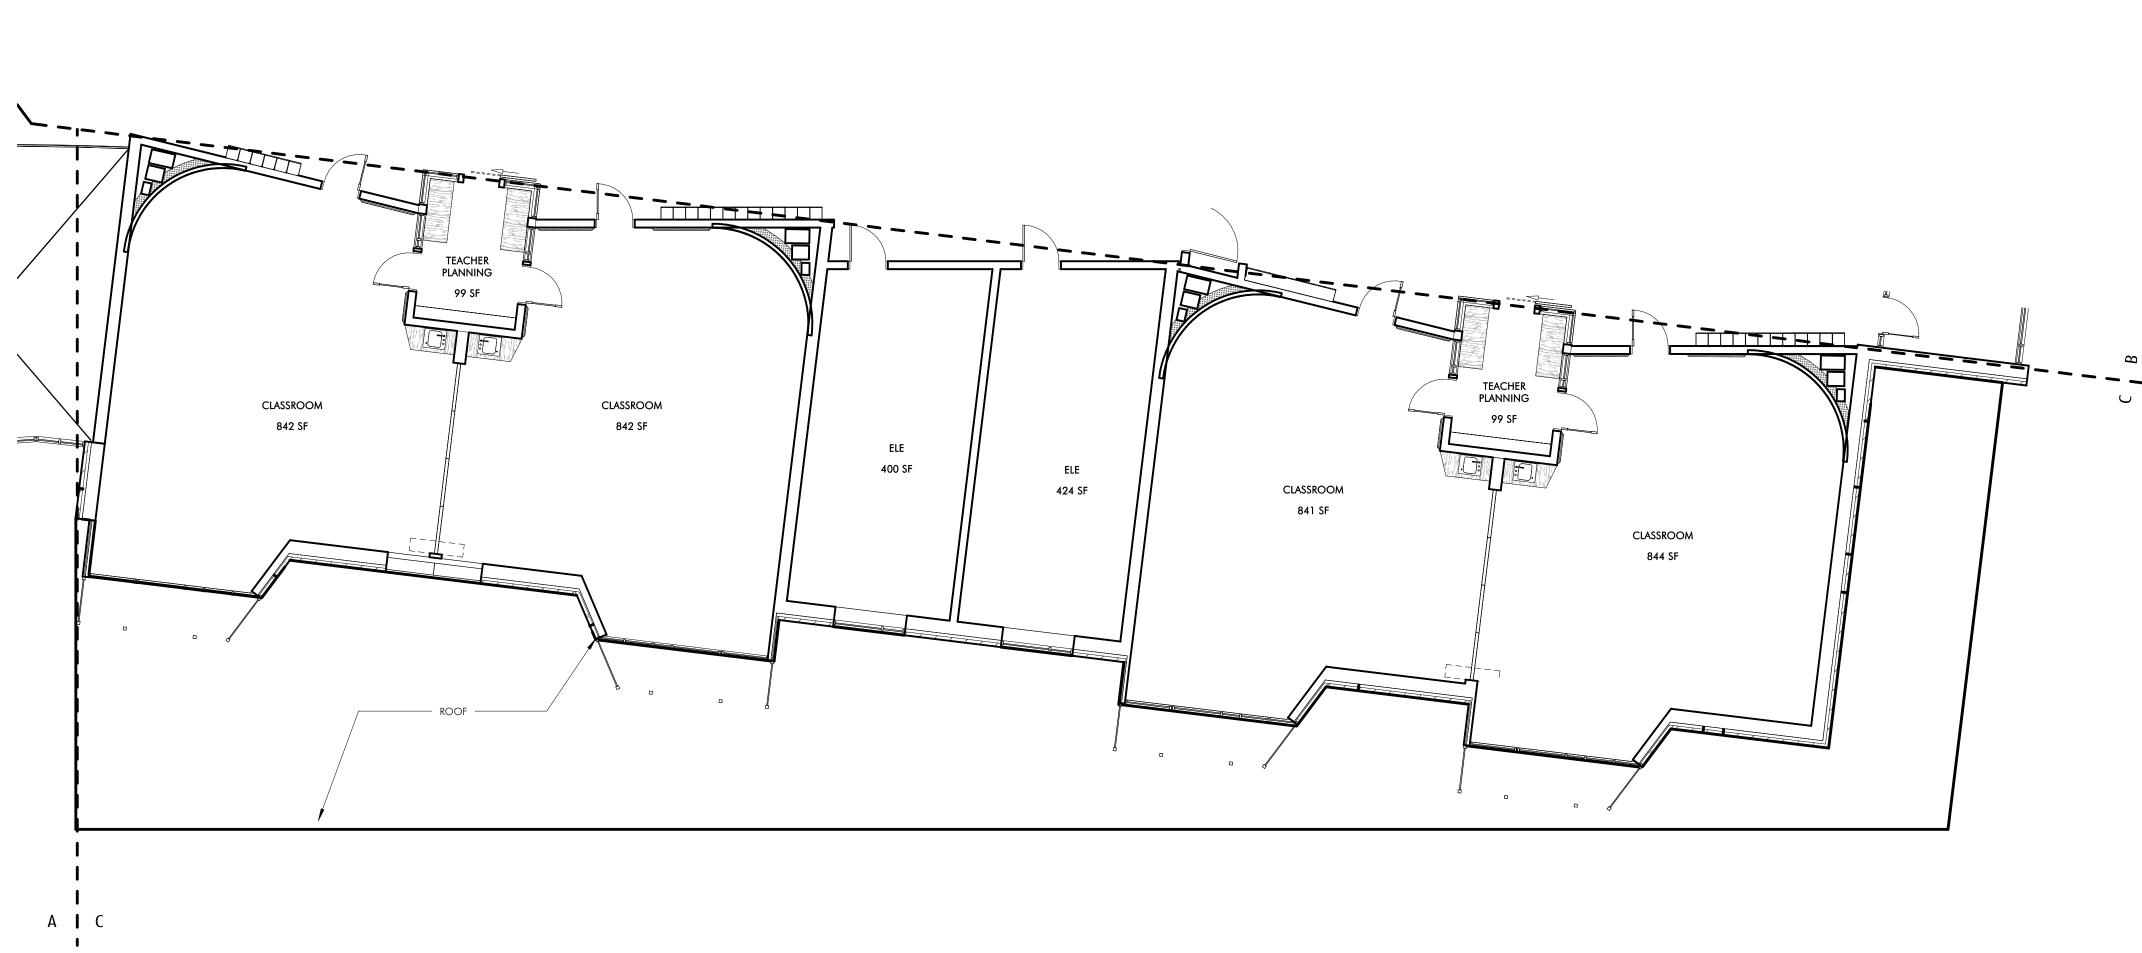

THIRD FLOOR PLAN - C 1/8" = 1'-0"

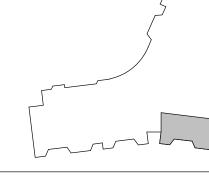



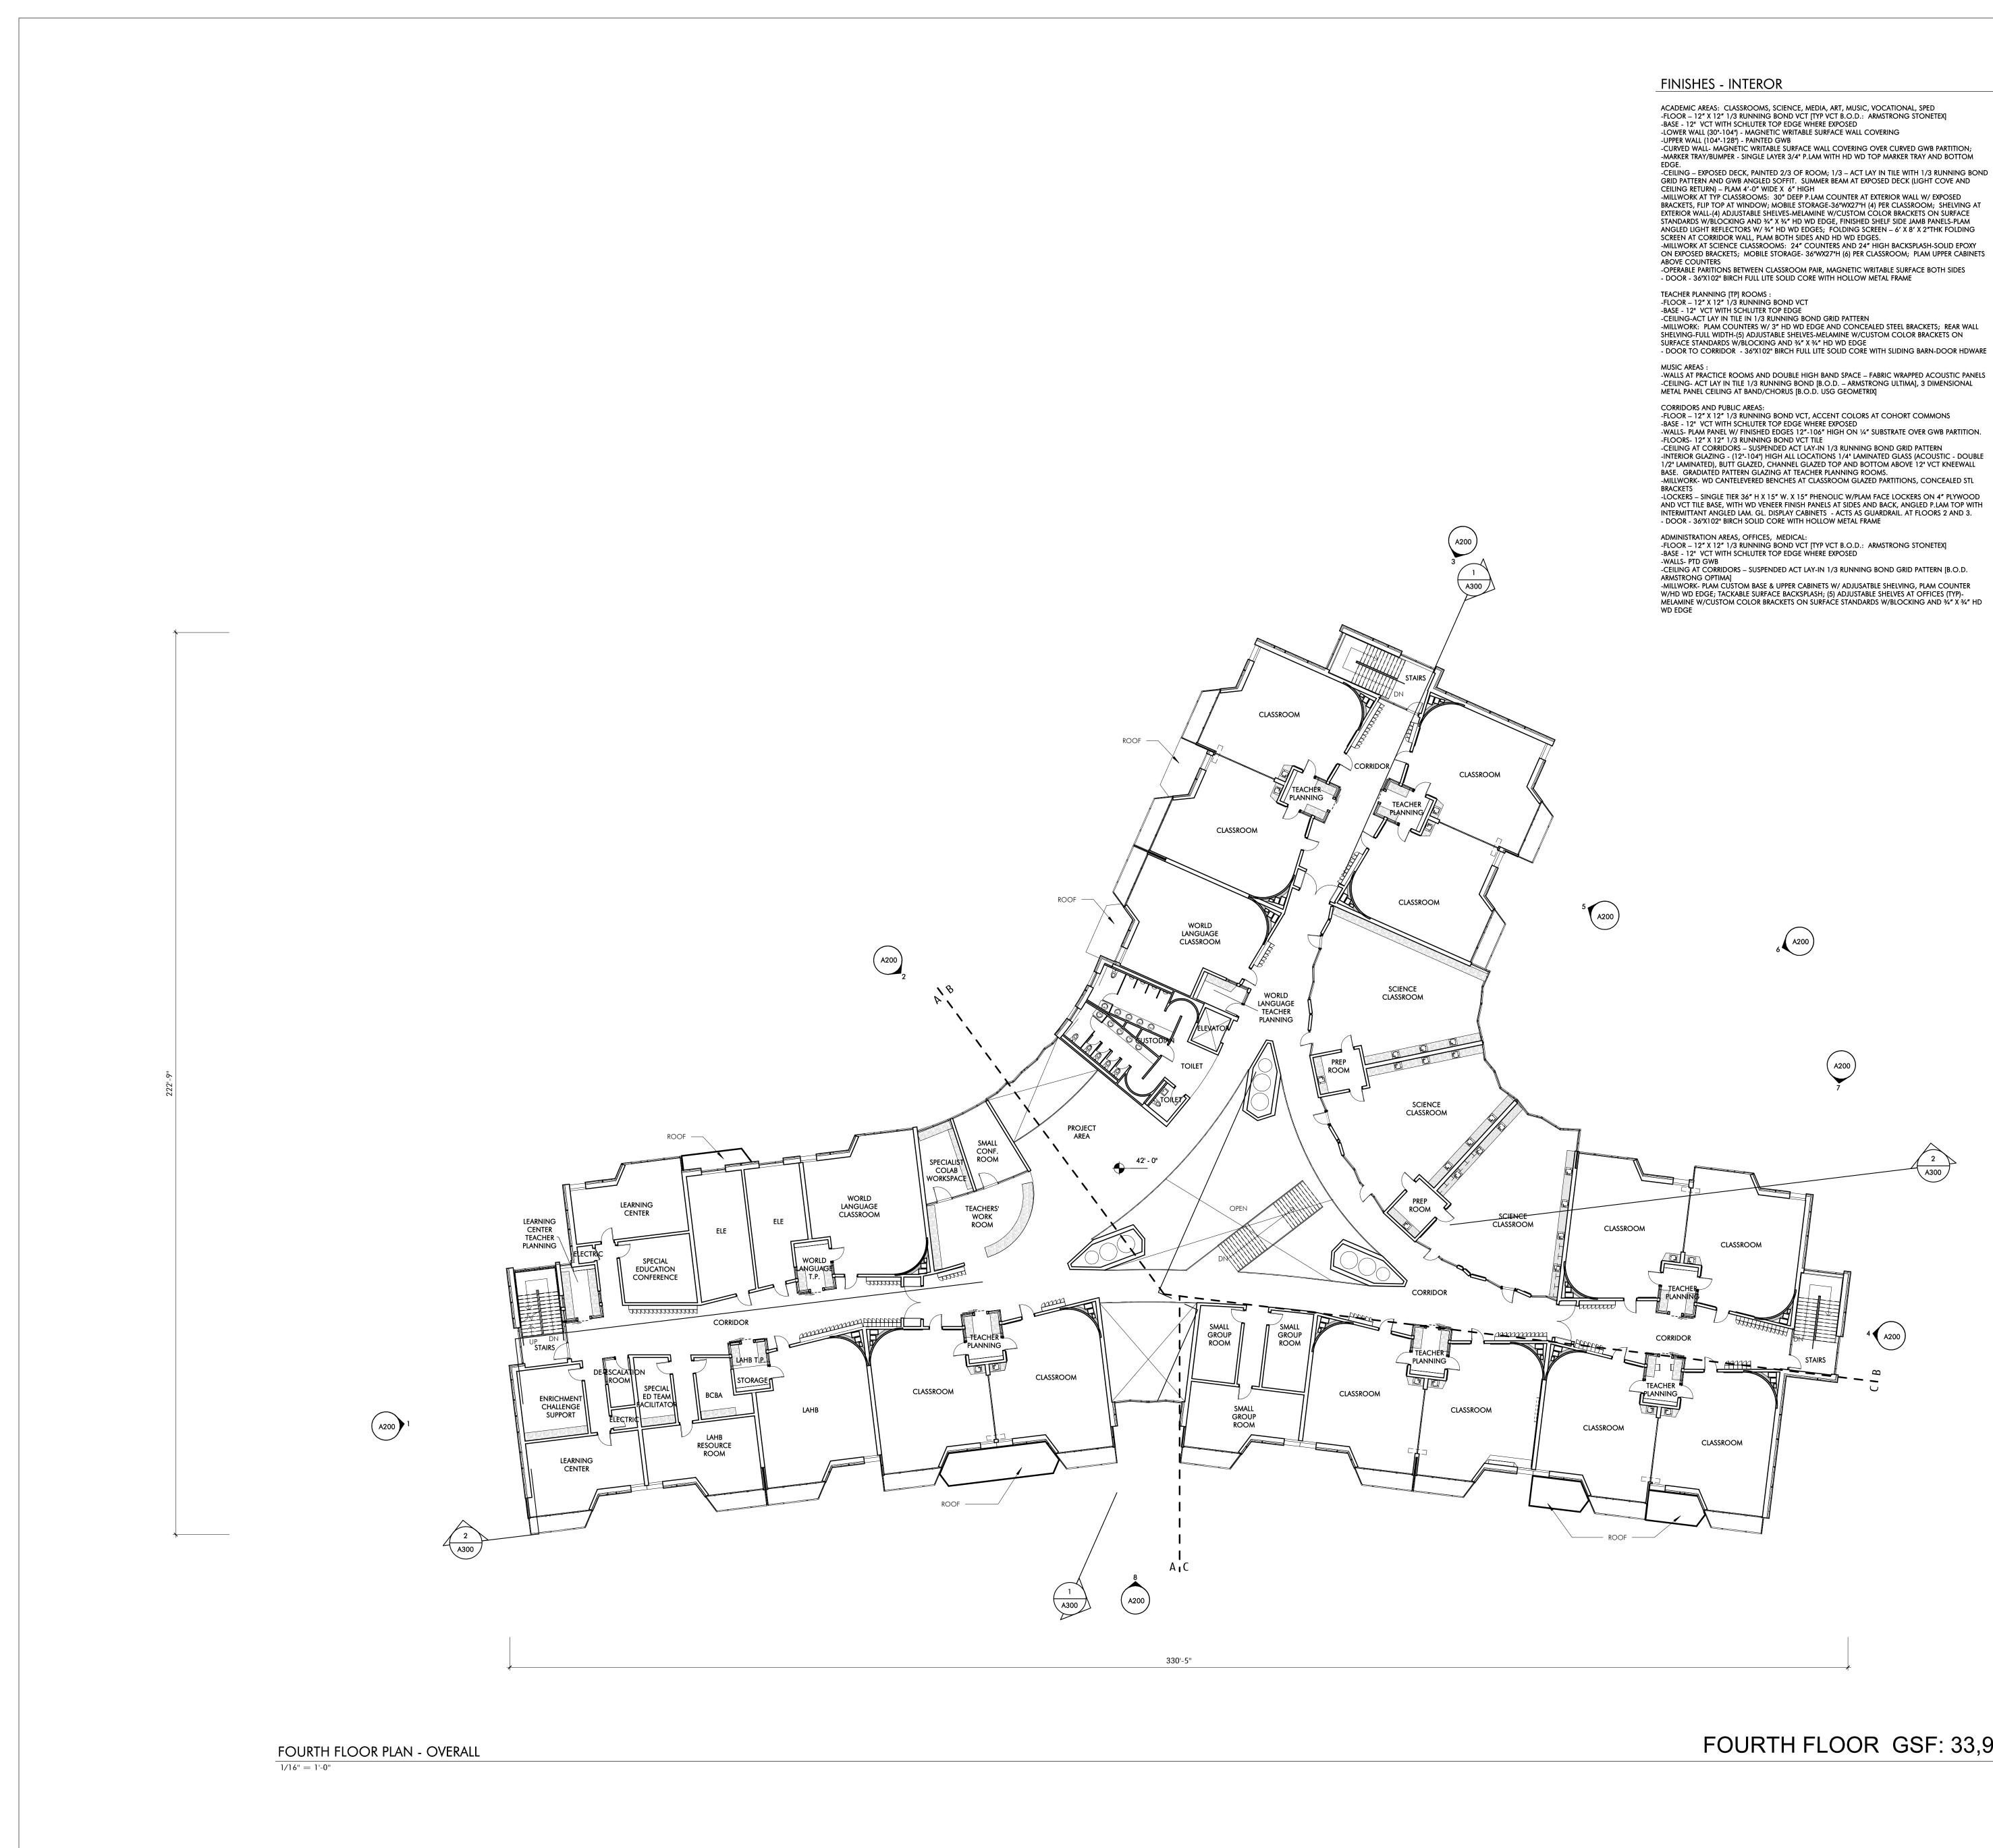

-CURVED WALL- MAGNETIC WRITABLE SURFACE WALL COVERING OVER CURVED GWB PARTITION; -MARKER TRAY/BUMPER - SINGLE LAYER 3/4" P.LAM WITH HD WD TOP MARKER TRAY AND BOTTOM -CEILING – EXPOSED DECK, PAINTED 2/3 OF ROOM; 1/3 – ACT LAY IN TILE WITH 1/3 RUNNING BOND GRID PATTERN AND GWB ANGLED SOFFIT. SUMMER BEAM AT EXPOSED DECK (LIGHT COVE AND -MILLWORK AT TYP CLASSROOMS: 30" DEEP P.LAM COUNTER AT EXTERIOR WALL W/ EXPOSED BRACKETS, FLIP TOP AT WINDOW; MOBILE STORAGE-36"WX27"H (4) PER CLASSROOM; SHELVING AT EXTERIOR WALL-(4) ADJUSTABLE SHELVES-MELAMINE W/CUSTOM COLOR BRACKETS ON SURFACE STANDARDS W/BLOCKING AND ¾" X ¾" HD WD EDGE, FINISHED SHELF SIDE JAMB PANELS-PLAM ANGLED LIGHT REFLECTORS W/ 3/4" HD WD EDGES; FOLDING SCREEN - 6' X 8' X 2"THK FOLDING -MILLWORK AT SCIENCE CLASSROOMS: 24" COUNTERS AND 24" HIGH BACKSPLASH-SOLID EPOXY ON EXPOSED BRACKETS; MOBILE STORAGE- 36"WX27"H (6) PER CLASSROOM; PLAM UPPER CABINETS

-OPERABLE PARITIONS BETWEEN CLASSROOM PAIR, MAGNETIC WRITABLE SURFACE BOTH SIDES

SHELVING-FULL WIDTH-(5) ADJUSTABLE SHELVES-MELAMINE W/CUSTOM COLOR BRACKETS ON - DOOR TO CORRIDOR - 36"X102" BIRCH FULL LITE SOLID CORE WITH SLIDING BARN-DOOR HDWARE

# -CEILING- ACT LAY IN TILE 1/3 RUNNING BOND [B.O.D. – ARMSTRONG ULTIMA], 3 DIMENSIONAL METAL PANEL CEILING AT BAND/CHORUS [B.O.D. USG GEOMETRIX]

-BASE - 12" VCT WITH SCHLUTER TOP EDGE WHERE EXPOSED -WALLS- PLAM PANEL W/ FINISHED EDGES 12"-106" HIGH ON 1/4" SUBSTRATE OVER GWB PARTITION. -FLOORS- 12 X 12 1/3 KUNNING BOND VCT TILE -CEILING AT CORRIDORS – SUSPENDED ACT LAY-IN 1/3 RUNNING BOND GRID PATTERN -INTERIOR GLAZING - (12"-104") HIGH ALL LOCATIONS 1/4" LAMINATED GLASS (ACOUSTIC - DOUBLE 1/2" LAMINATED), BUTT GLAZED, CHANNEL GLAZED TOP AND BOTTOM ABOVE 12" VCT KNEEWALL BASE. GRADIATED PATTERN GLAZING AT TEACHER PLANNING ROOMS. -MILLWORK- WD CANTELEVERED BENCHES AT CLASSROOM GLAZED PARTITIONS, CONCEALED STL -LOCKERS – SINGLE TIER 36" H X 15" W. X 15" PHENOLIC W/PLAM FACE LOCKERS ON 4" PLYWOOD AND VCT TILE BASE, WITH WD VENEER FINISH PANELS AT SIDES AND BACK, ANGLED P.LAM TOP WITH INTERMITTANT ANGLED LAM. GL. DISPLAY CABINETS - ACTS AS GUARDRAIL. AT FLOORS 2 AND 3.

-CEILING AT CORRIDORS – SUSPENDED ACT LAY-IN 1/3 RUNNING BOND GRID PATTERN [B.O.D. ARMSTRONG OPTIMAJ -MILLWORK- PLAM CUSTOM BASE & UPPER CABINETS W/ ADJUSATBLE SHELVING, PLAM COUNTER

# AUDITORIUM:

-WALLS – 50% ACOUSTIC WOOD WALL SYSTEM [ARMSTRONG WOODWORKS], 50% GROUND FACED BLOCK -FLOOR - CARPET AT AISLES, SLAB ON GRADE POWER TROWELED CONCRETE AT SEATS (SLAB IS SLOPED AT SEATING AREA) -CEILING -PTD. EXPOSED METAL DECK WITH 50% SUSPENDED WOOD PANEL CEILING (ARMSTRONG WOODWORKS) -3' & 6' DIAMETER DOUBLE DOME ACRYLIC BUBBLE SKYLIGHT -FLOOR MOUNTED FOLD UP AUDITORIUM SEATING (420 SEATS)

#### -FLOOR - WOOD ATHLETIC FLOORING -BASE- VENTED RUBBER BASE

-WALLS - GYM WALL PADS TO BE 8'-8" A.F.F. EXCEPT BEHIND BLEACHERS, PRE-ENGINEERED STANDARD FINISH EVERYWHERE ELSE -CEILING – SUSPENDED LAY IN PRE PAINTED TEGULAR EDGE TECTUM PLANK AND EXPOSED DECK, -BLEACHERS- TELESCOPING, WALL MOUNTED, MOTORIZED FOR UP TO 750 SEATS TOILET ROOMS: -FLOOR- PORCELAIN TILE

#### -BASE- METAL COVE BASE

-WALLS TO 98"- CERAMIC TILE, W/ ACCENT COLOR. PTD GWB ABOVE W/HIGH PERFORMANCE COATING -CEILING-PTD W/HIGH PERFORMANCE COATING -MILLWORK- SOLID SURFACE COUNTERS WITH CONCEALED STEEL BRACKETS

## OTHER ROOMS:

FLOORS -QUARRY TILE AT KITCHEN. 1/3 RUNNING BOND

-SEALED CONCRETE AT BACK OF HOUSE -STAIRS - VCT TREADS & RISERS WITH RUBBER NOSING, VCT TILE AT LANDINGS WALLS

#### -FIBER REINFORCED PANELS IN KITCHEN -INTERIOR GLAZING TO BE CHANNEL GLAZING NOT HM

CEILINGS -ACT IN BACK OF HOUSE AREAS, LOCKER ROOMS & KITCHEN

#### GENERAL: -CLASSROOM LOCKERS 15"Wx12"Dx36"H W/ANGLED TOP – PHENOLIC W/PLAM FINISH AND WD VENEER SIDES AND BACK -ATHLETIC / PE LOCKERS: 50 COUNT PER LOCKER ROOM - METAL 2 TIER 30"H. X 15"W X 15"D -ROLLER SHADE AT DOORS WITH LITES AND GLAZED PARTITIONS -ROLLER SHADE AT SOUTH EXTERIOR WINDOWS


-MILLWORK PLAM – WD GRAIN PLAM FINISH -2"MAXXON TOPPING SLAB-ACOUSTIC AT FLOORS 2, 3, 4


#### TECH/ FIXTURES/ FURNISHINGS ACADEMIC AREAS: -OPERABLE WINDOWS

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-PAGING SYSTEM, WIRELESS DATA INTERCOM, CLOCK SYSTEM, -SOUND LIFT SYSTEM, WIRELESS ACCESS POINT, LED TOUCH SCREEN MONITOR

FOURTH FLOOR GSF: 33,916 SF



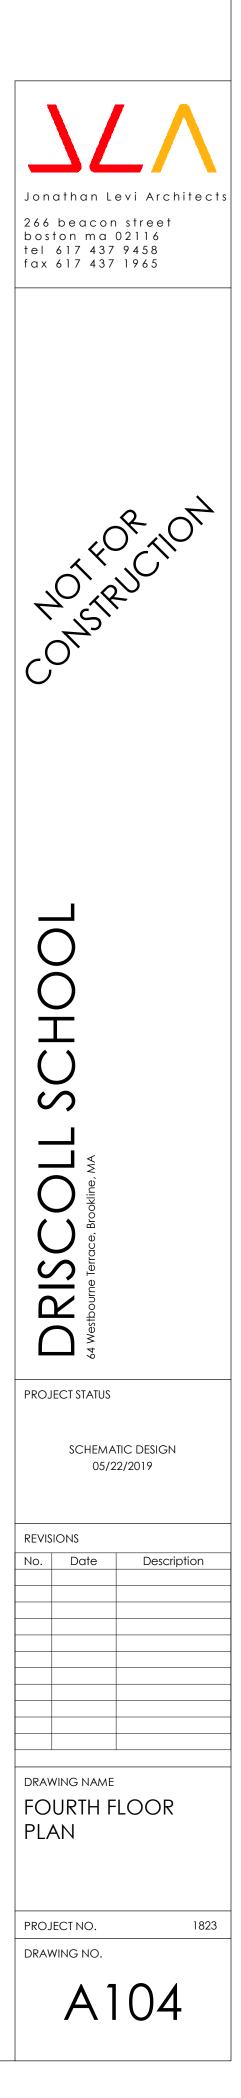

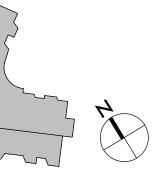
FOURTH FLOOR PLAN - A 1/8" = 1'-0"











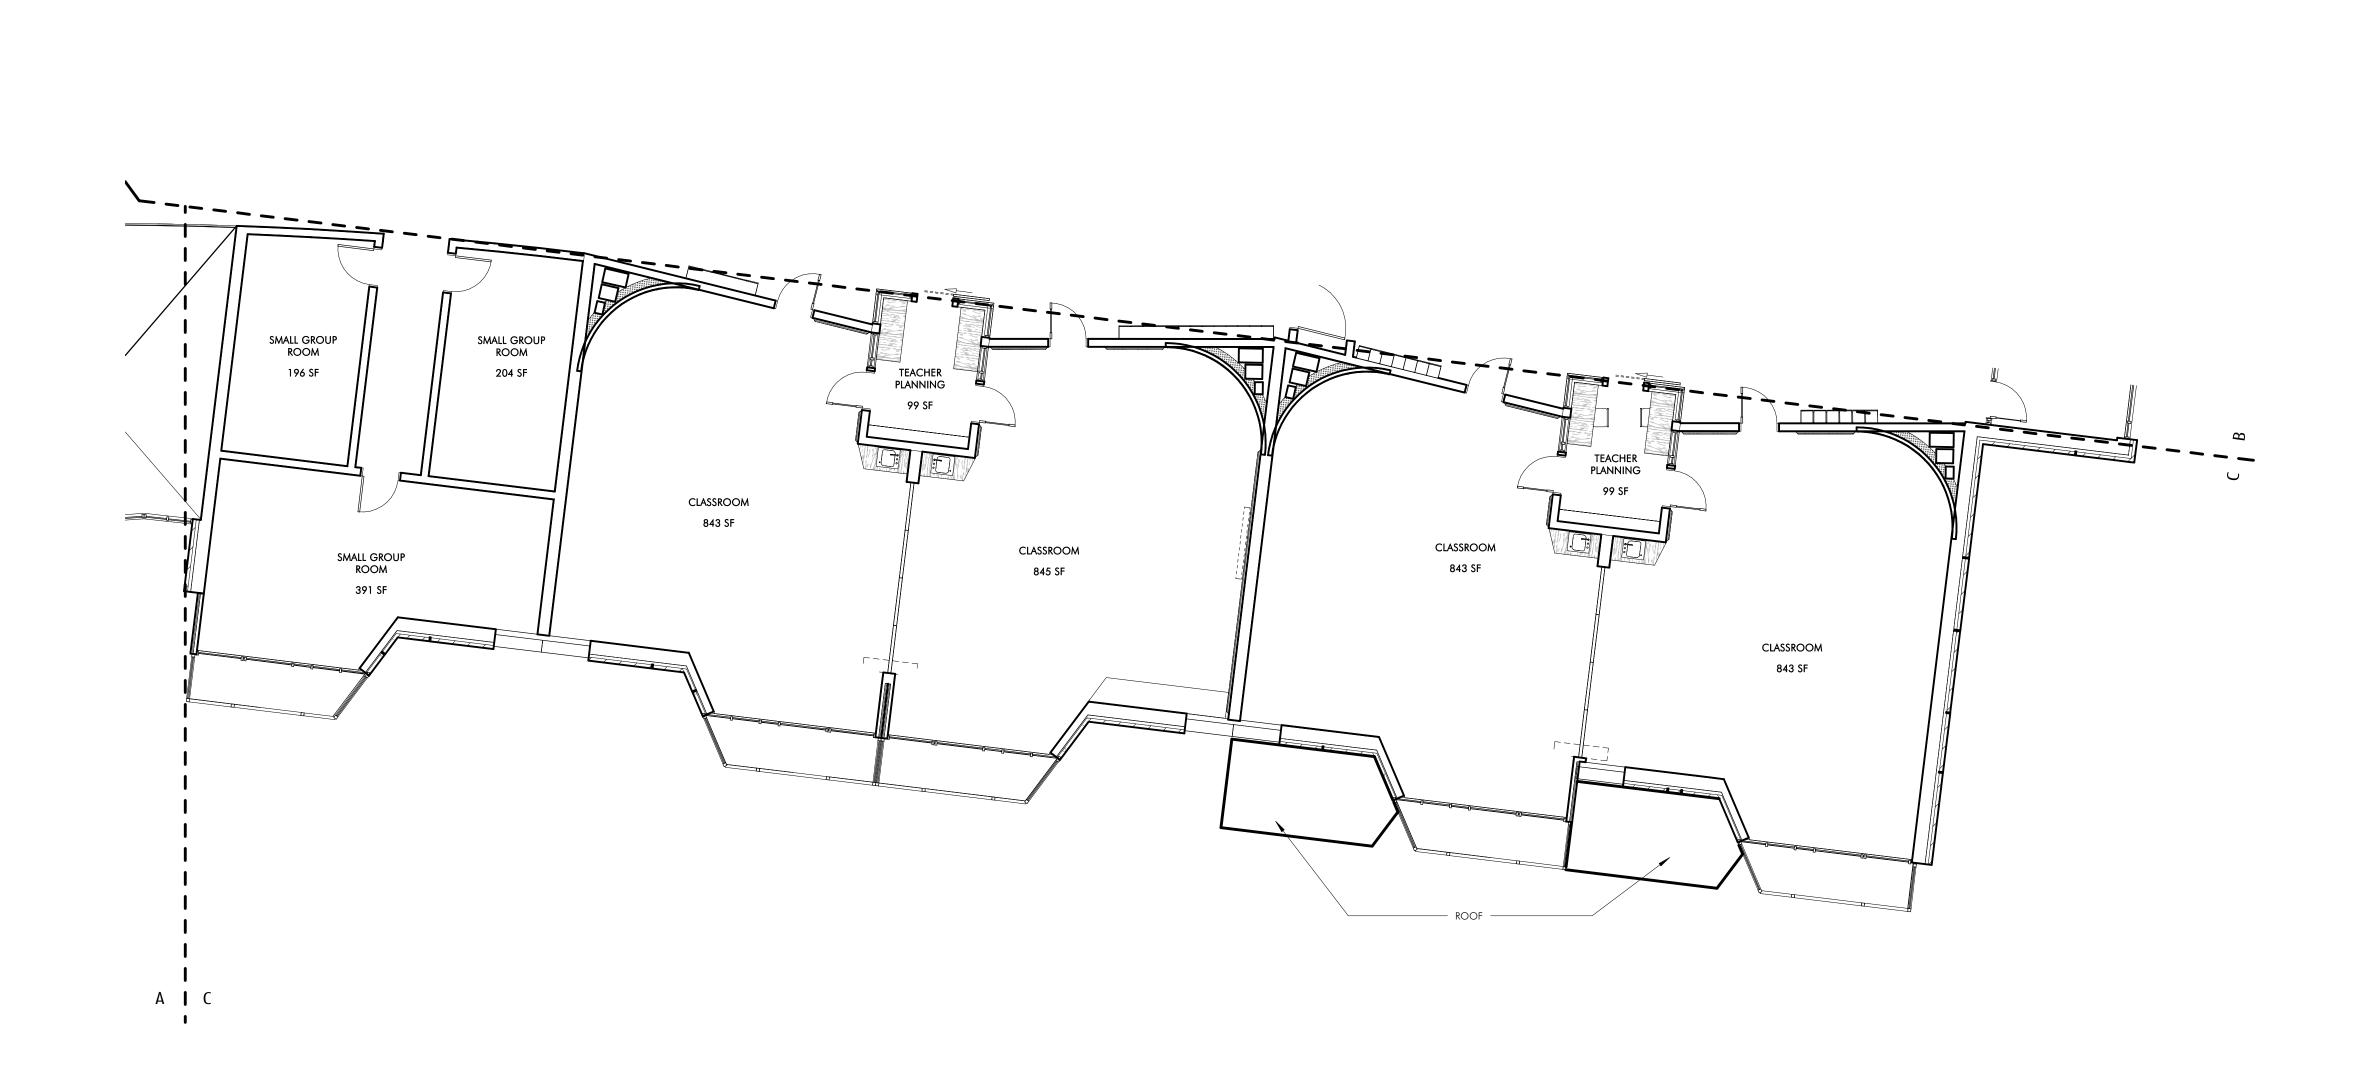

FOURTH FLOOR PLAN - C 1/8'' = 1'-0''

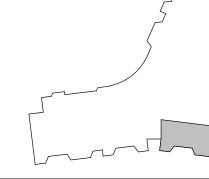


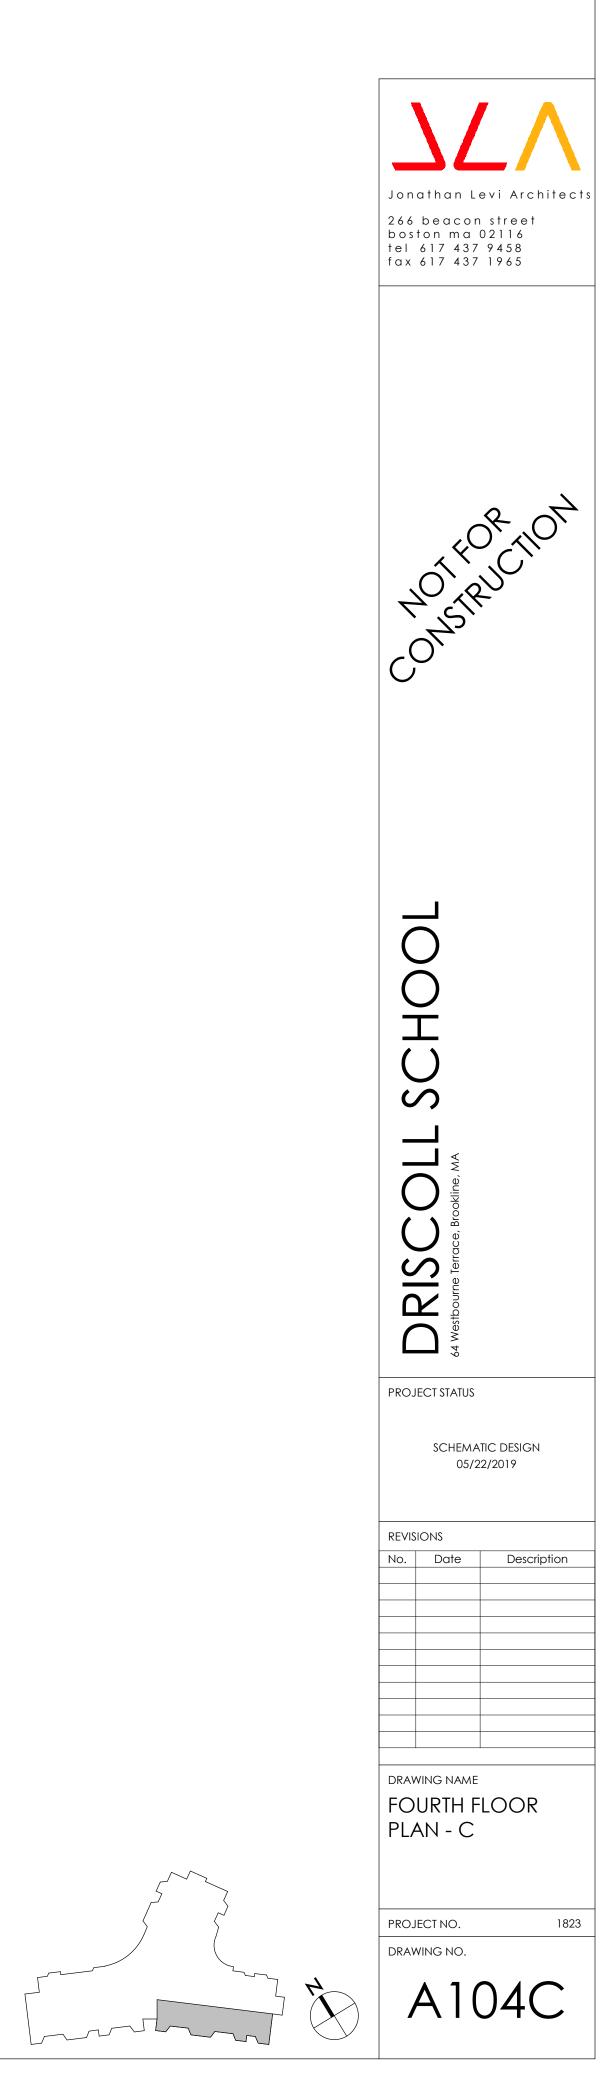






ROOF GSF: 334 SF

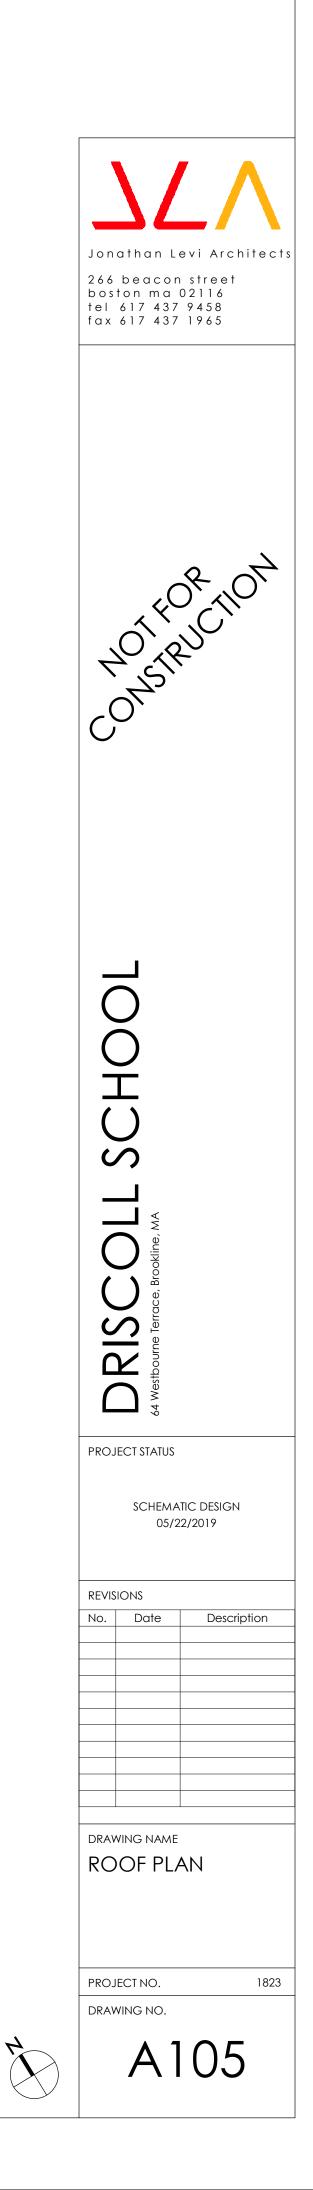



ROOF PLAN - A


STAIR ACCESS TO ROOF -

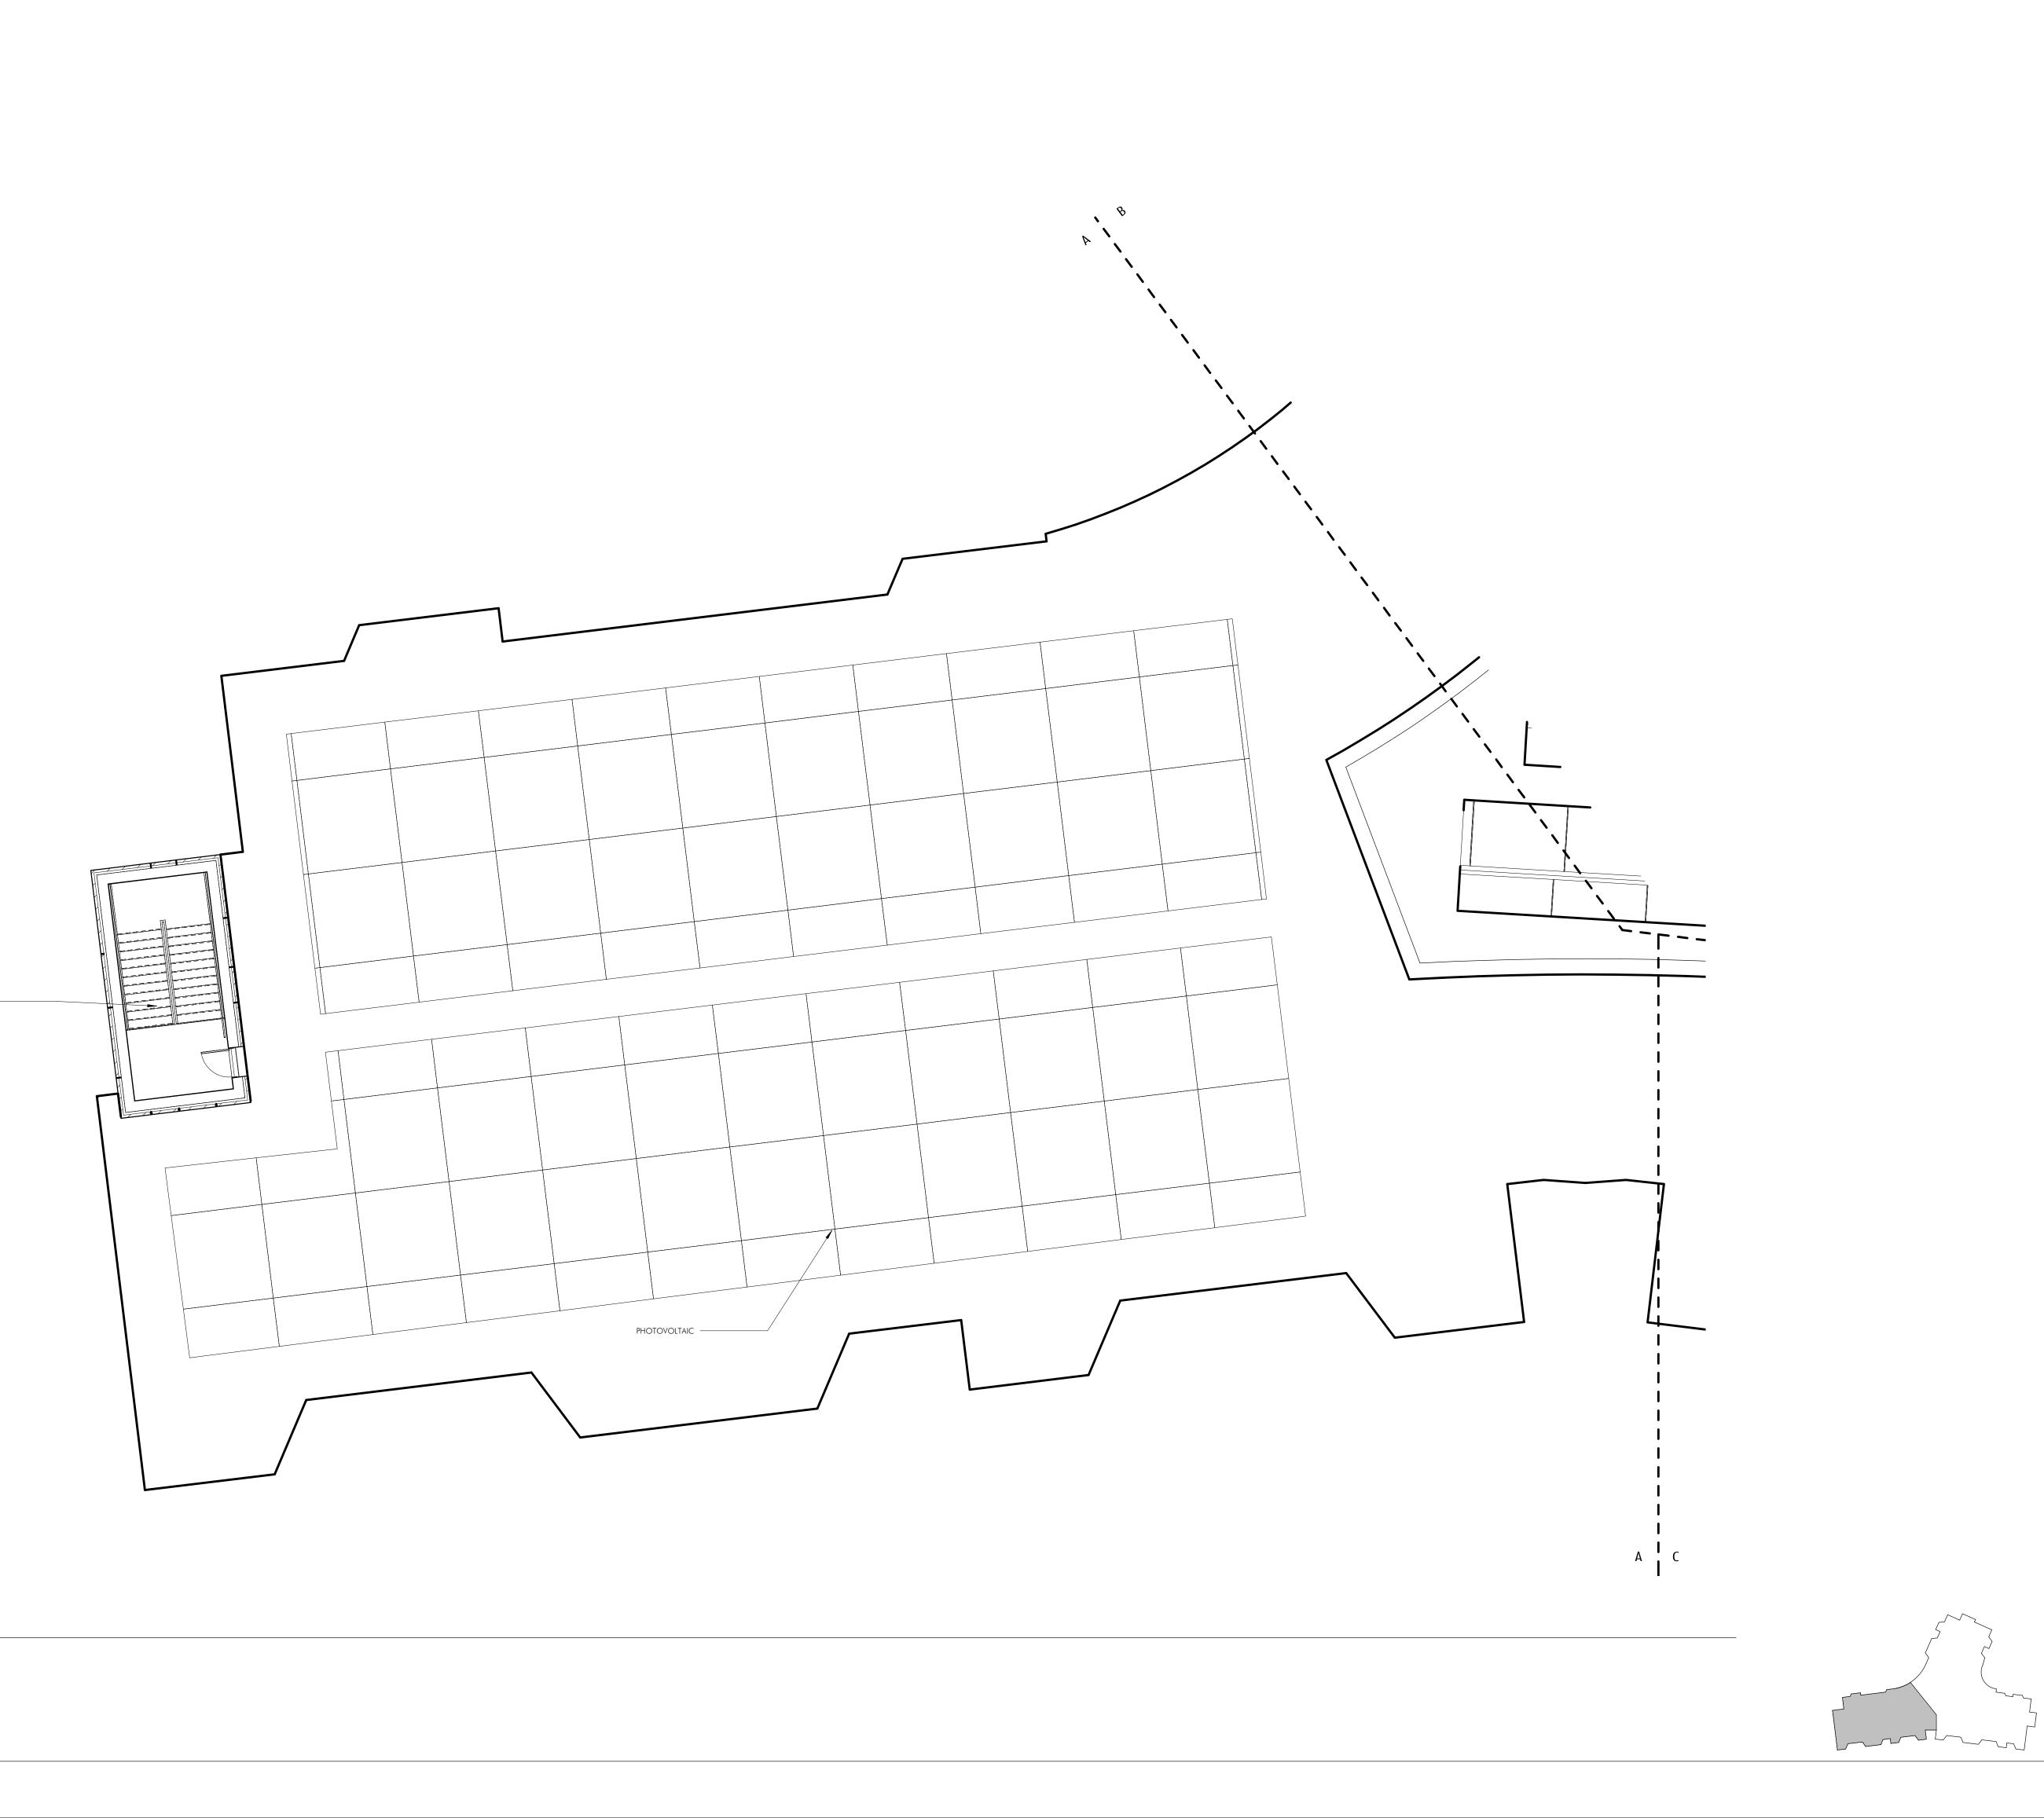




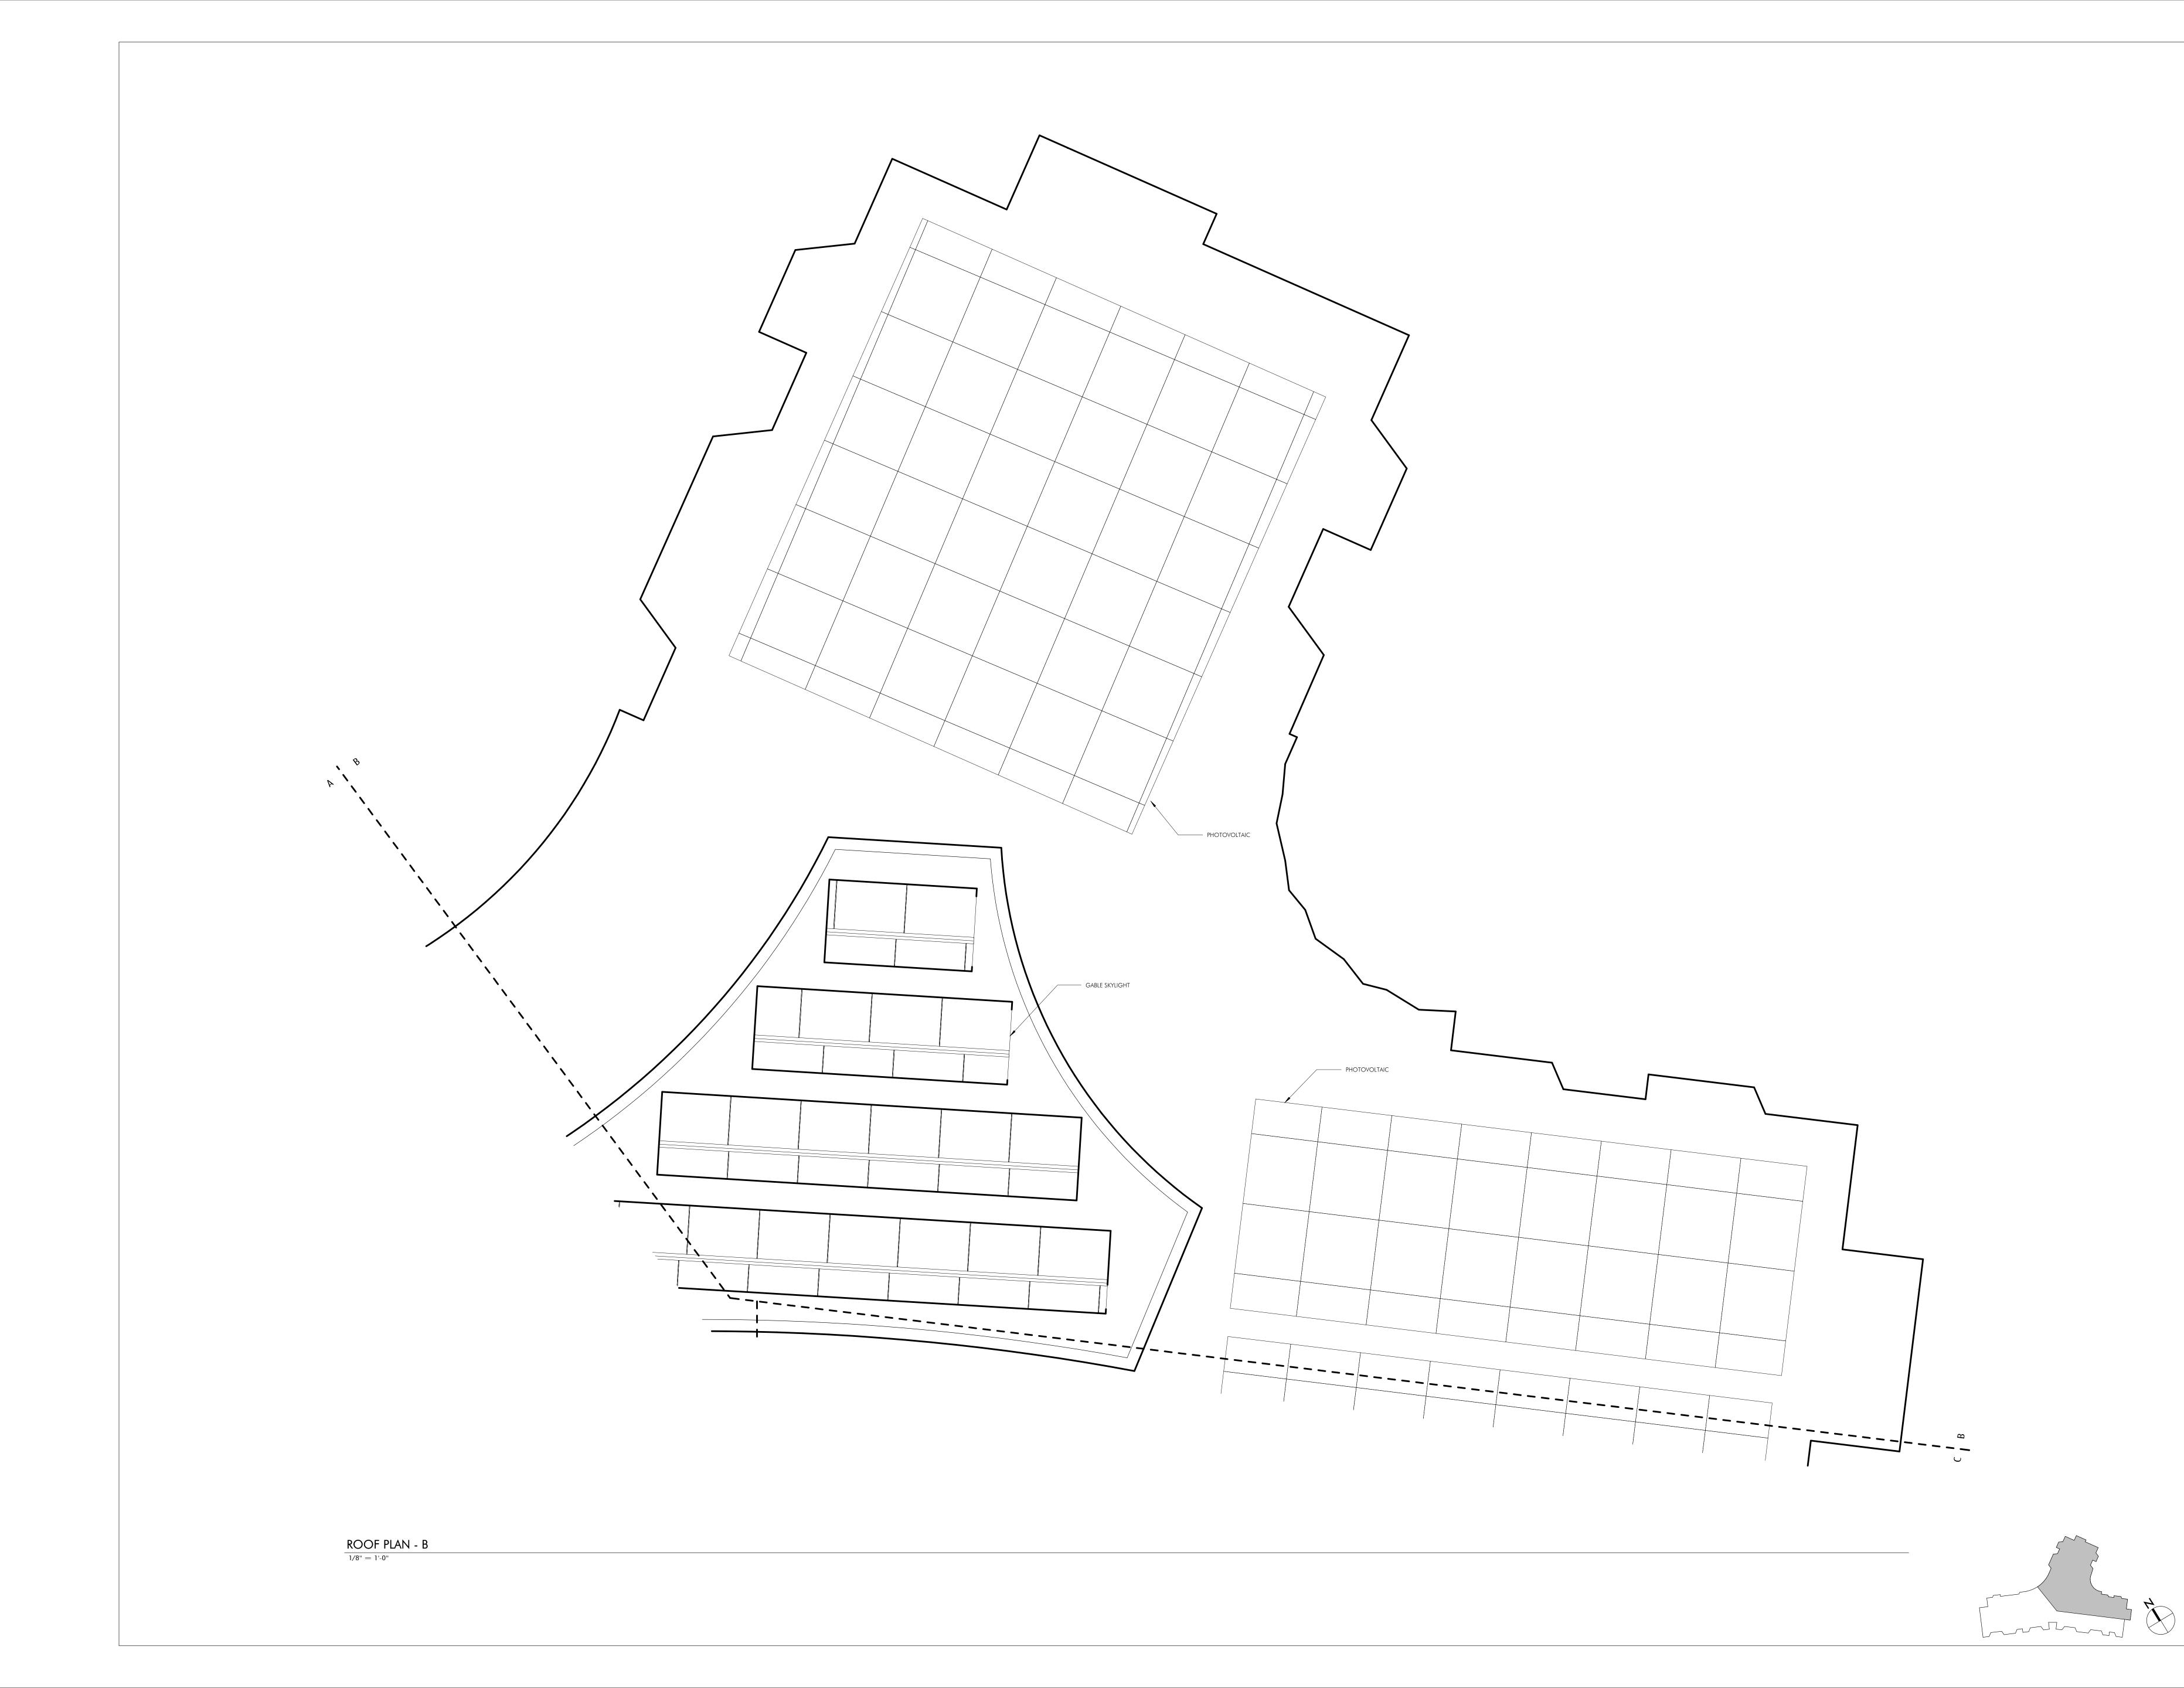

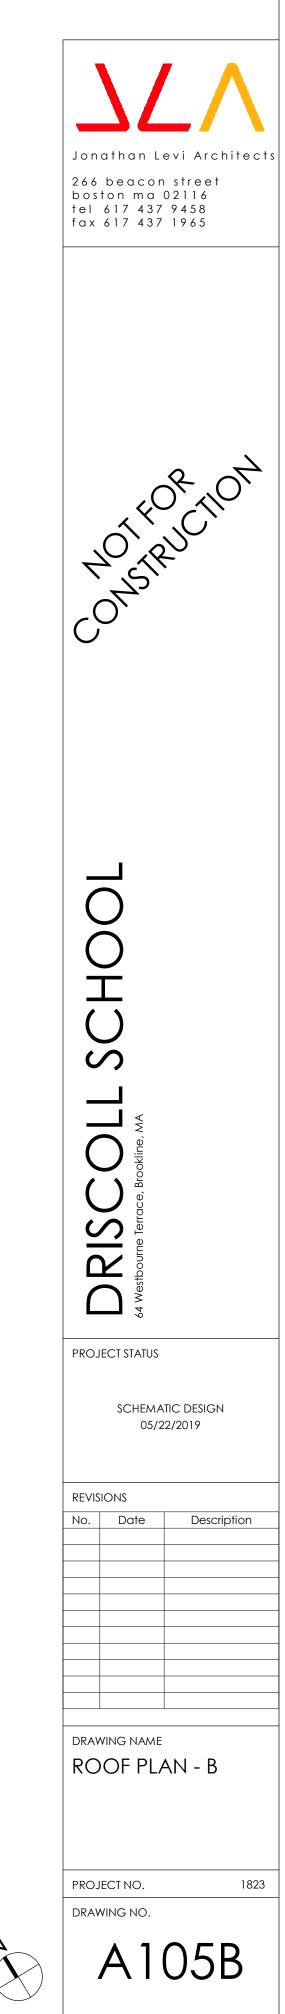


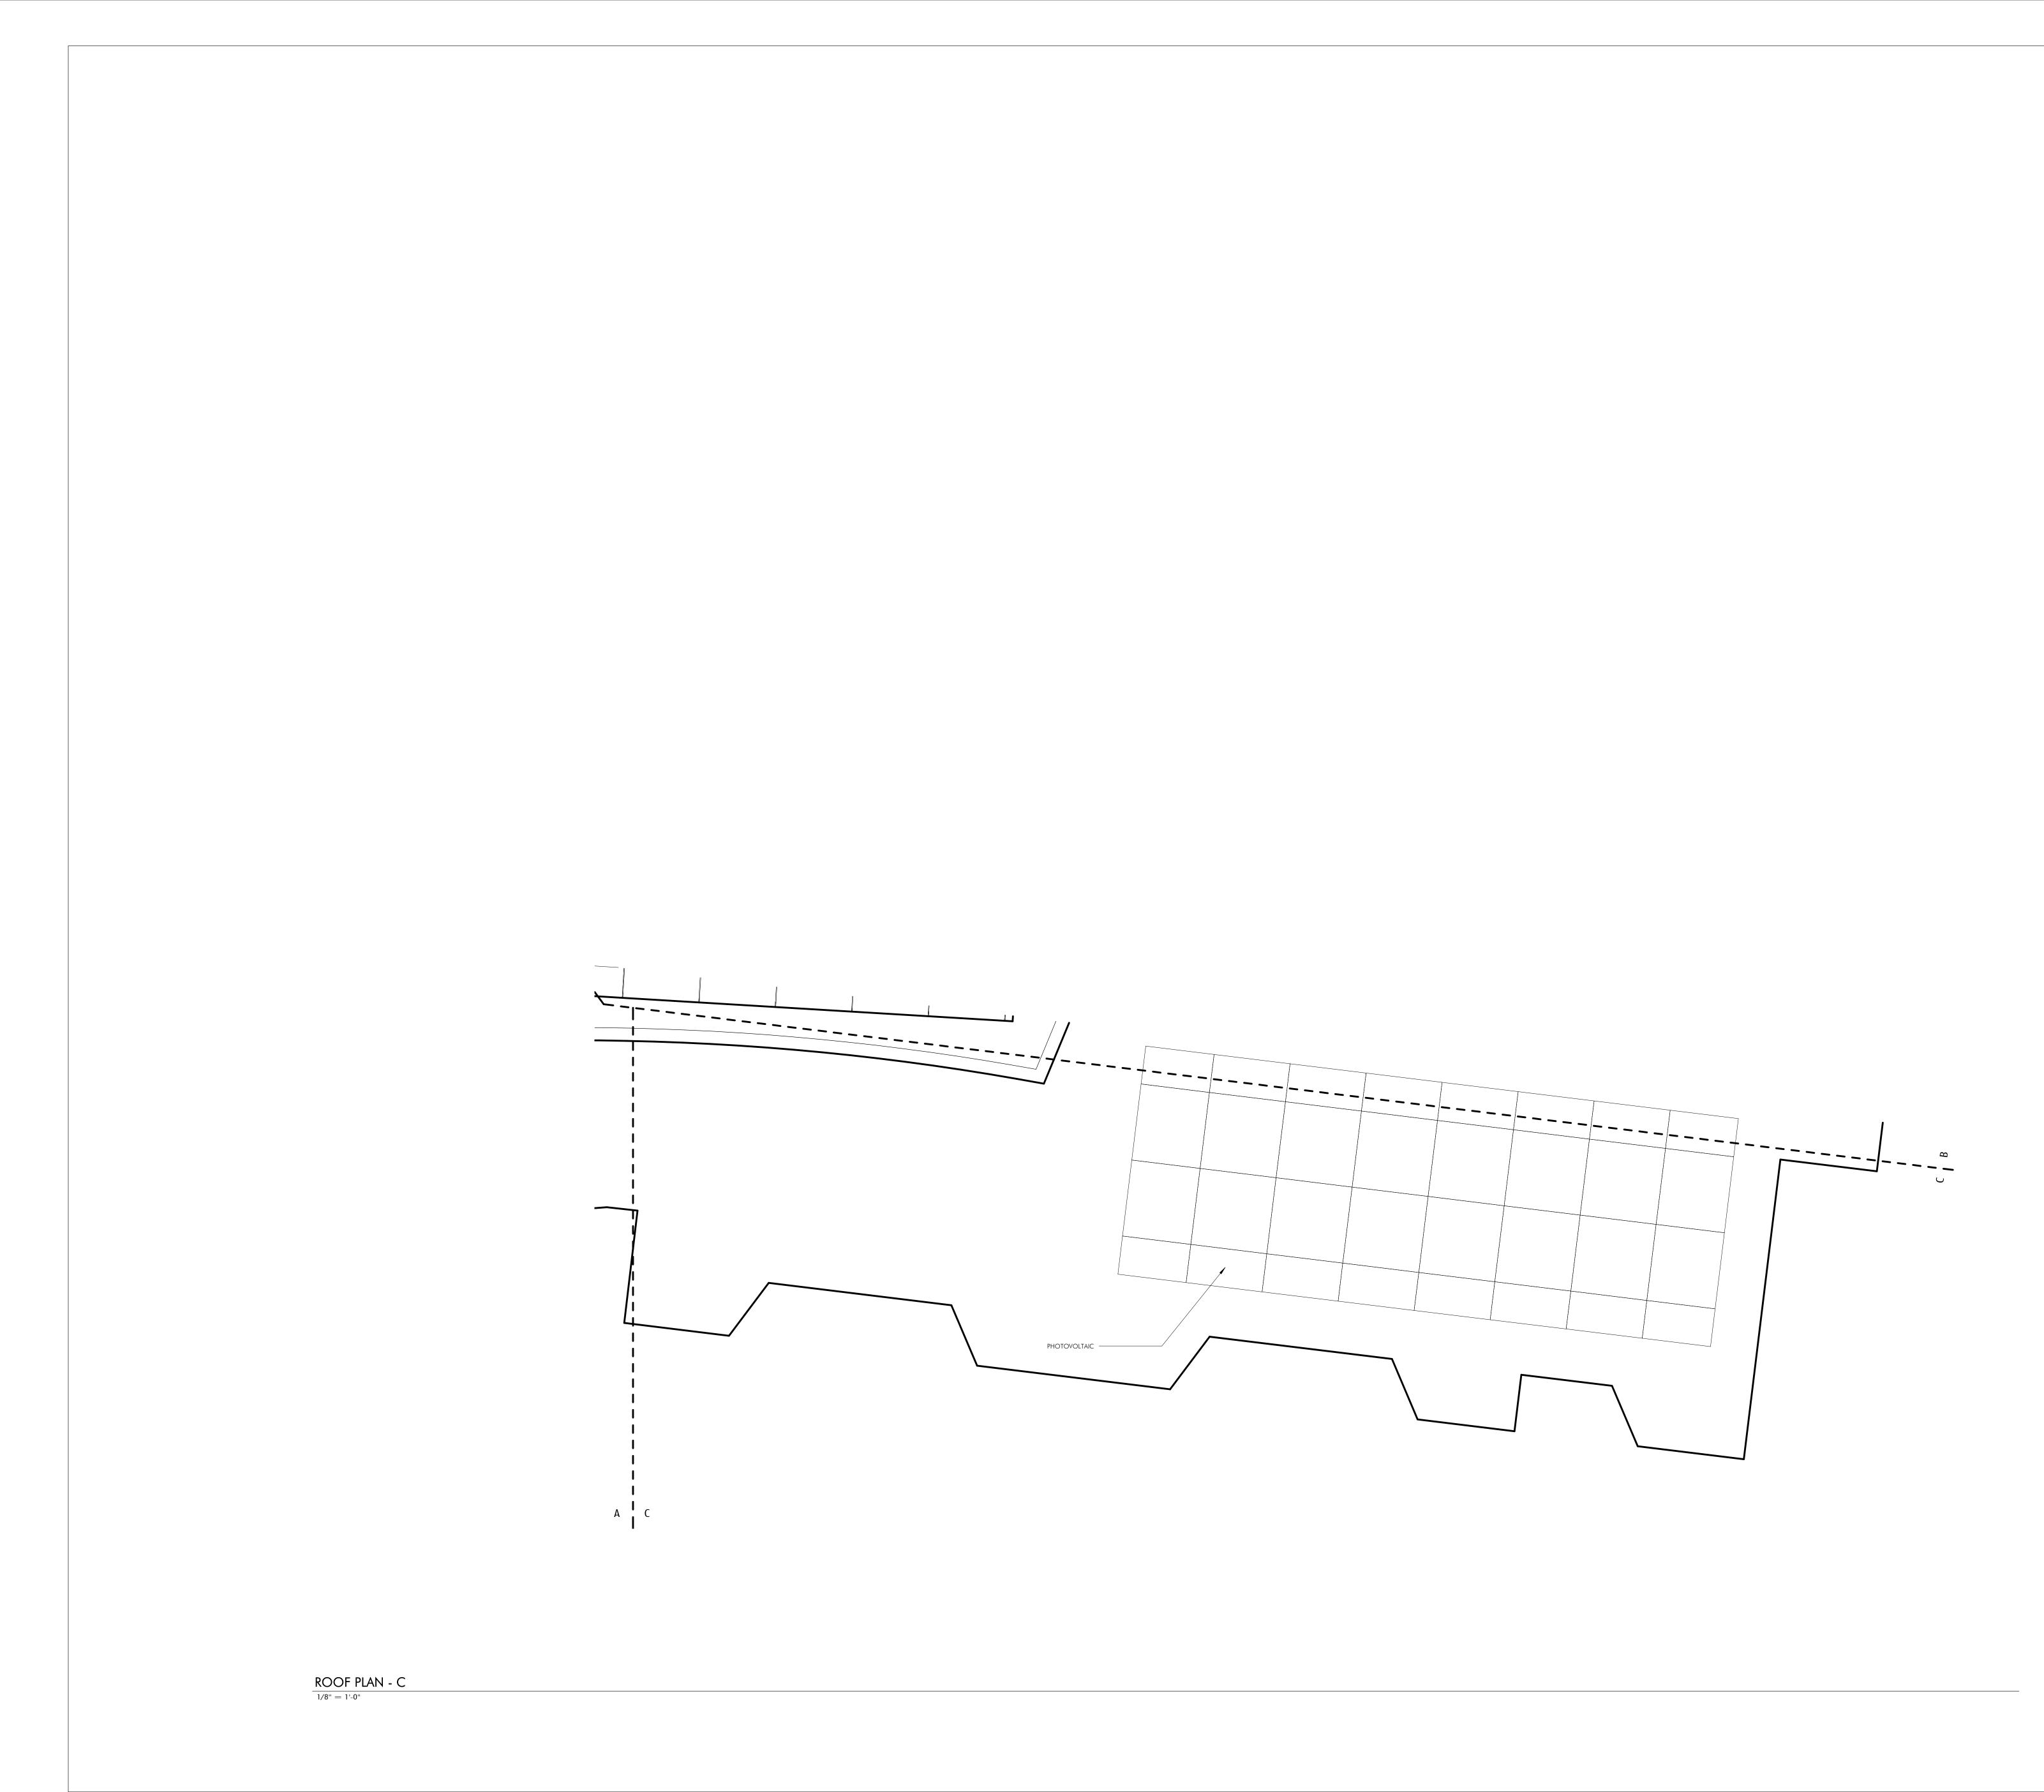


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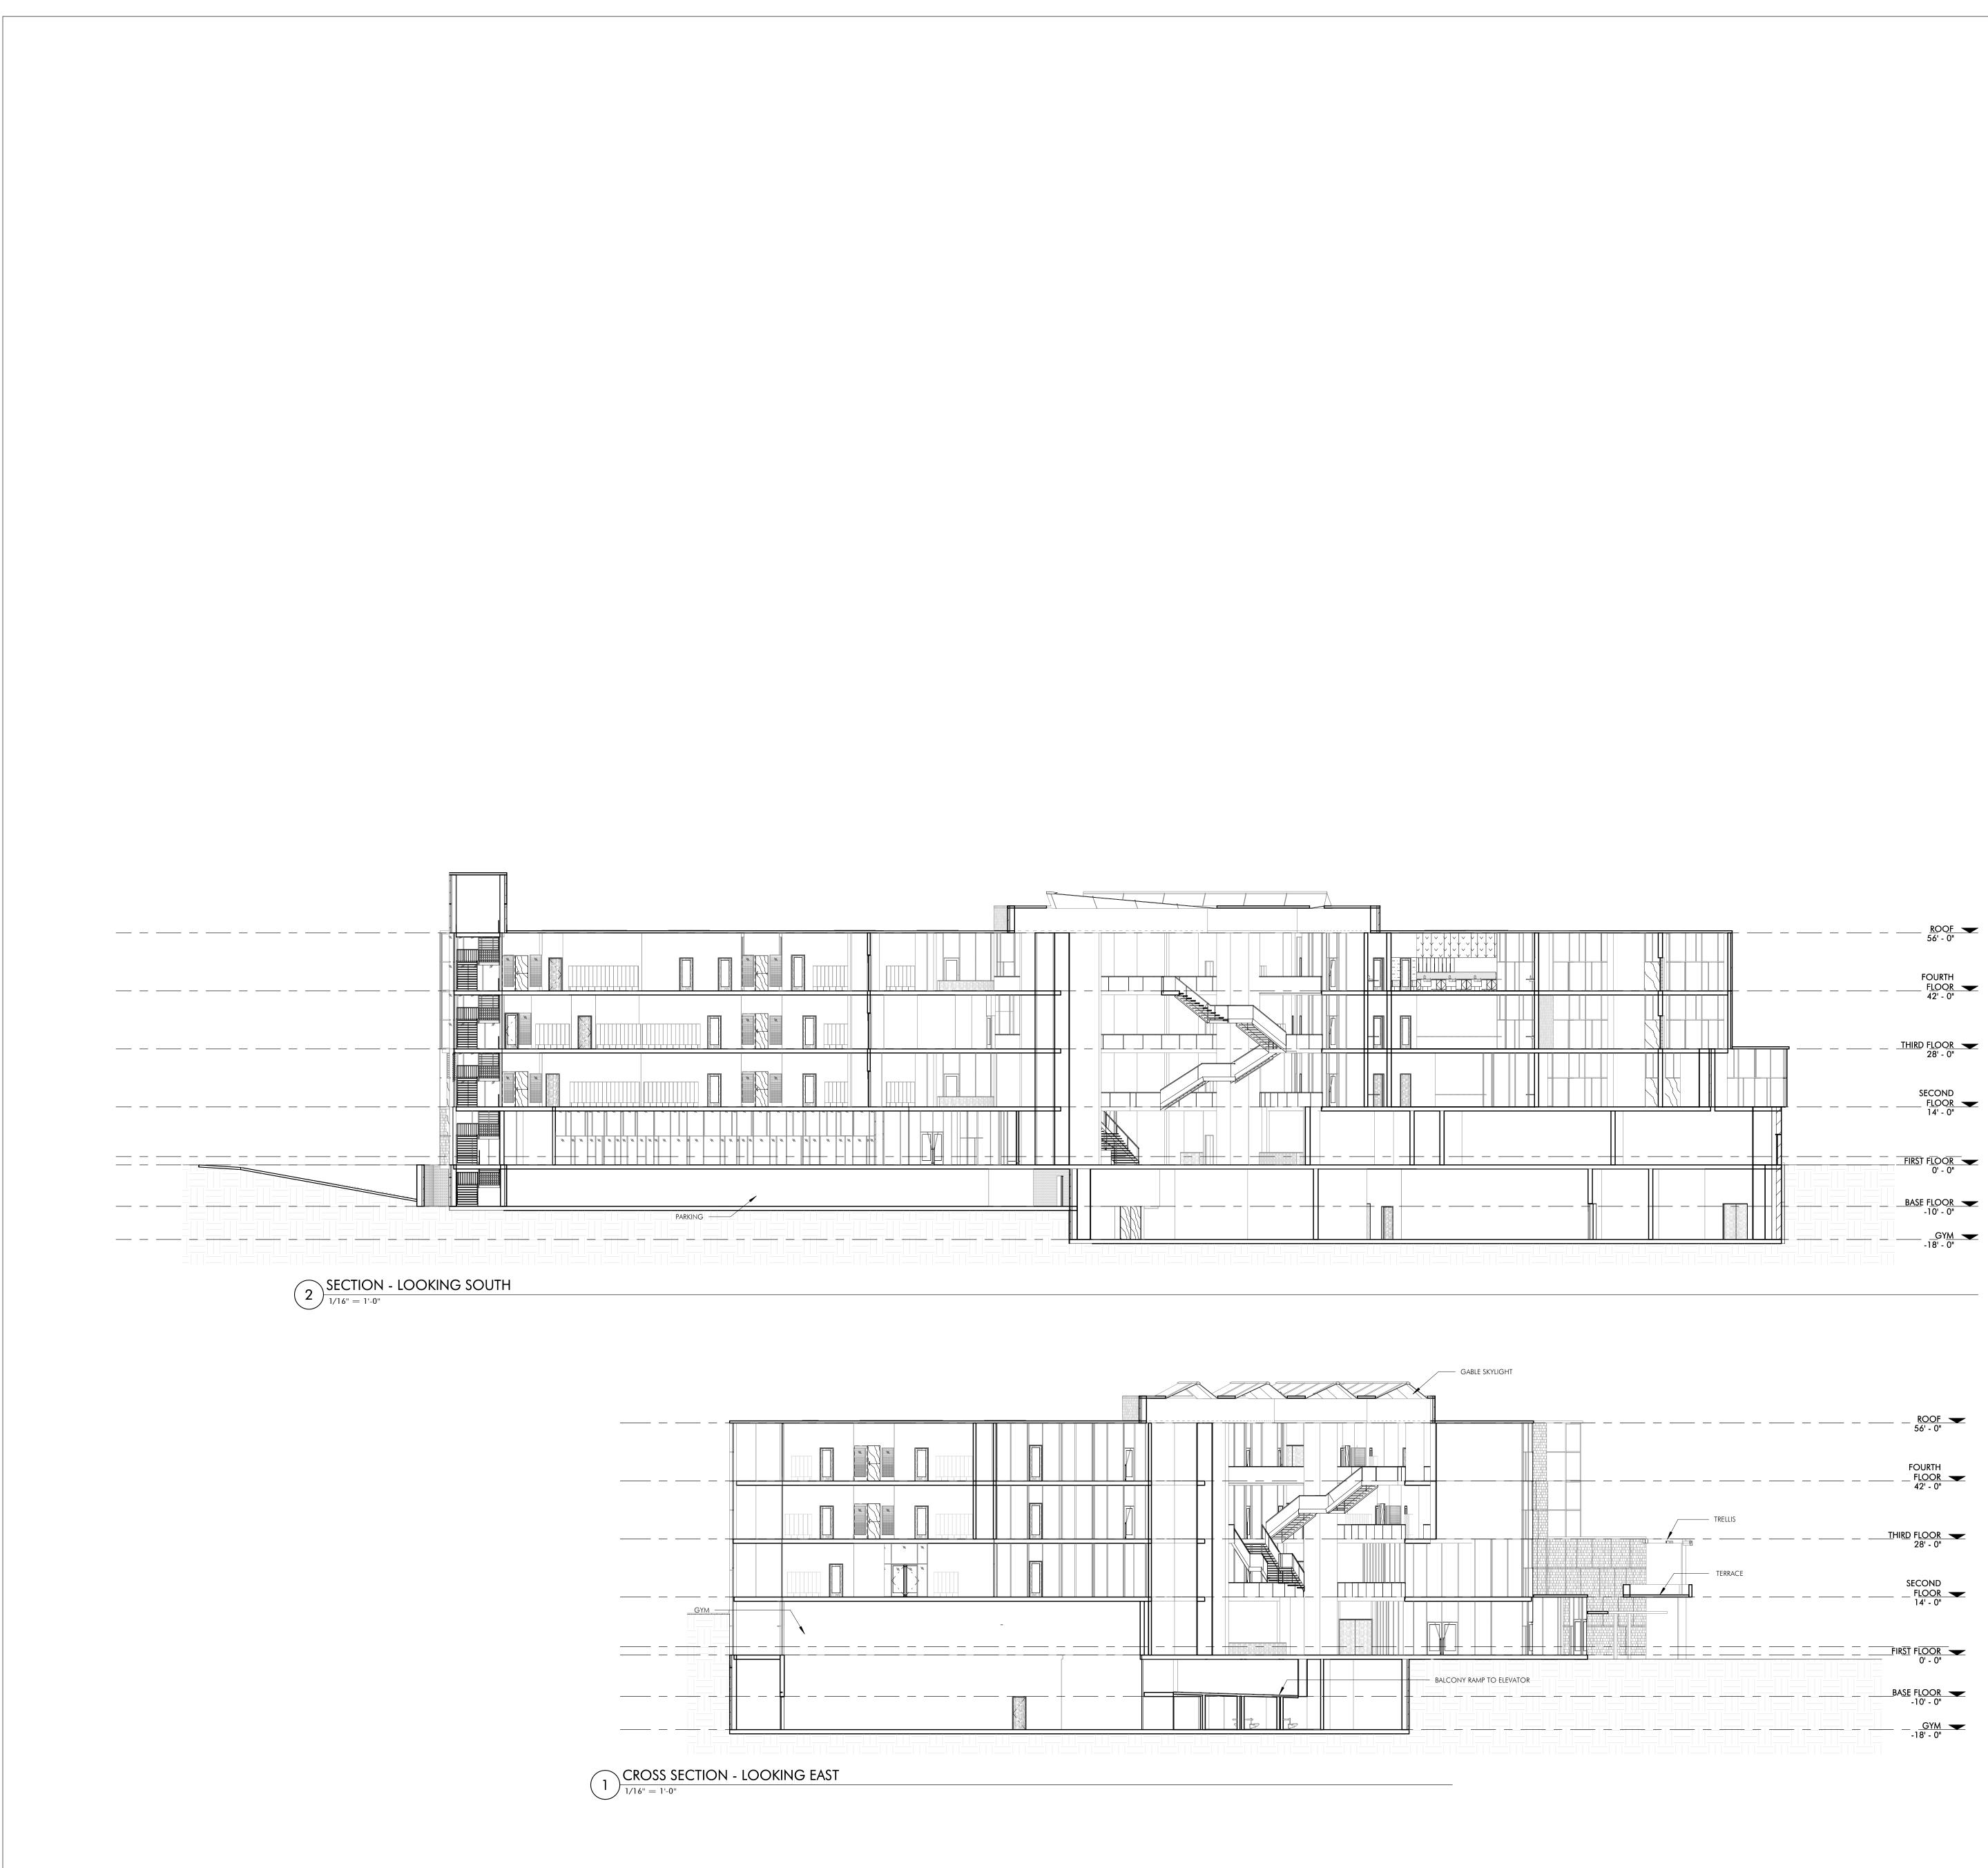


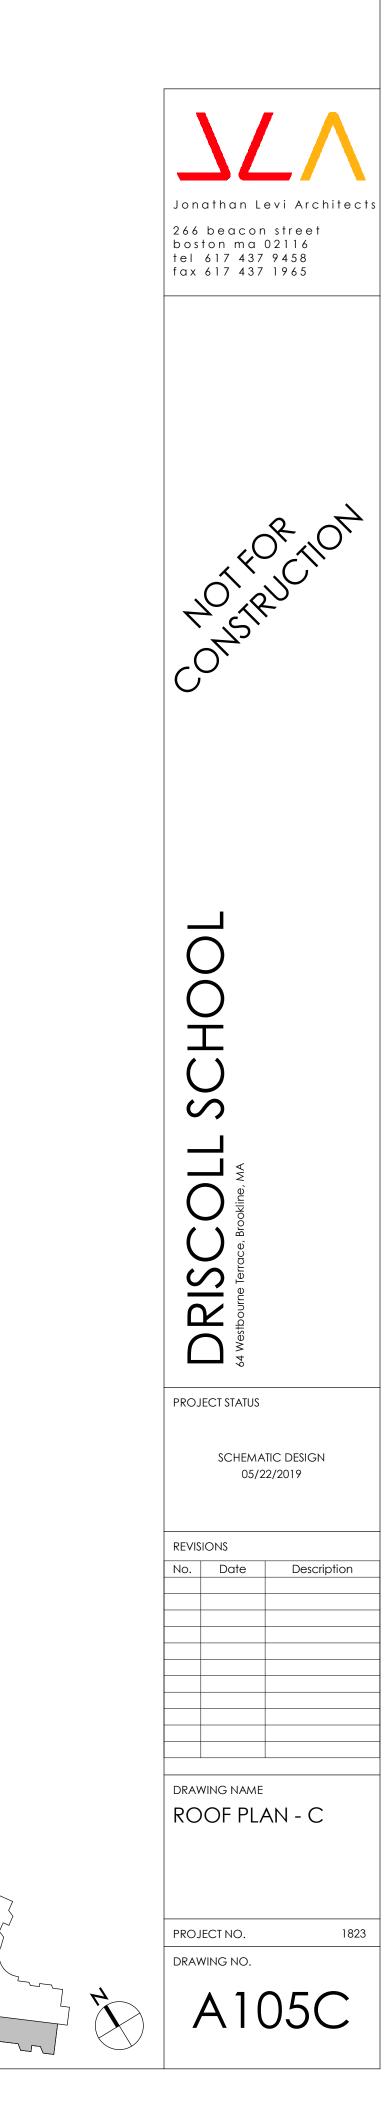

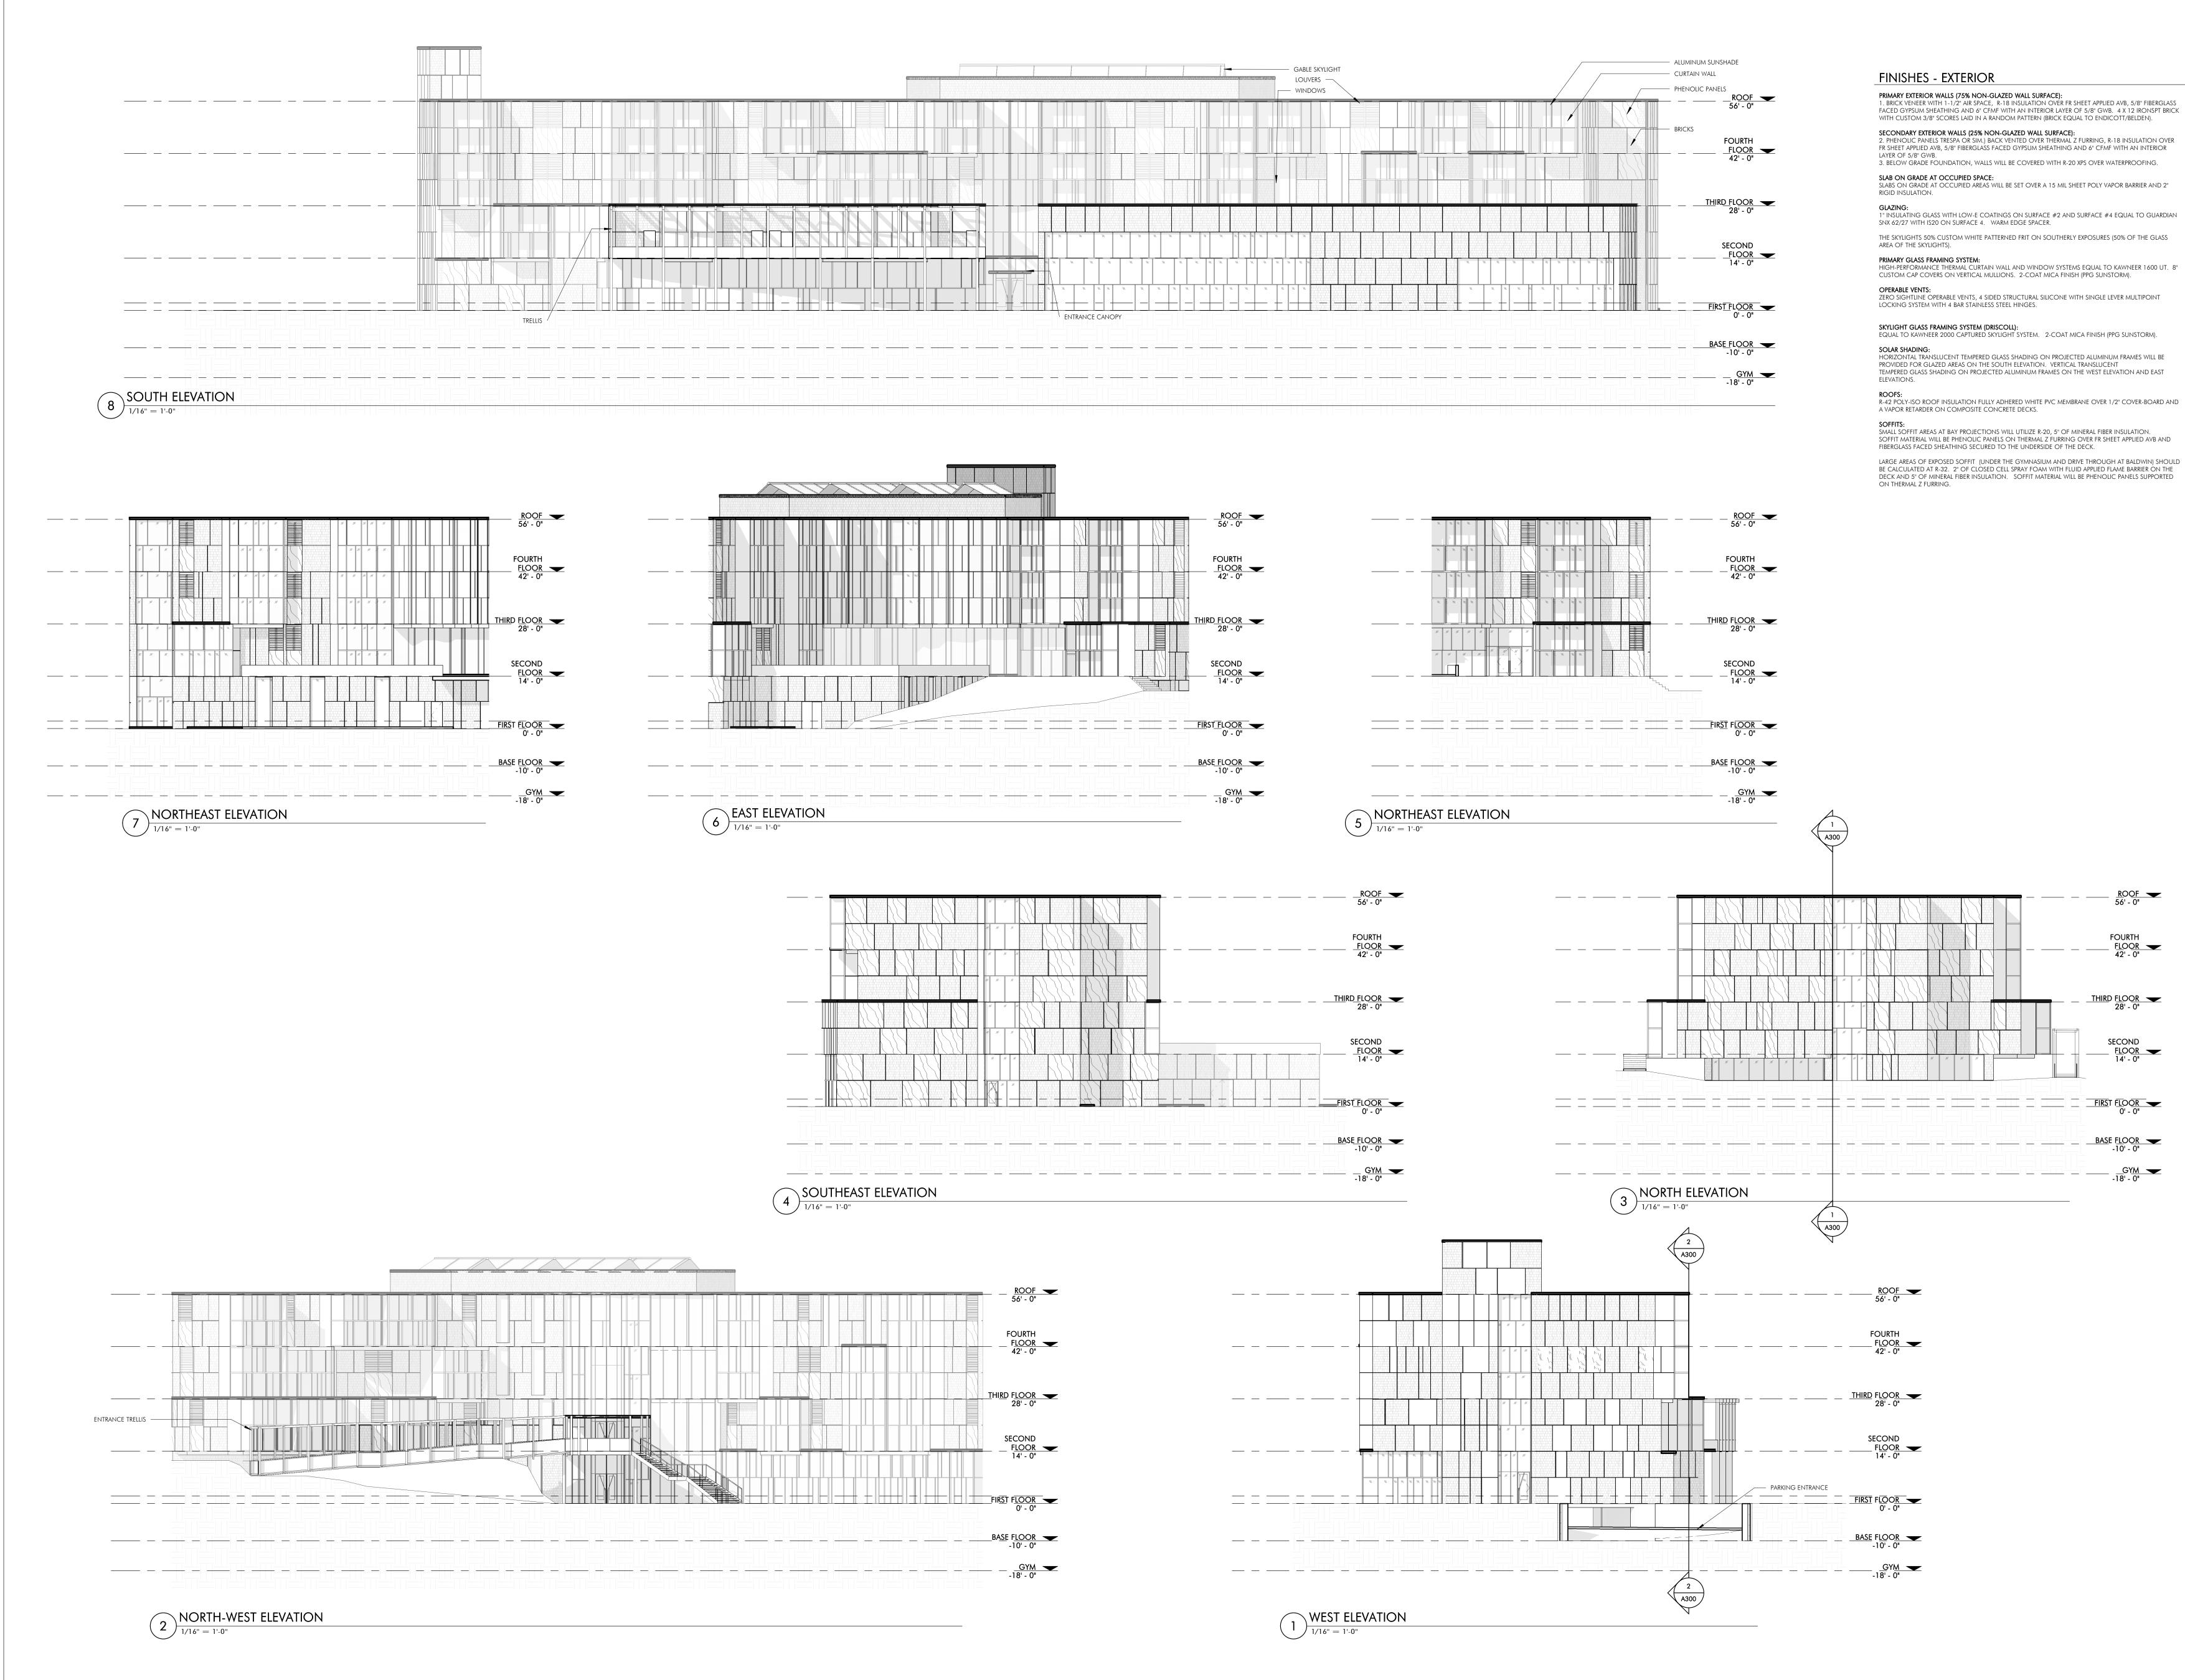


<u>ROOF</u> 56' - 0" FOURTH FLOOR 42' - 0" <u>THIRD</u> FLOOR 28' - 0" SECOND \_ F<u>LOOR</u> 14' - 0"

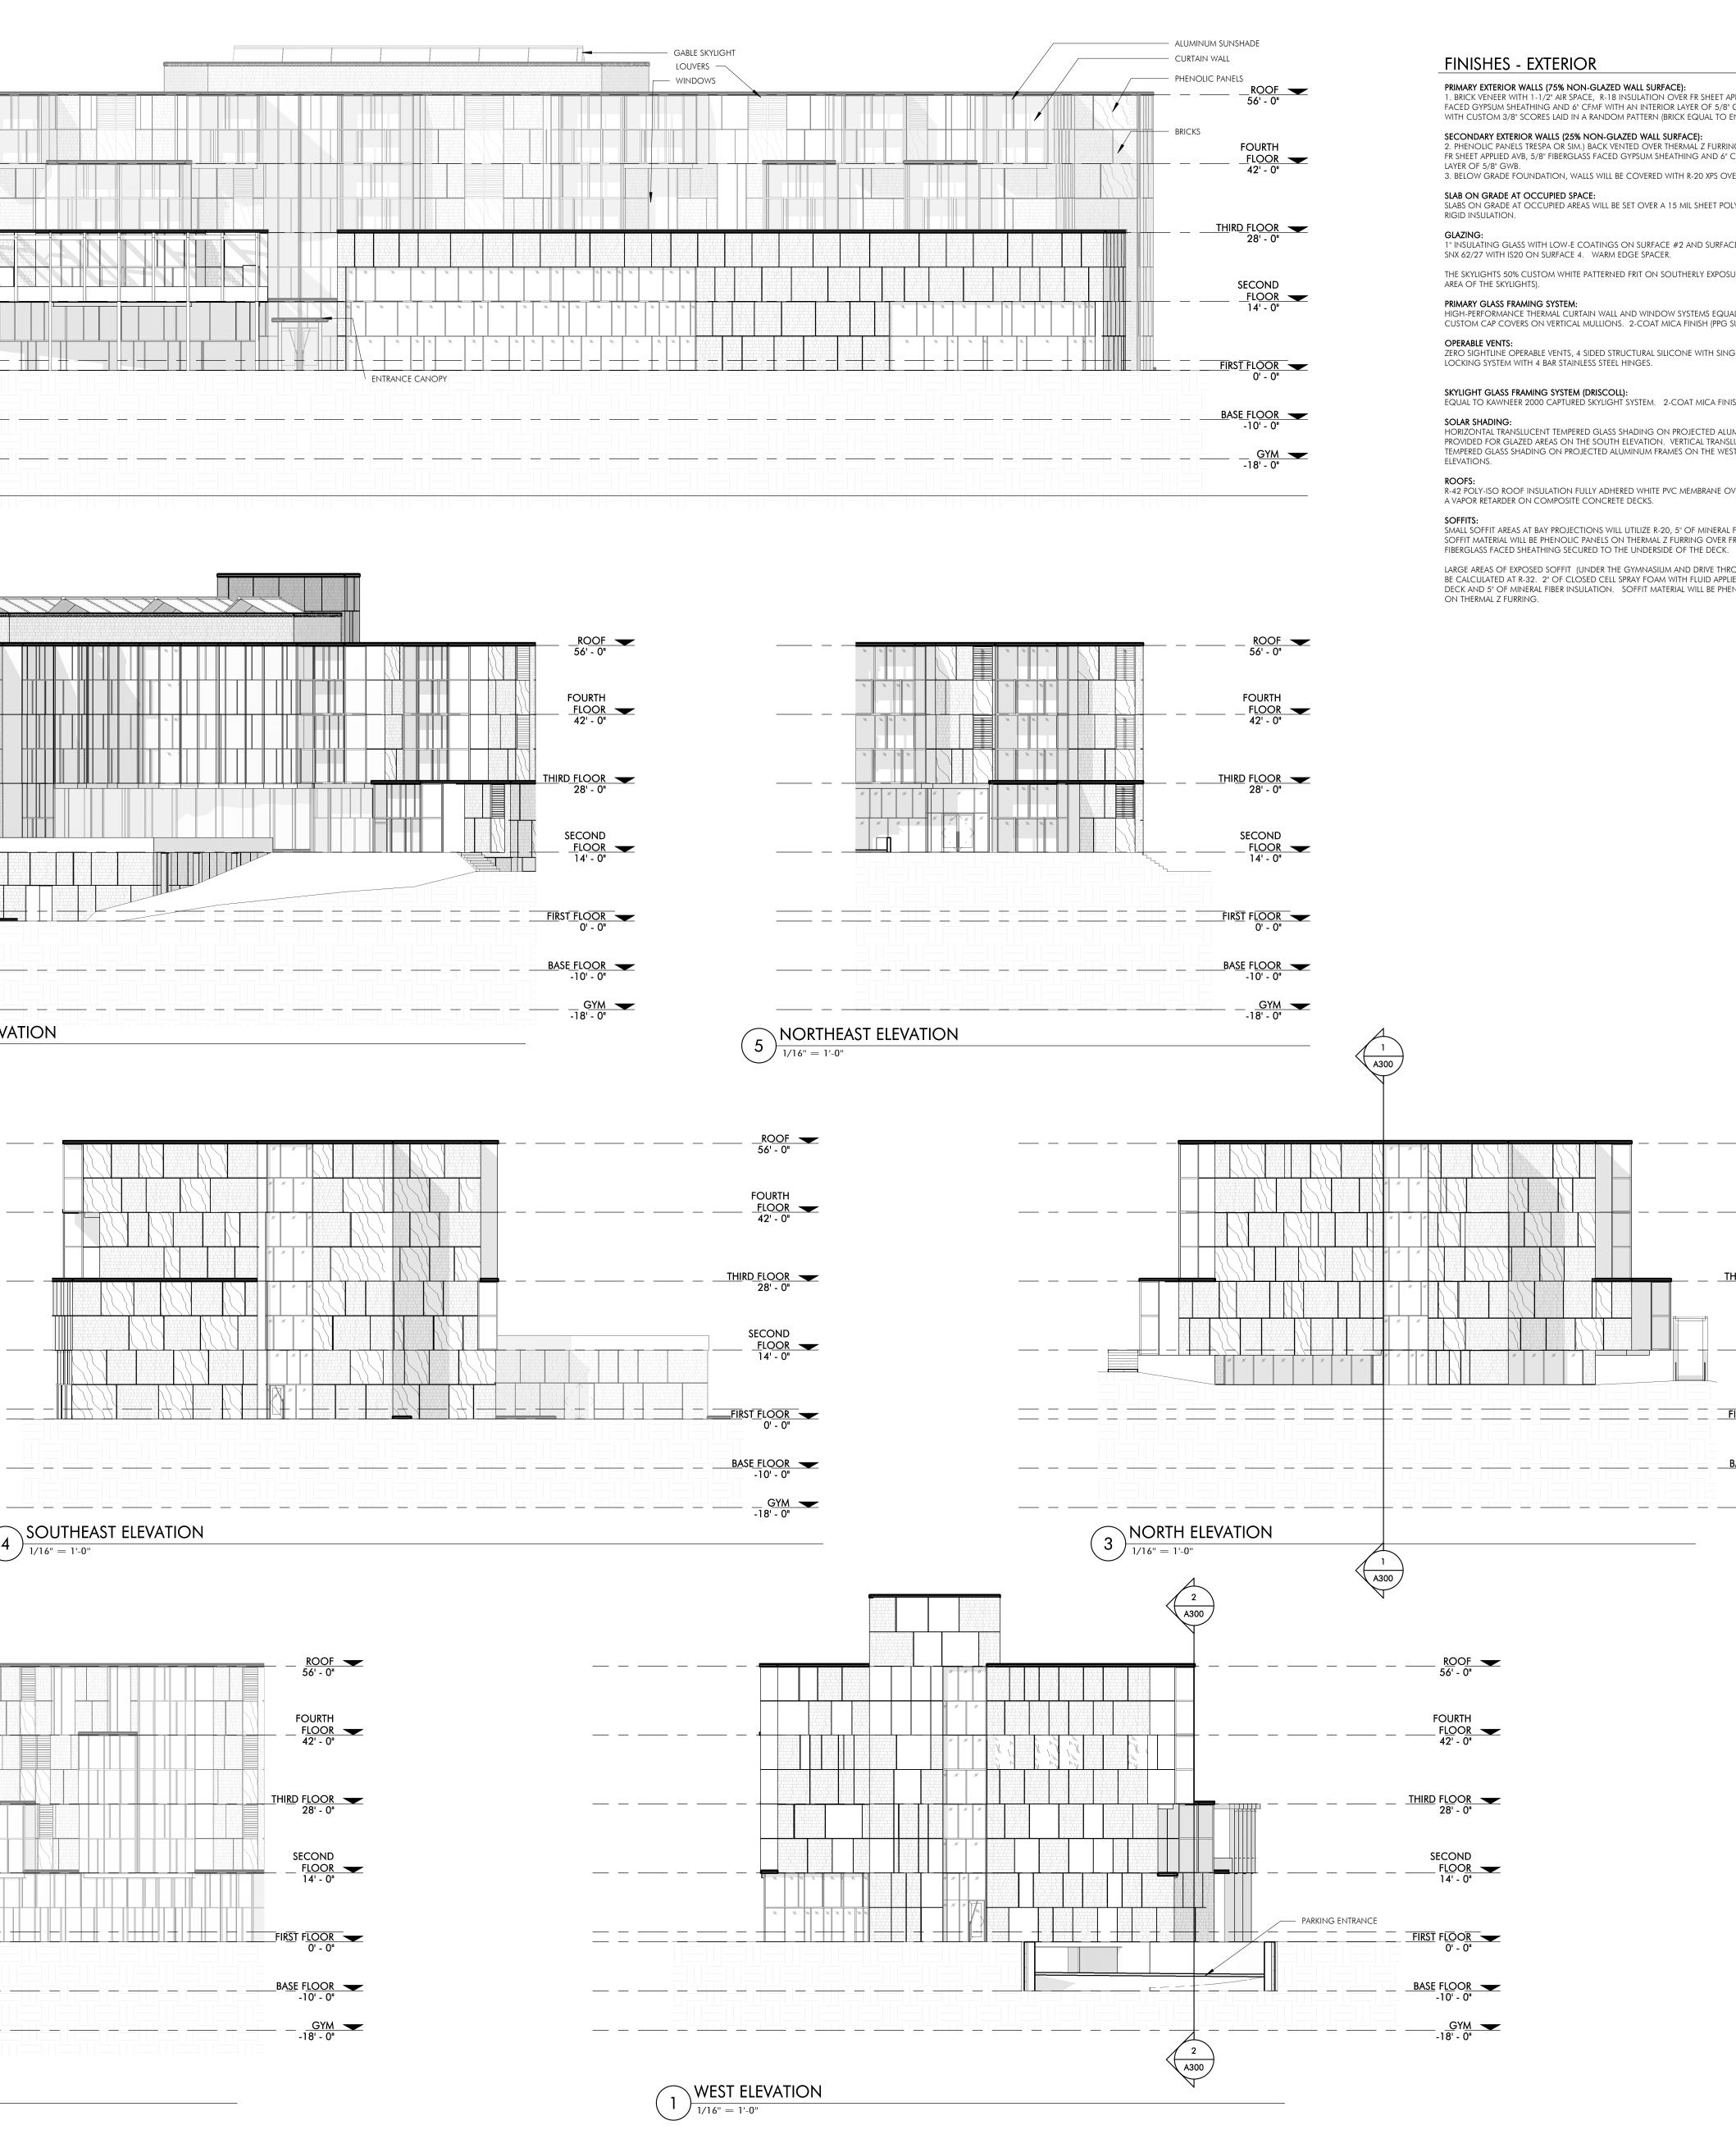
GYM 🔶




			 <u>ROOF</u> 56' - 0"
			 FOURTH F <u>LOOR</u> 42' - 0"
		TRELLIS	
			 <u>THIRD</u> F <u>LOOR</u> 28' - 0"
		- TERRACE	 SECOND F <u>LOOR</u> 14' - 0"
			FIR <u>ST</u> F <u>LOOR</u> 0' - 0"
TO ELEVATOR			BA <u>SE</u> F <u>LOOR</u> -10' - 0"
			<u>GYM</u>



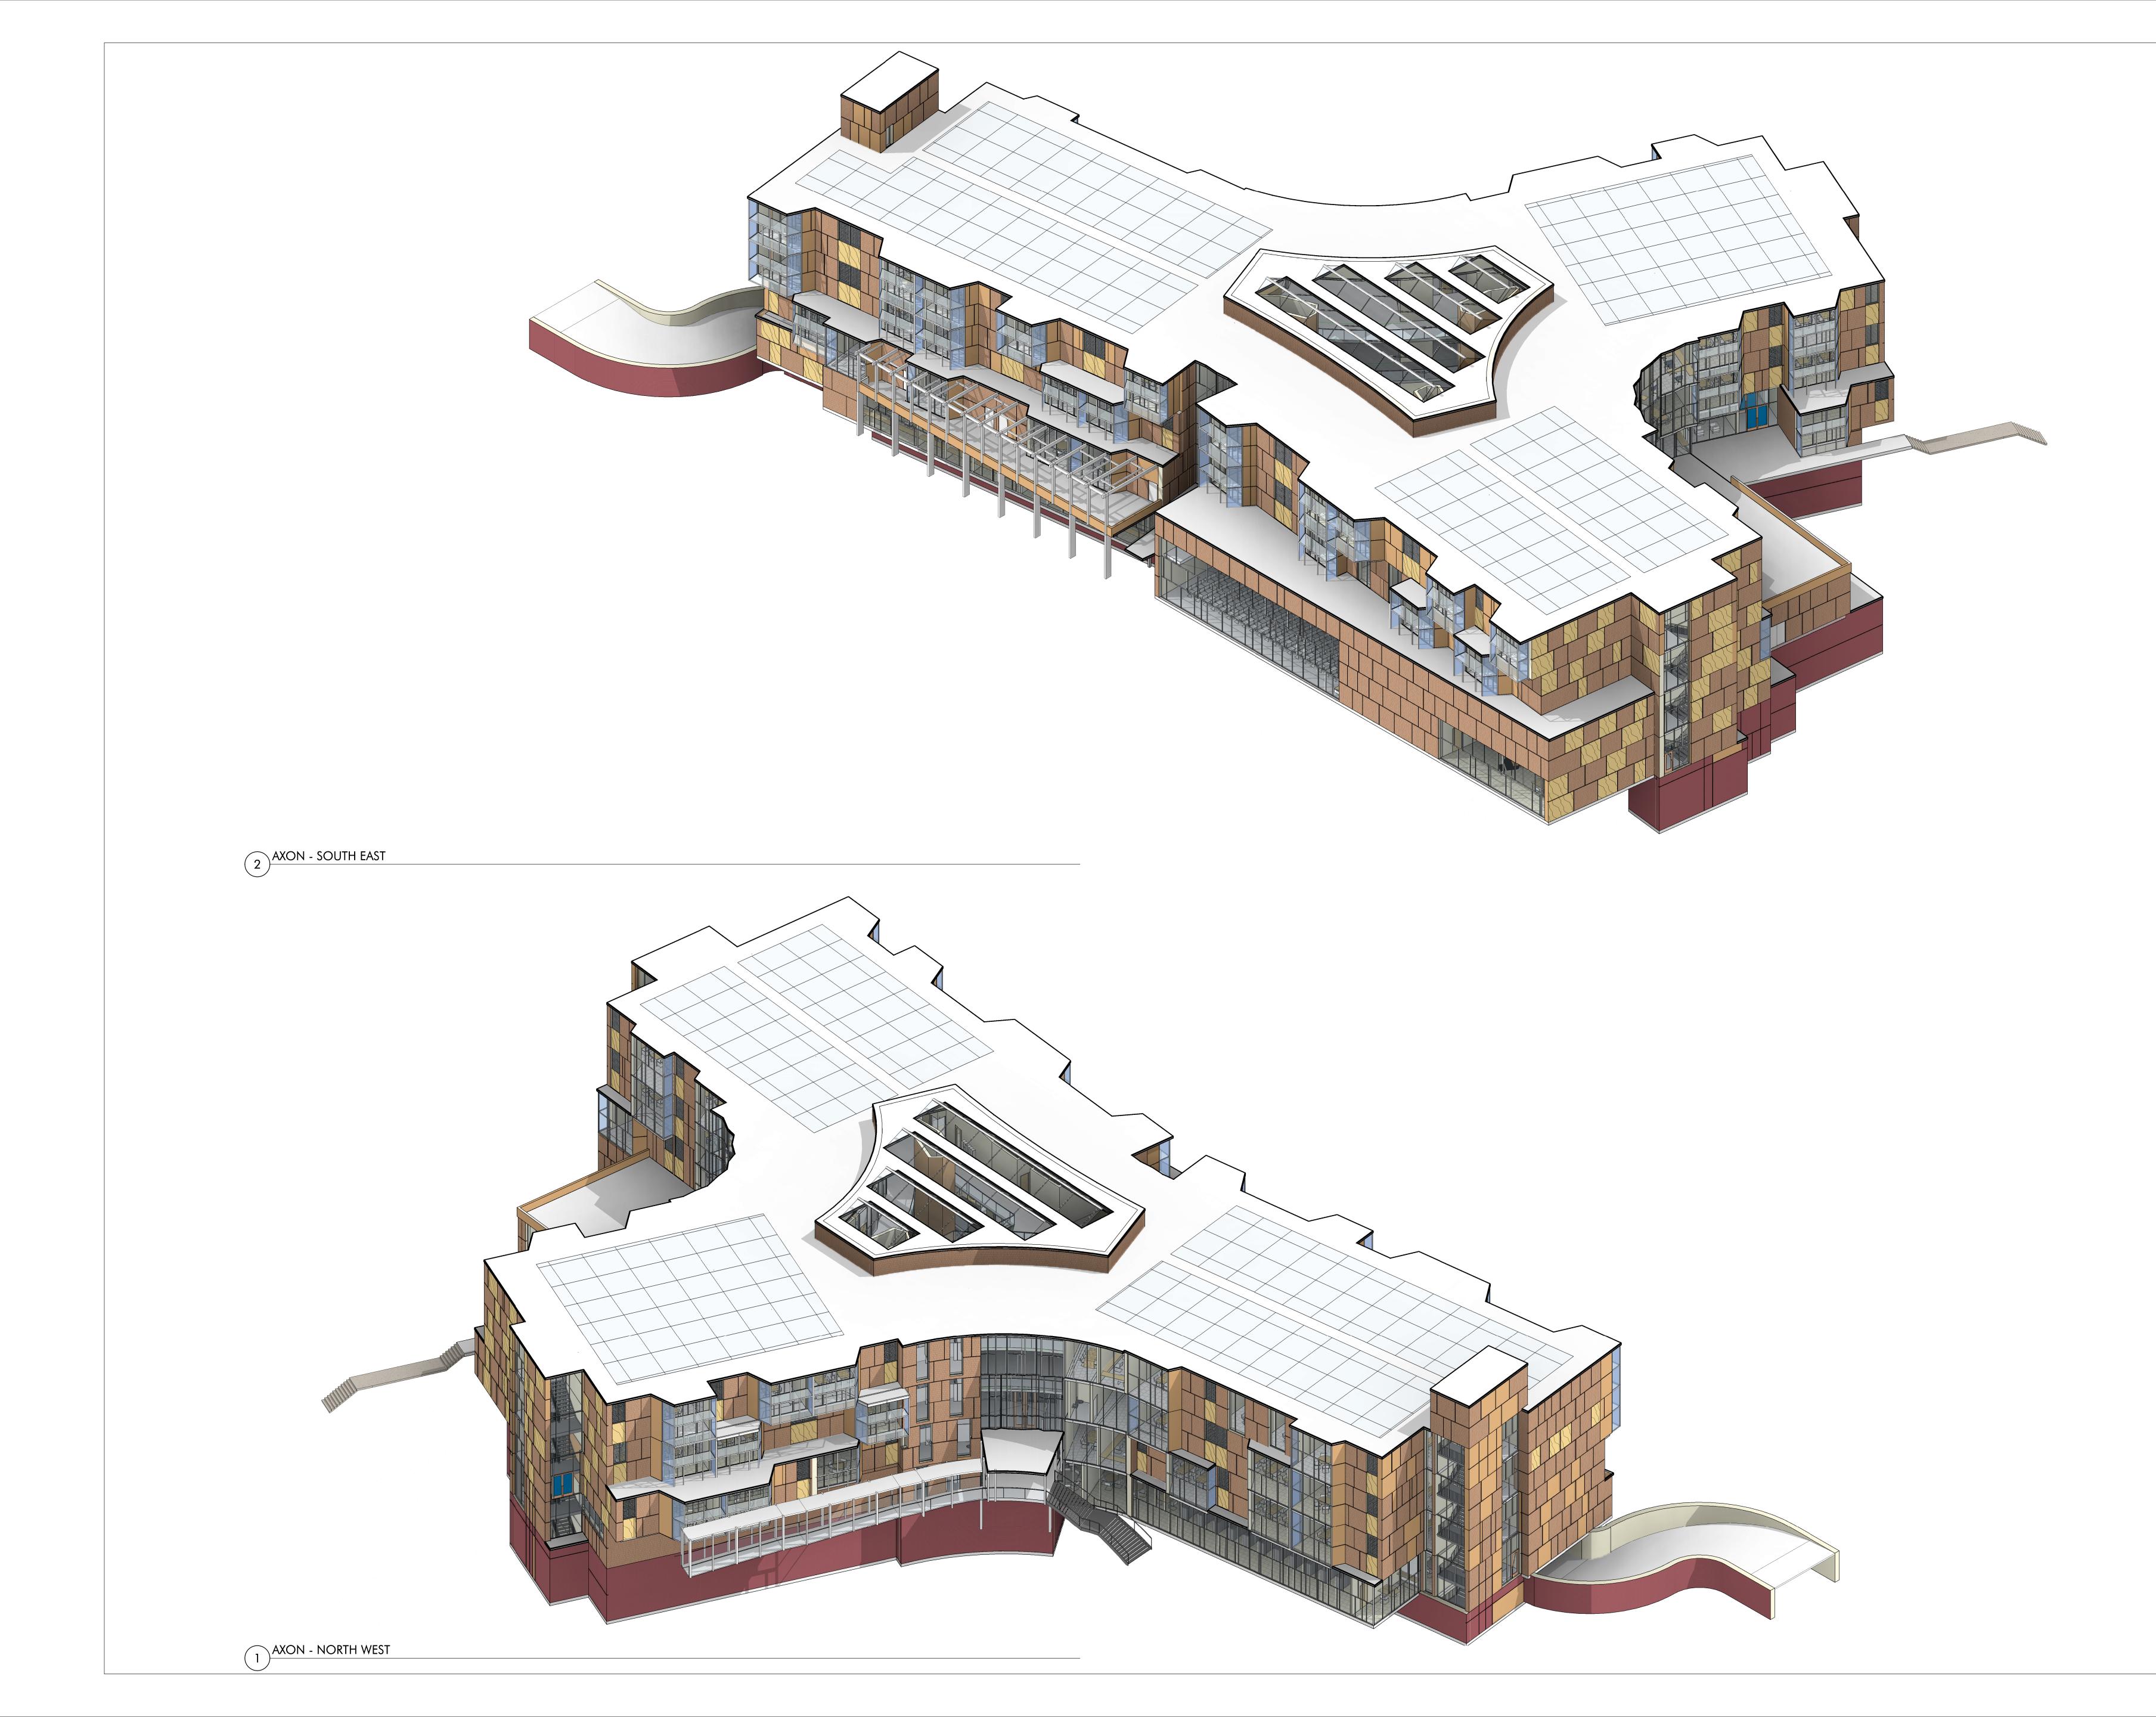

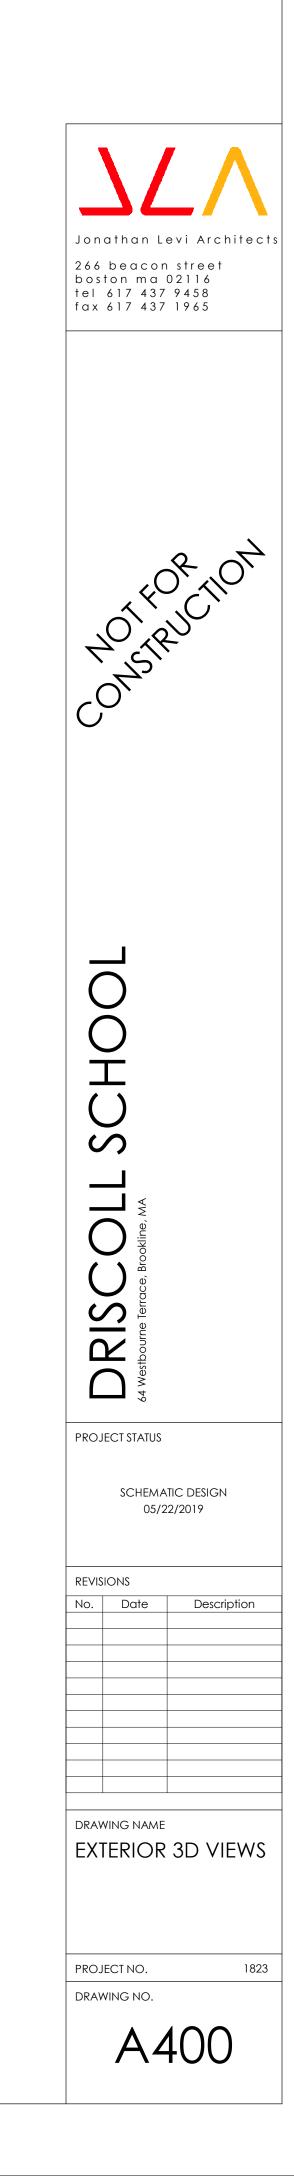

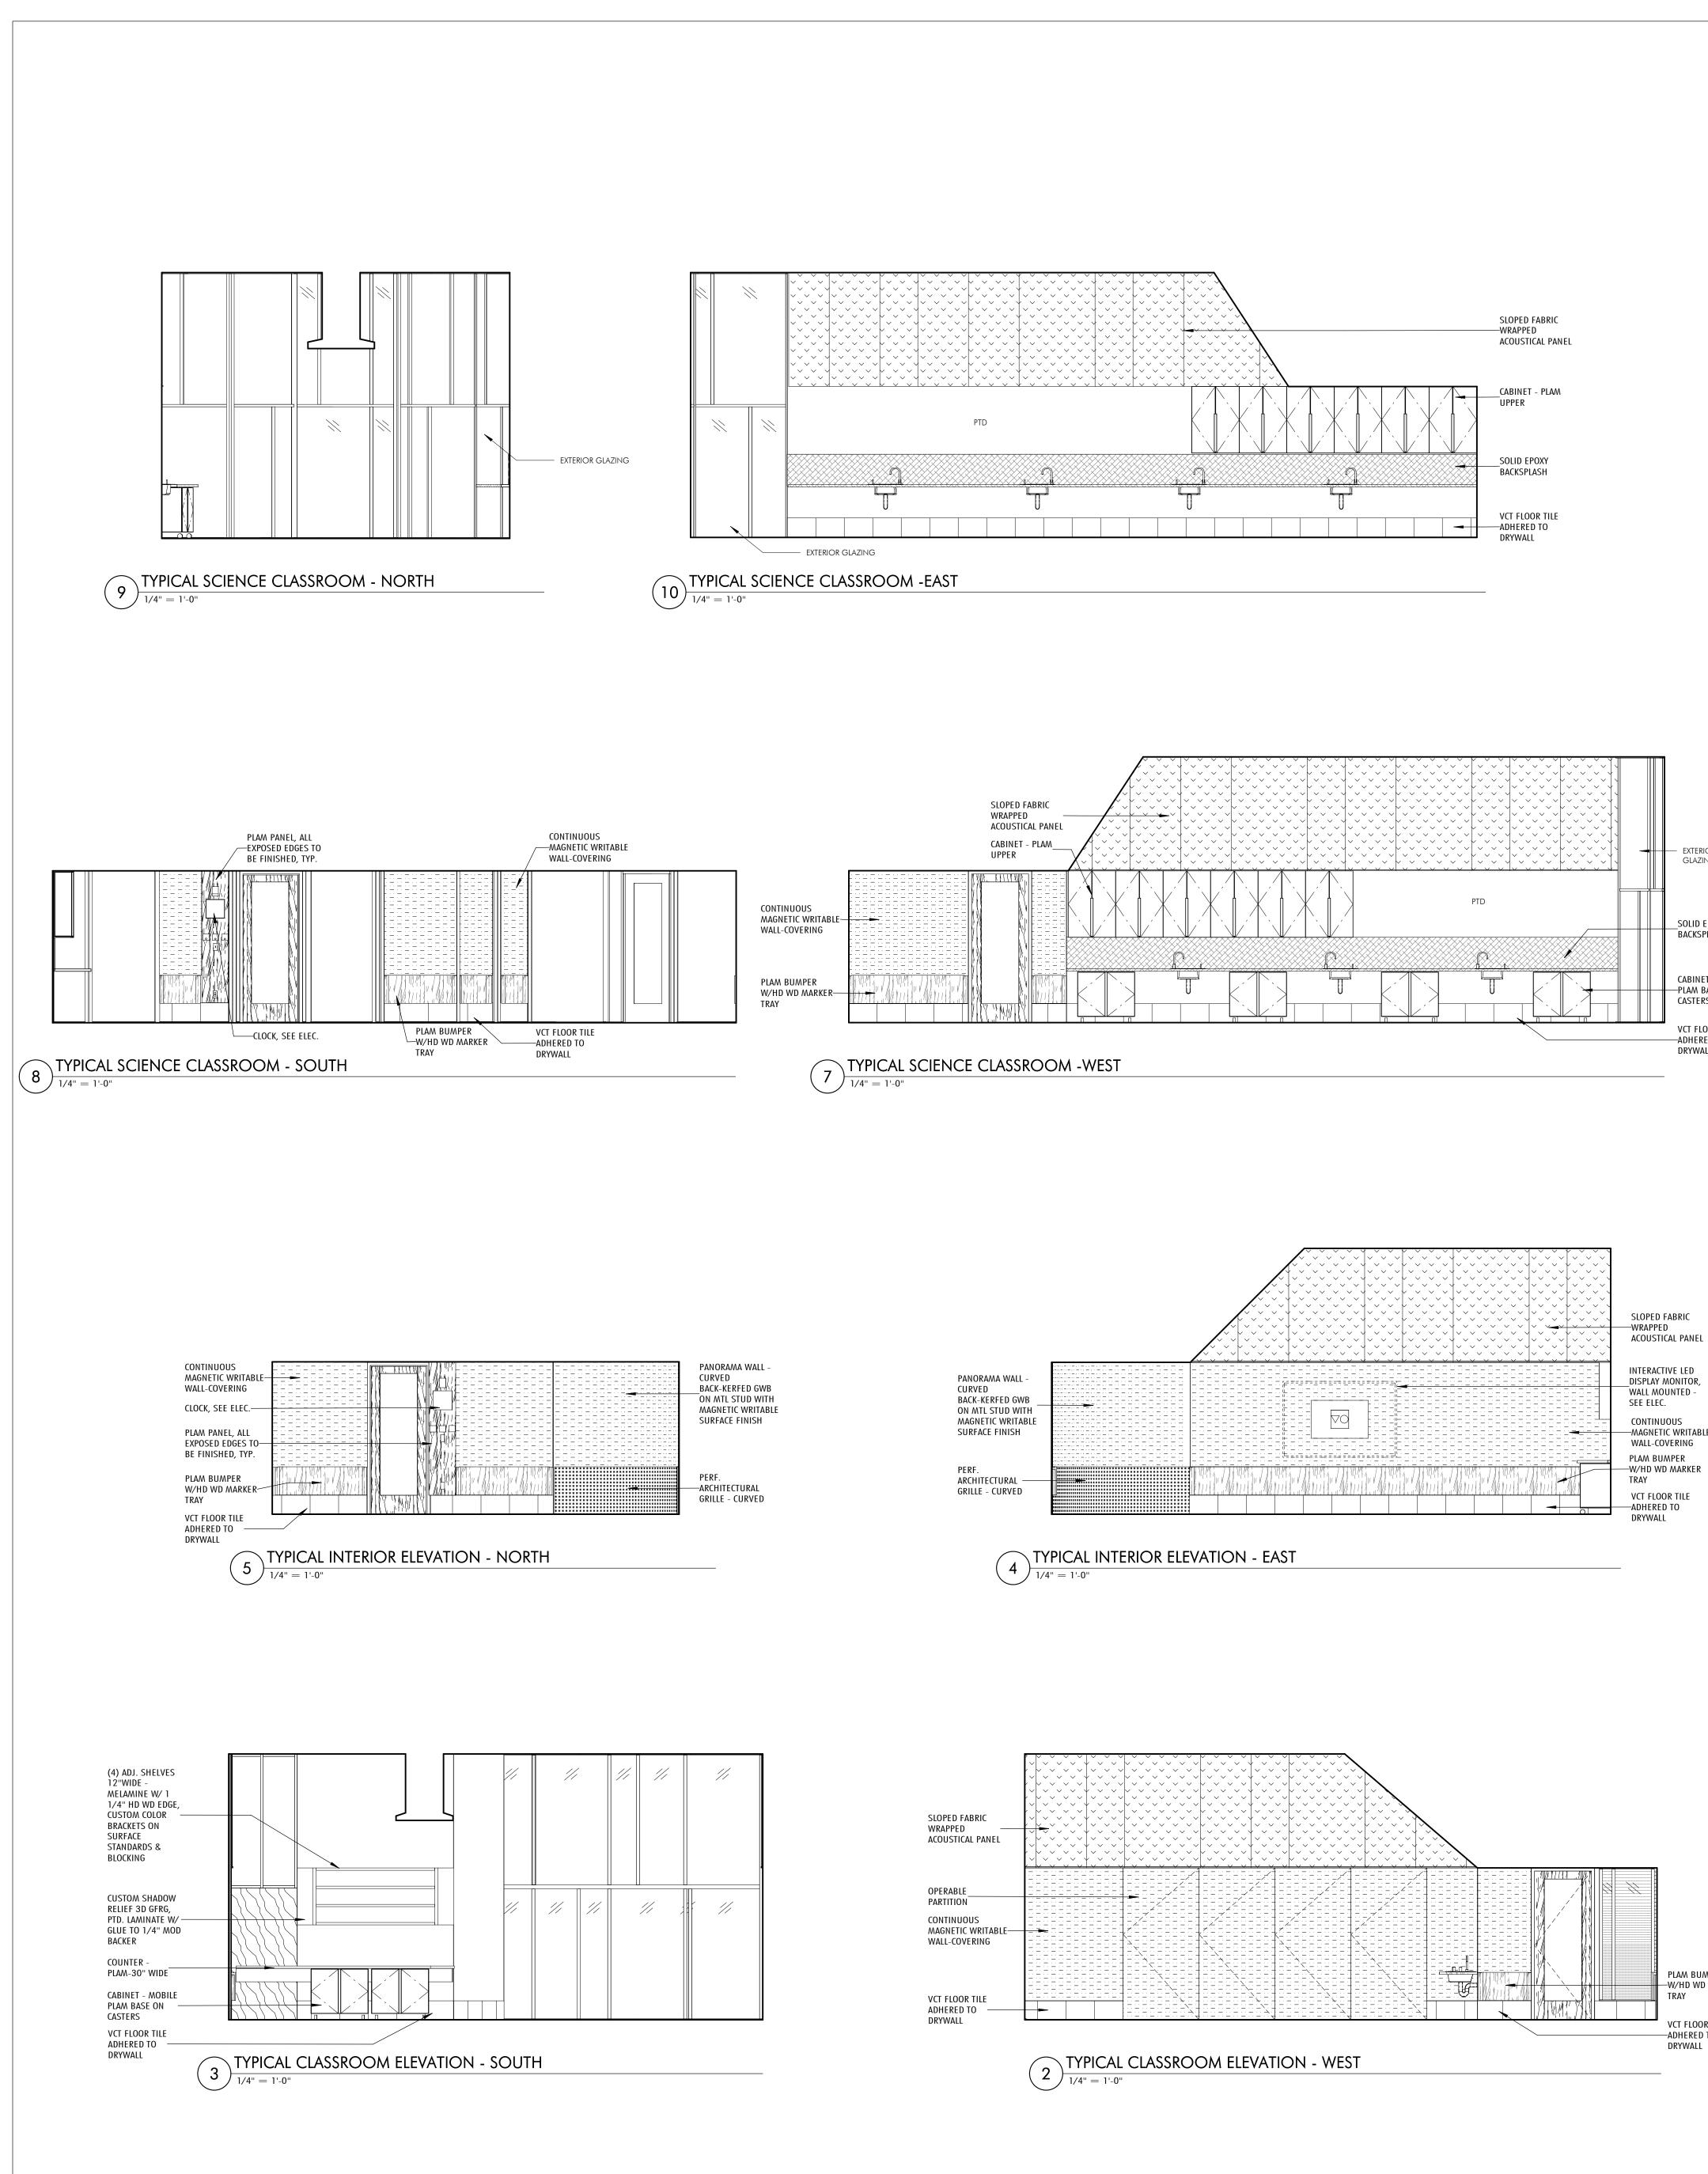

SLOPED FABRIC WRAPPED ACOUSTICAL PANEL		
OPERABLE PARTITION CONTINUOUS MAGNETIC WRITABLE WALL-COVERING		
VCT FLOOR TILE ADHERED TO DRYWALL	TYPICAL CLASSROOM ELEVATION - WEST	PLAM BUMPER —W/HD WD MARKER TRAY VCT FLOOR TILE —ADHERED TO DRYWALL

PANORAMA WALL - CURVED BACK-KERFED GWB ON MTL STUD WITH MAGNETIC WRITABLE SURFACE FINISH				
PERF. ARCHITECTURAL GRILLE - CURVED				
	PICAL INTERIOR ELE	VATION - EA	ST	


-WRAPPED ACOUSTICAL PANEL INTERACTIVE LED \_\_\_\_DISPLAY MONITOR, WALL MOUNTED -SEE ELEC. CONTINUOUS WALL-COVERING PLAM BUMPER ——W/HD WD MARKER TRAY

— EXTERIOR GLAZING


SOLID EPOXY BACKSPLASH


VCT FLOOR TILE —ADHERED TO DRYWALL




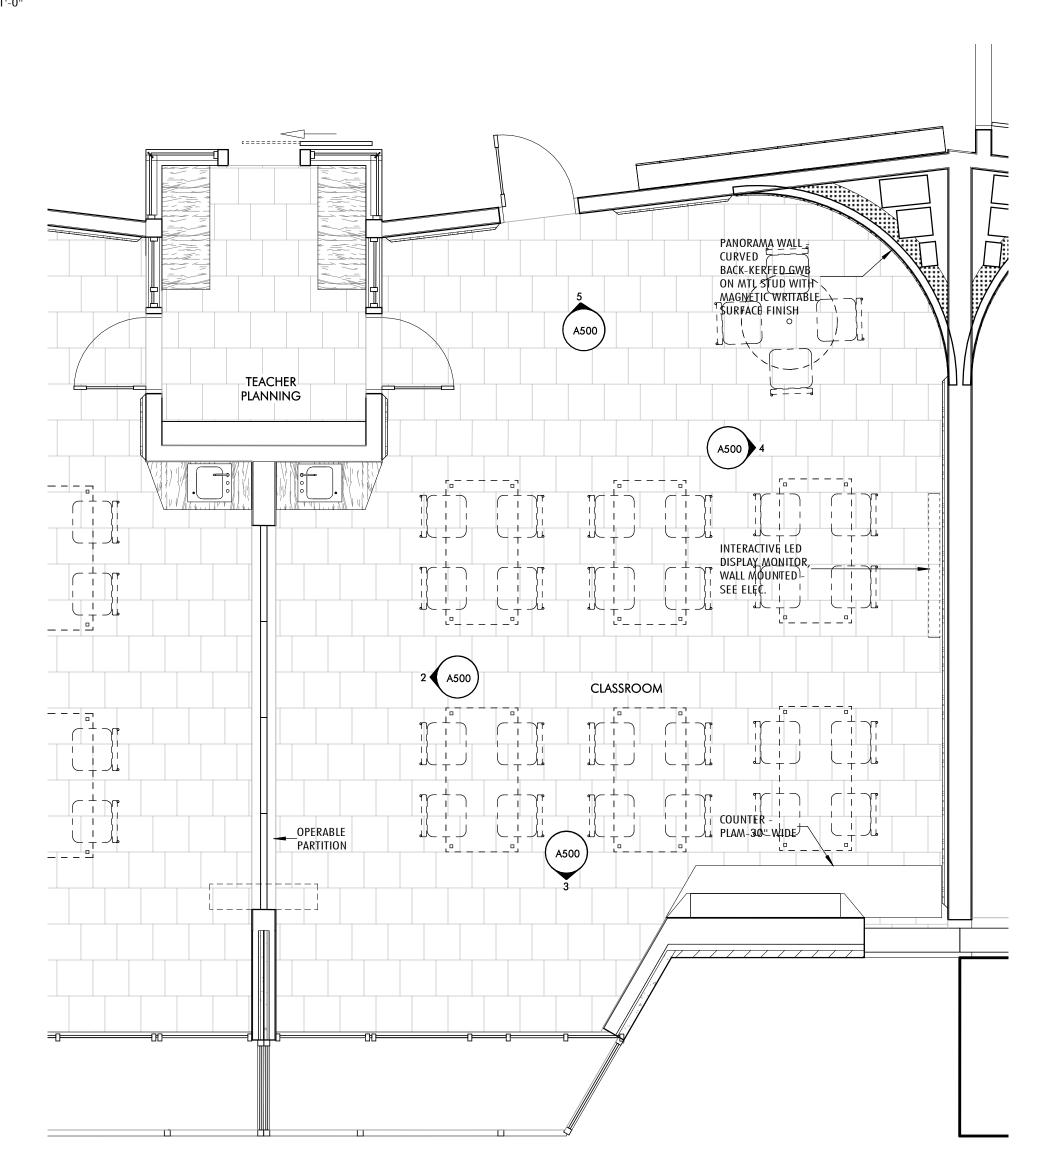




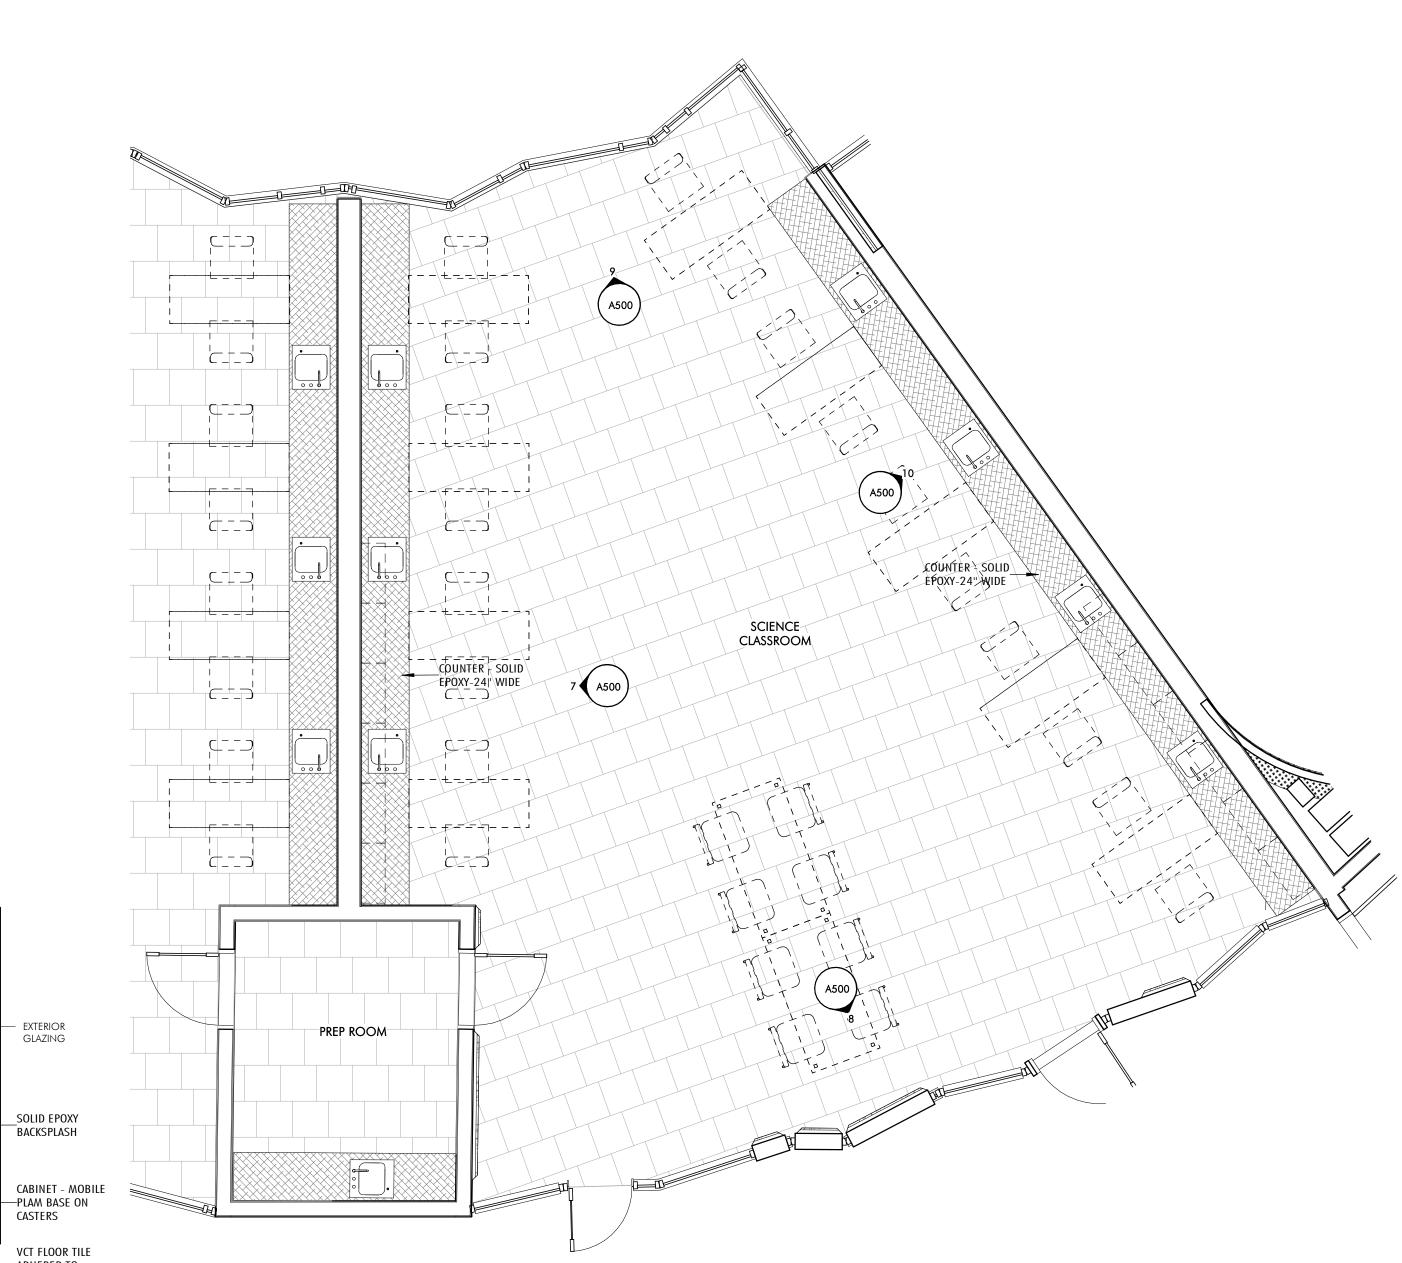

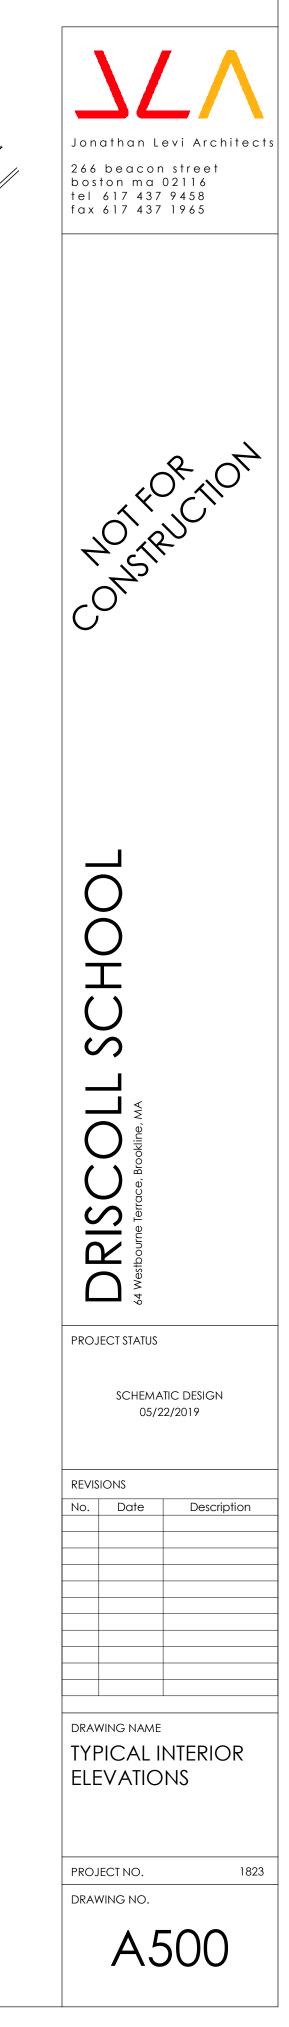

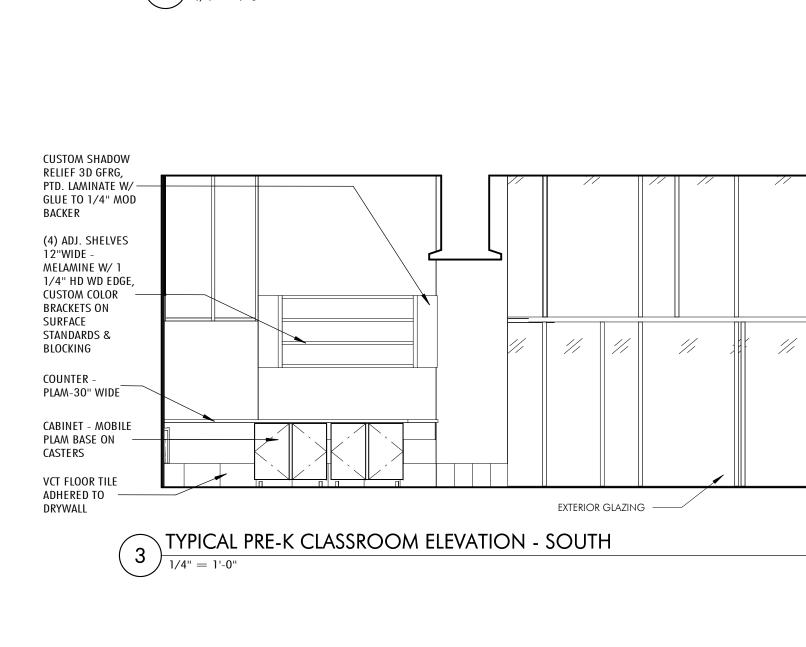



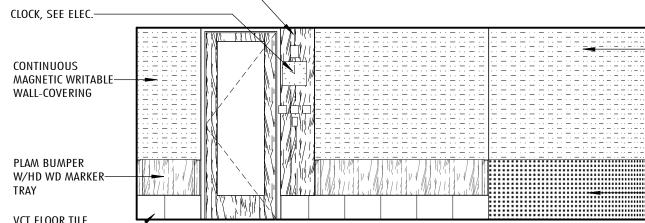


PLAM PANEL, ALL EXPOSED EDGES TO— BE FINISHED, TYP.

LOPED FABRIC VRAPPED COUSTICAL PANEL	
ONTINUOUS MAGNETIC WRITABLE VALL-COVERING	
LAM BUMPER V/HD WD MARKER RAY	


# 4 TYPICAL PRE-K CLASSROOM ELEVATION - EAST 1/4" = 1'-0"

PANORAMA WALL -								
CURVED BACK-KERFED GWB ON MTL STUD WITH MAGNETIC WRITABLE SURFACE FINISH	PANORAMA WALL - CURVED BACK-KERFED GWB ON MTL STUD WITH MAGNETIC WRITABLE				√0			
PERF. ——ARCHITECTURAL GRILLE - CURVED	PERF.							<u>7/14</u> P 114 V 114 T

# $1 \frac{\text{TYPICAL PRE-K CLASSROOM}}{1/4" = 1'-0"}$

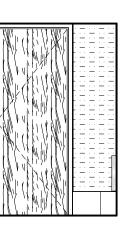

SLOPED FABRIC WRAPPED ACOUSTICAL PANEL INTERACTIVE LED DISPLAY MONITOR, WALL MOUNTED -SEE ELEC. CONTINUOUS MAGNETIC WRITABLE WALL-COVERING PLAM BUMPER W/HD WD MARKER TRAY VCT FLOOR TILE ADHERED TO DRYWALL

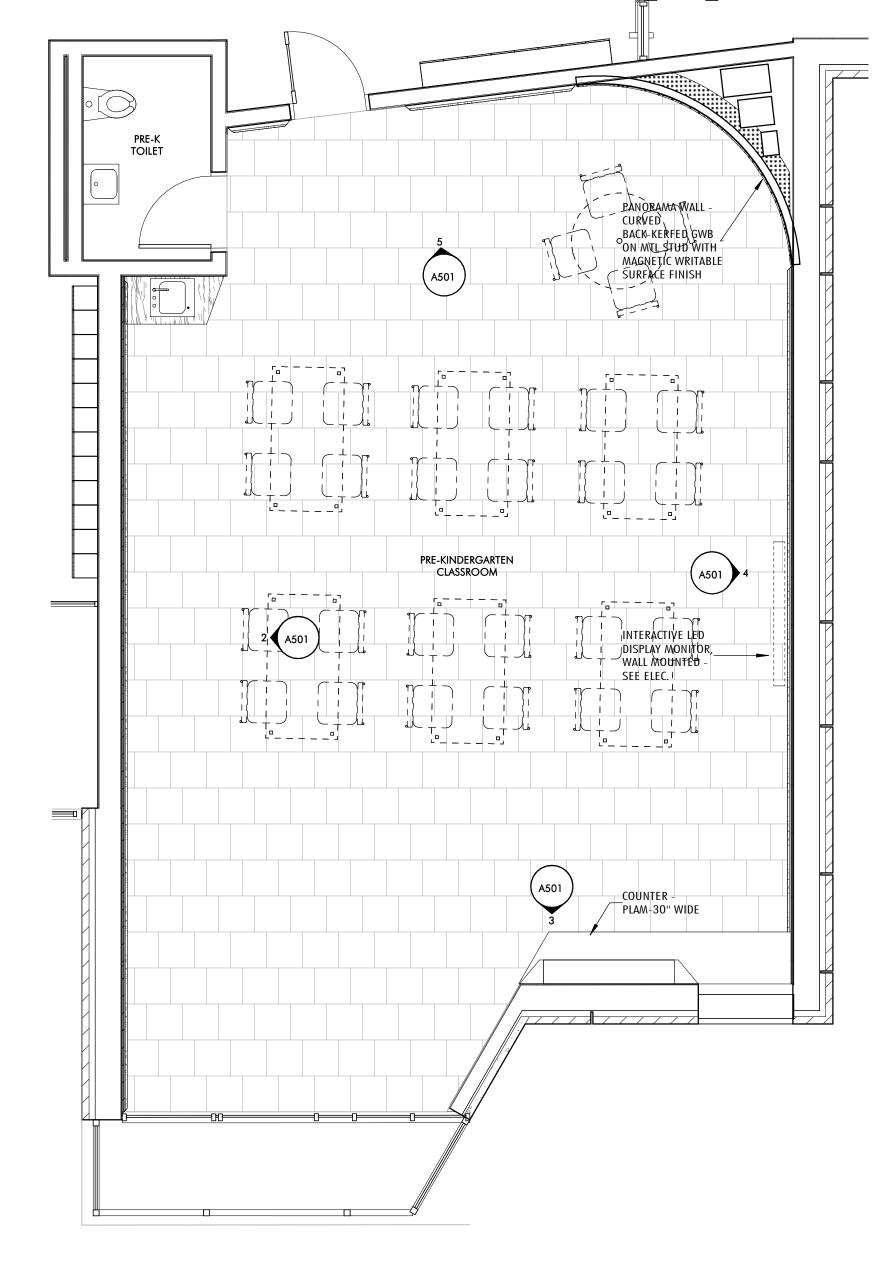











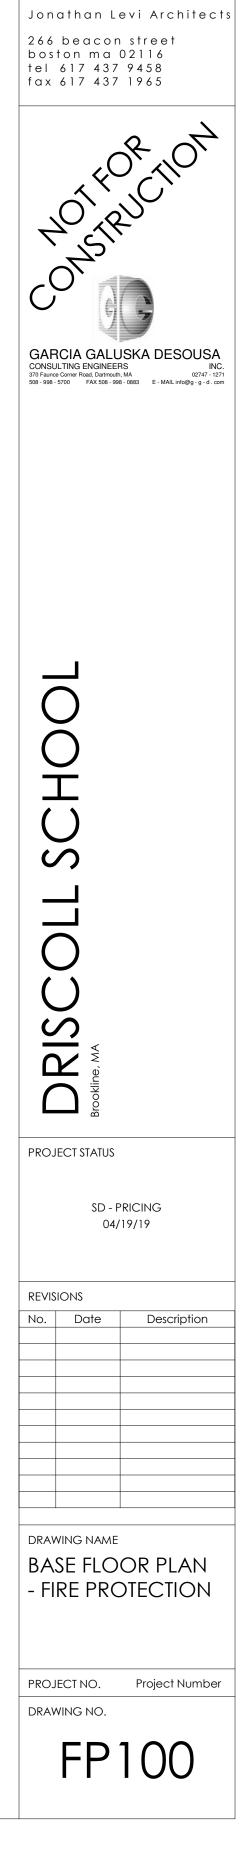









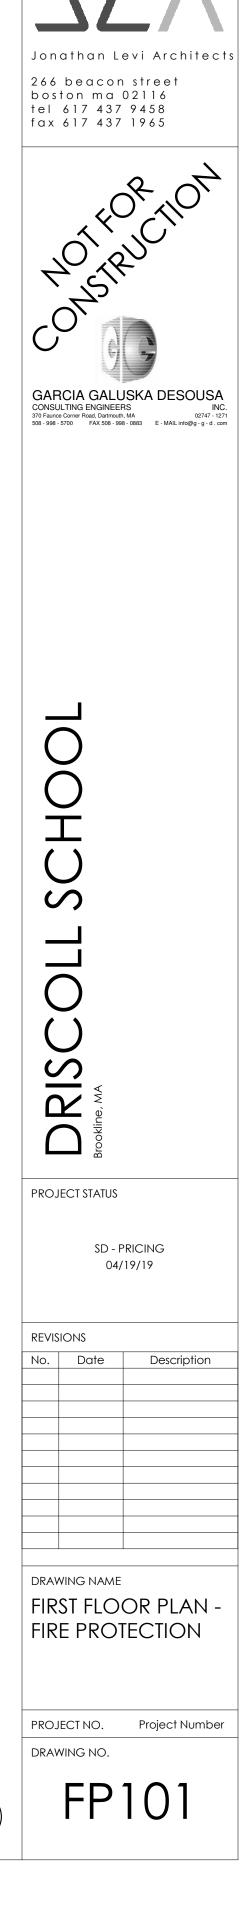




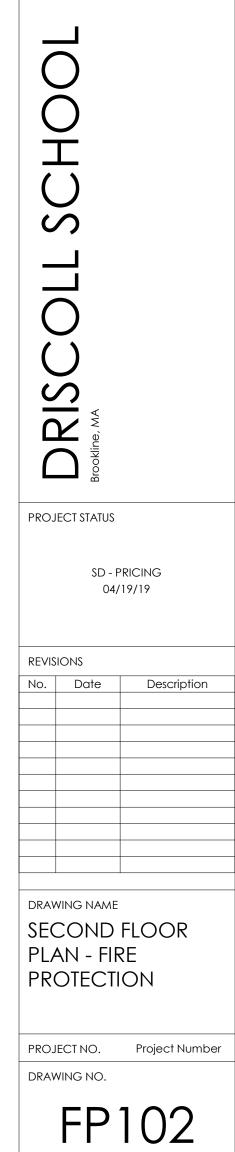


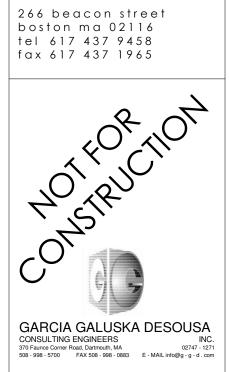




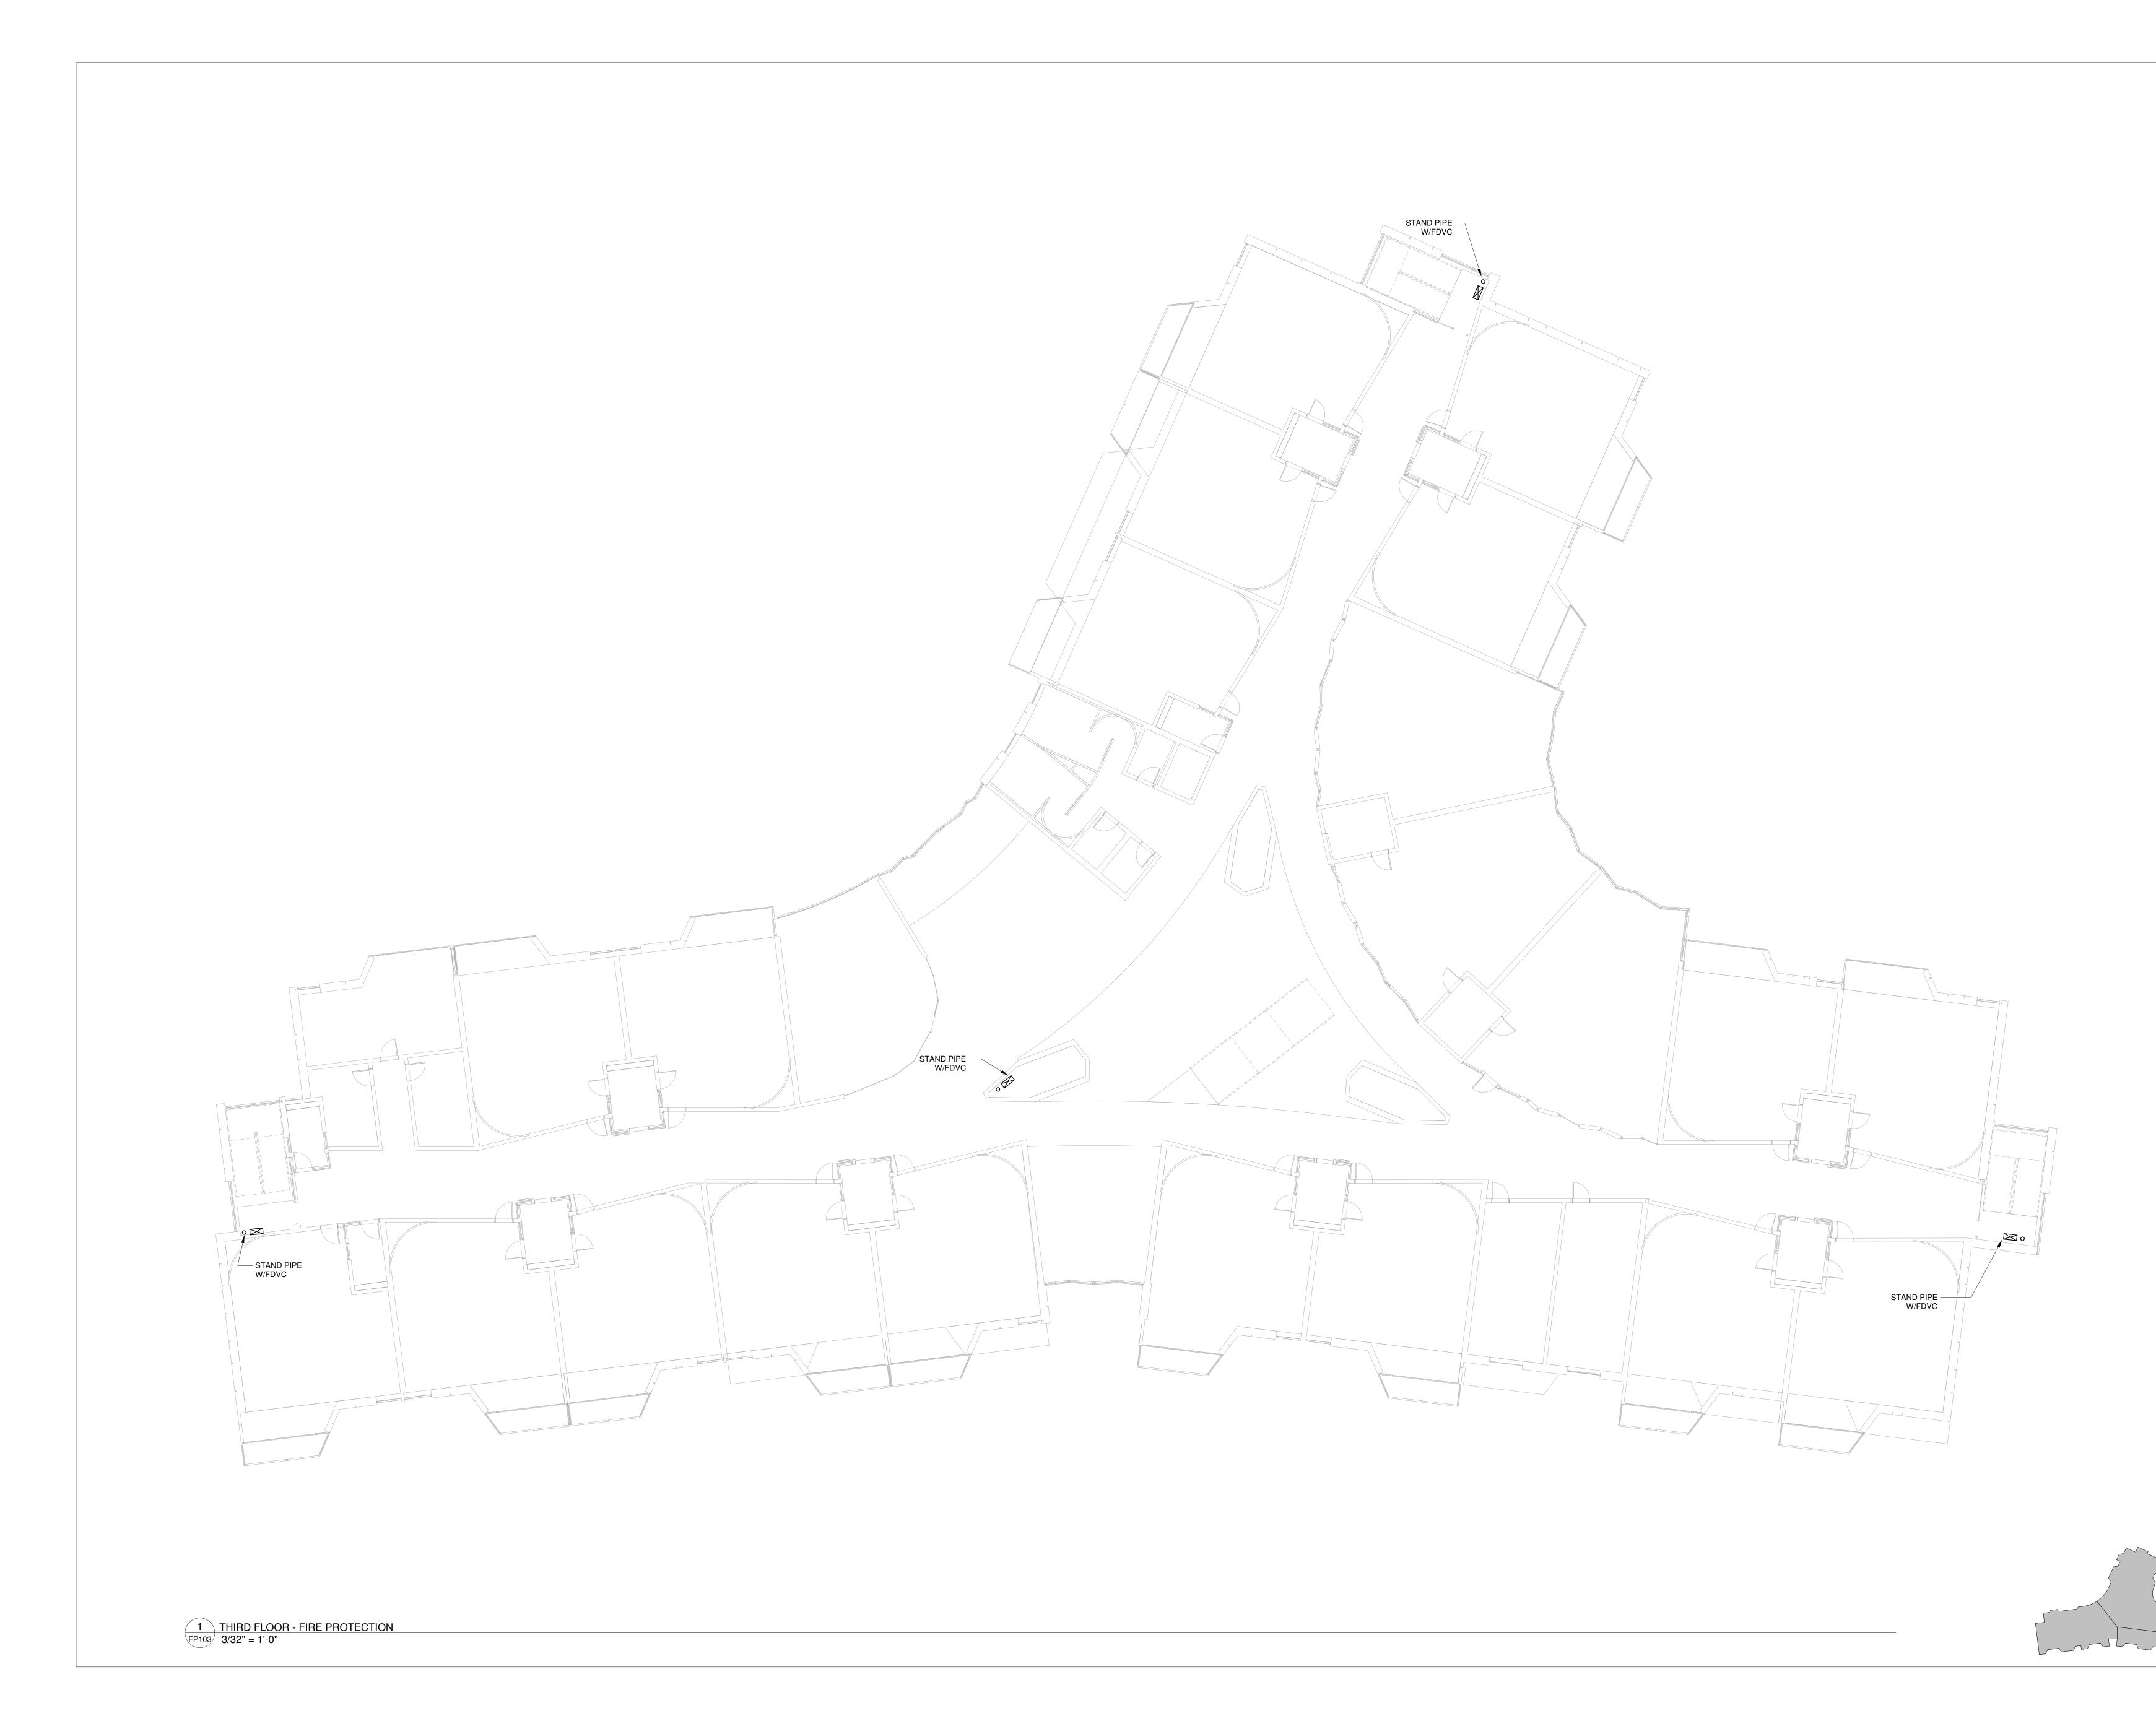





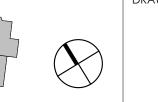


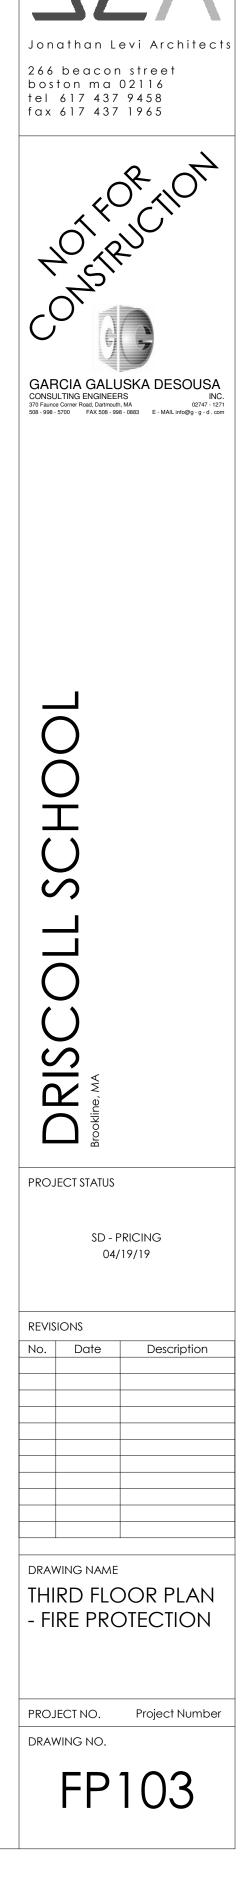





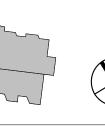

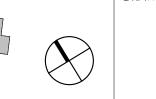


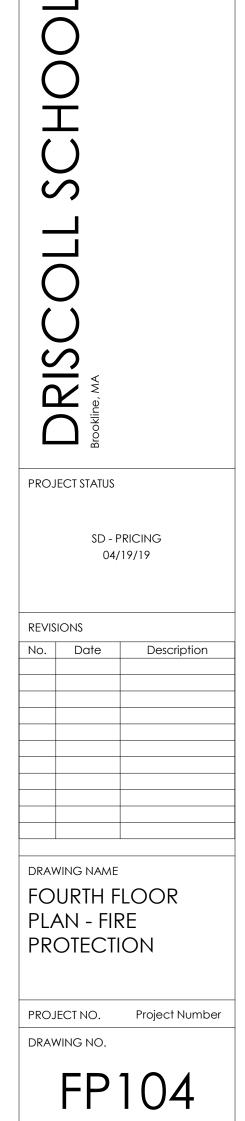

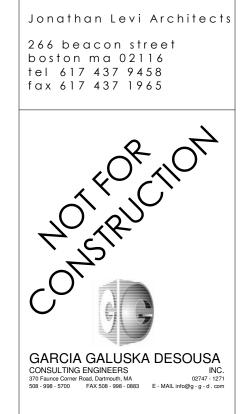

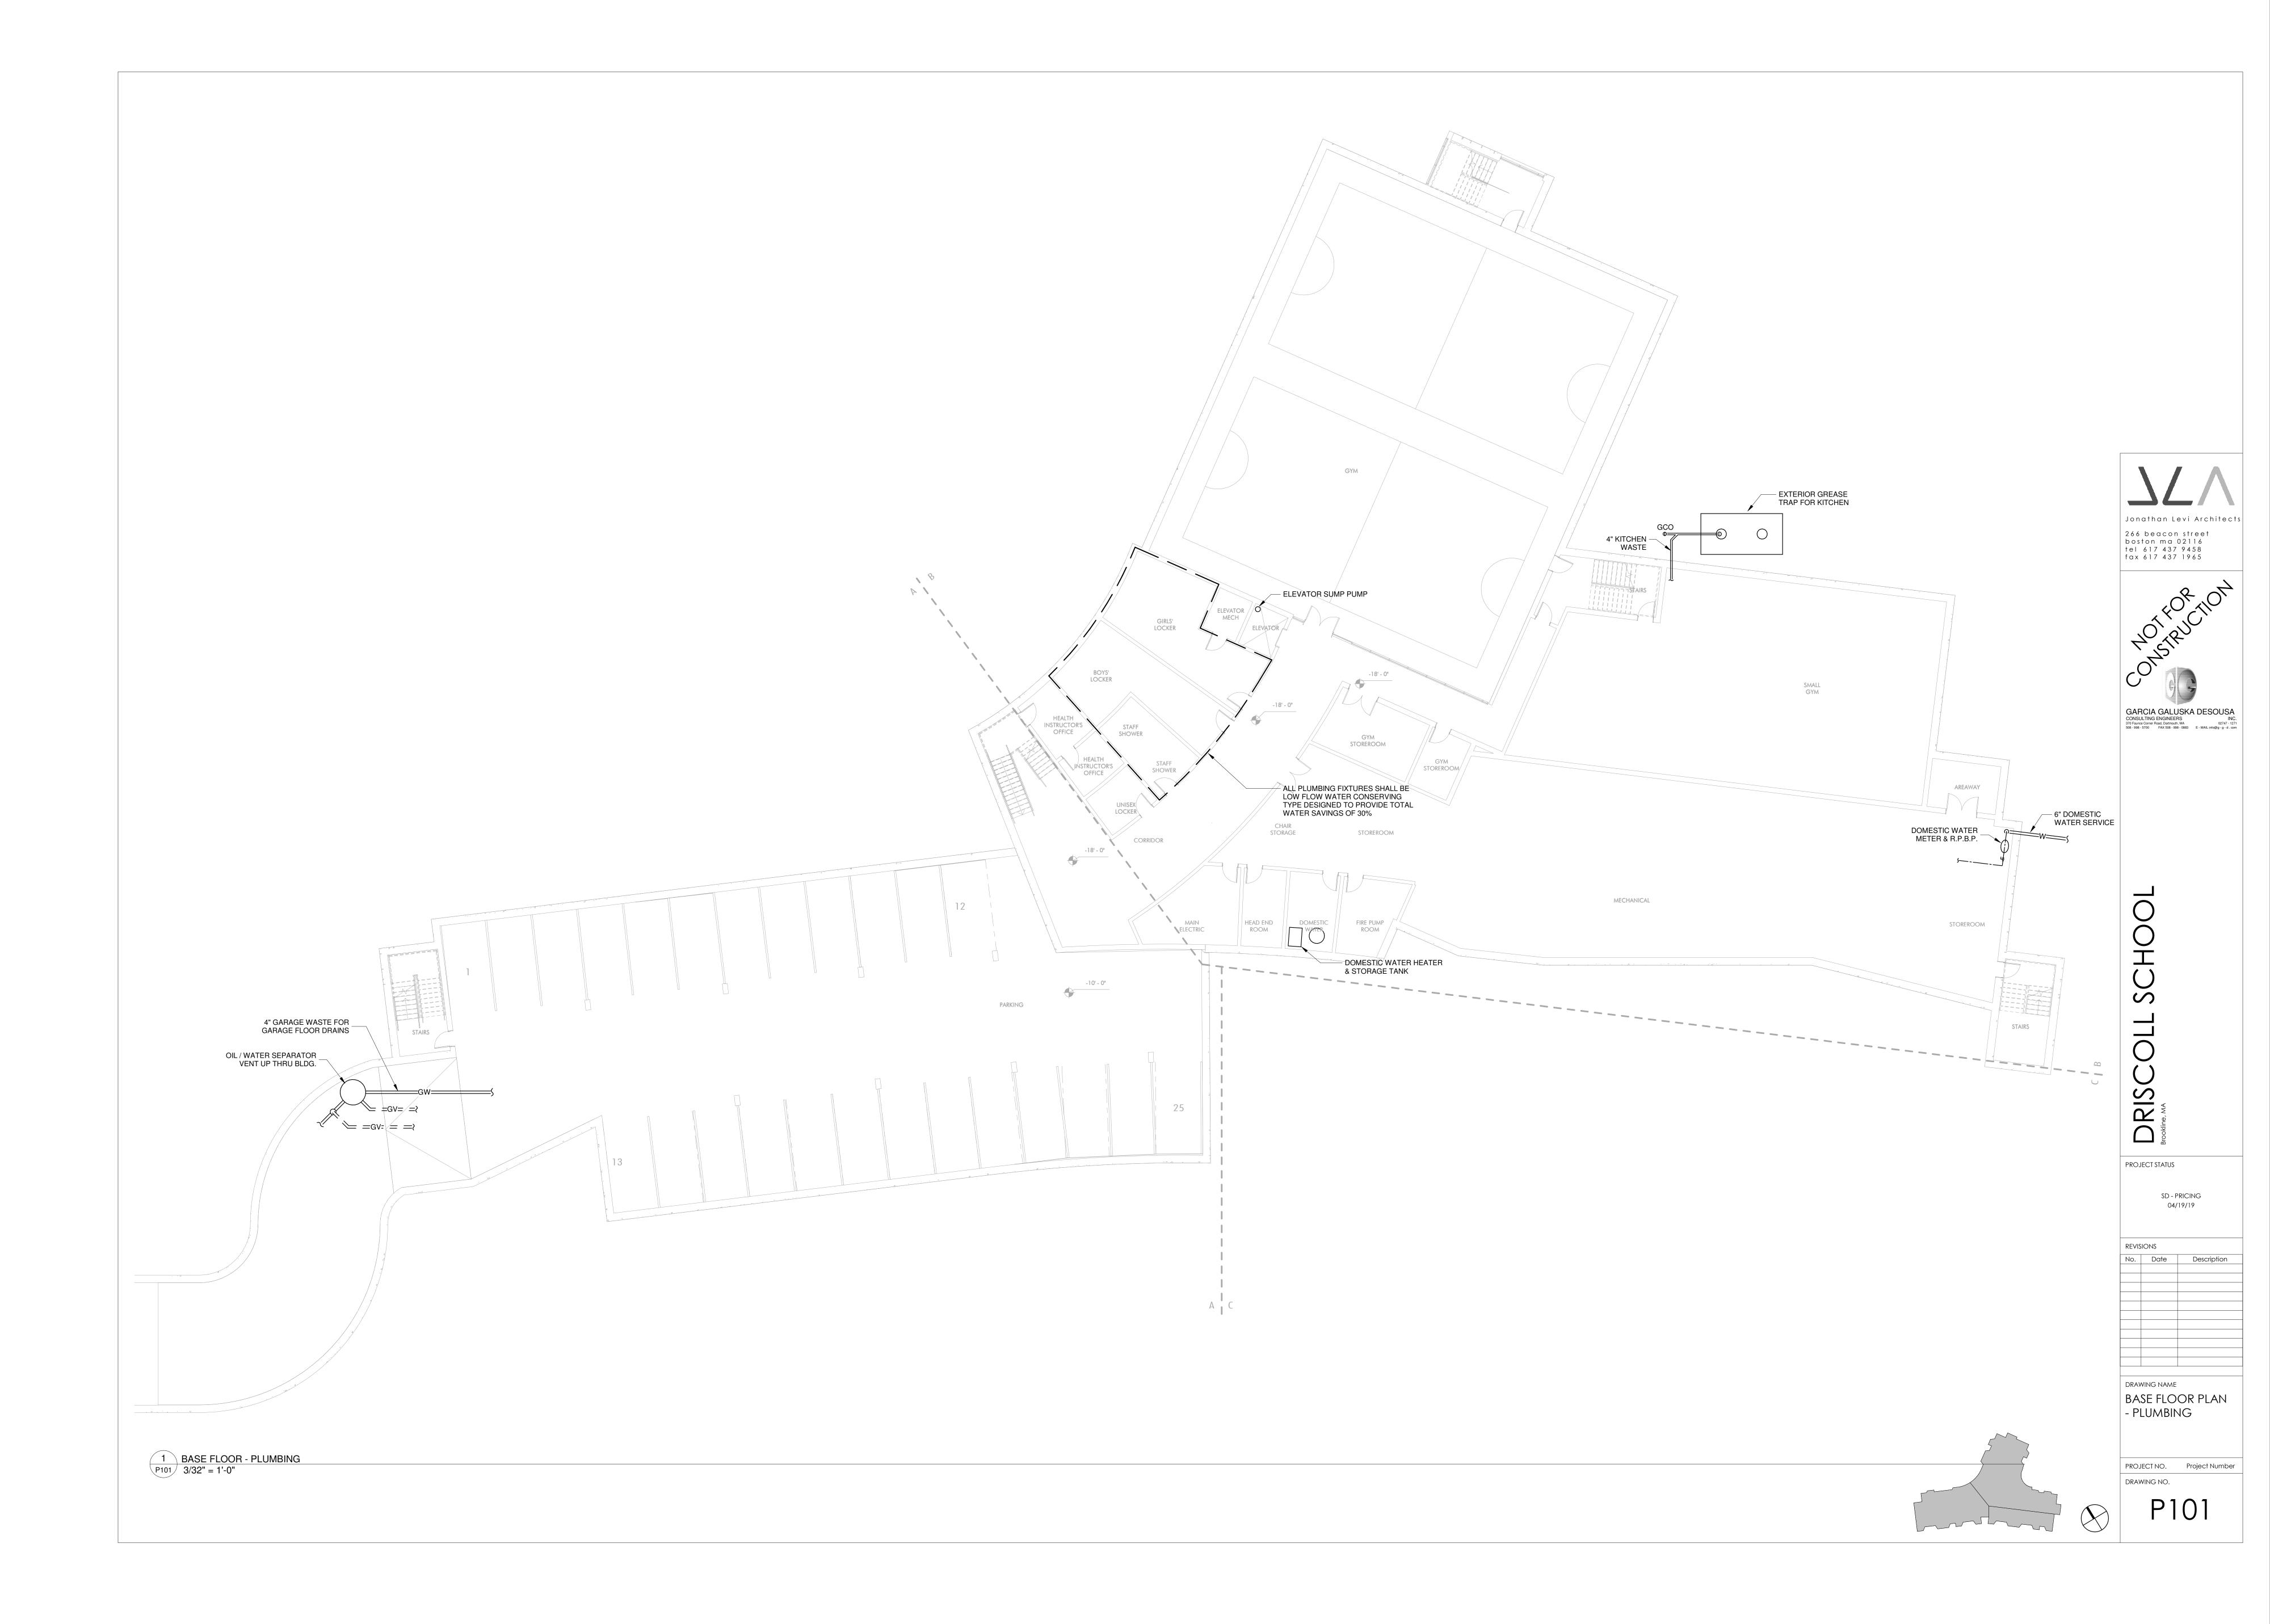




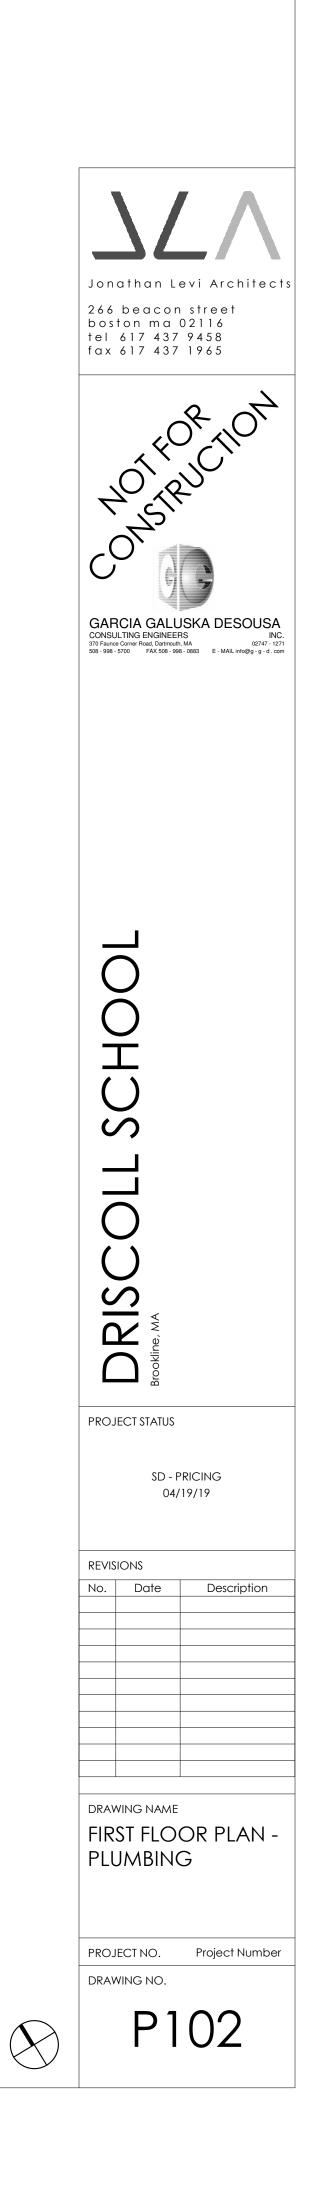







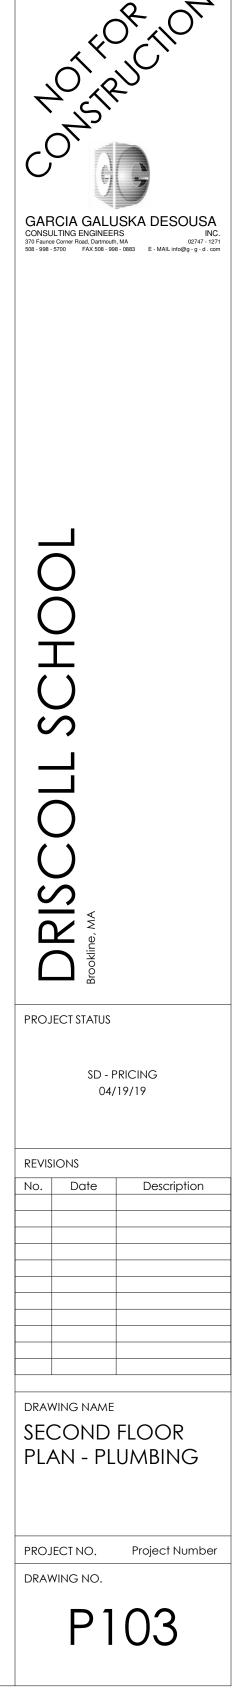



Jonathan Levi Architects

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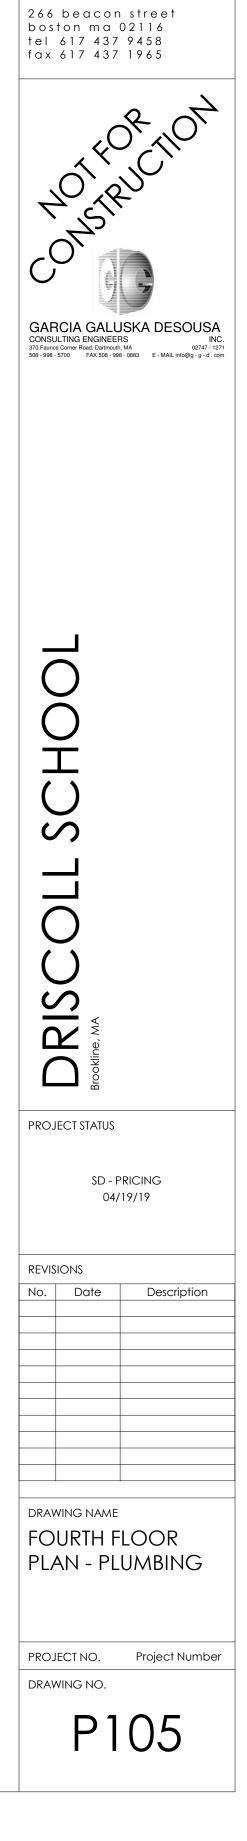






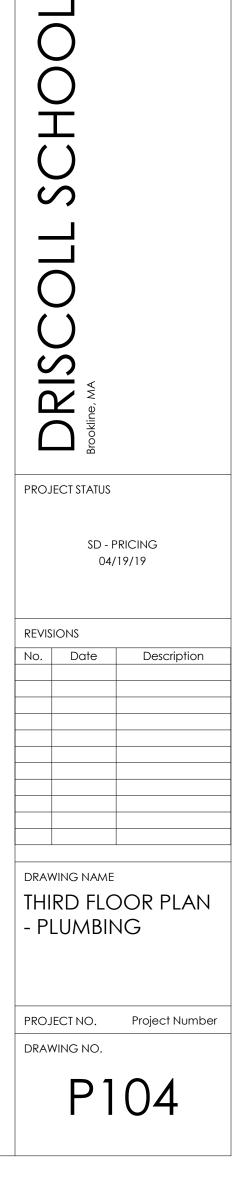

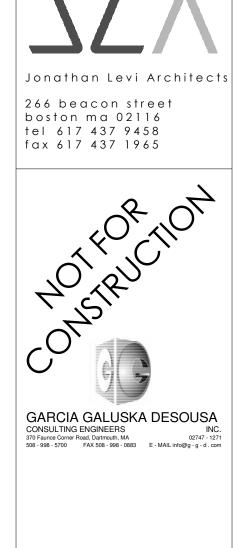



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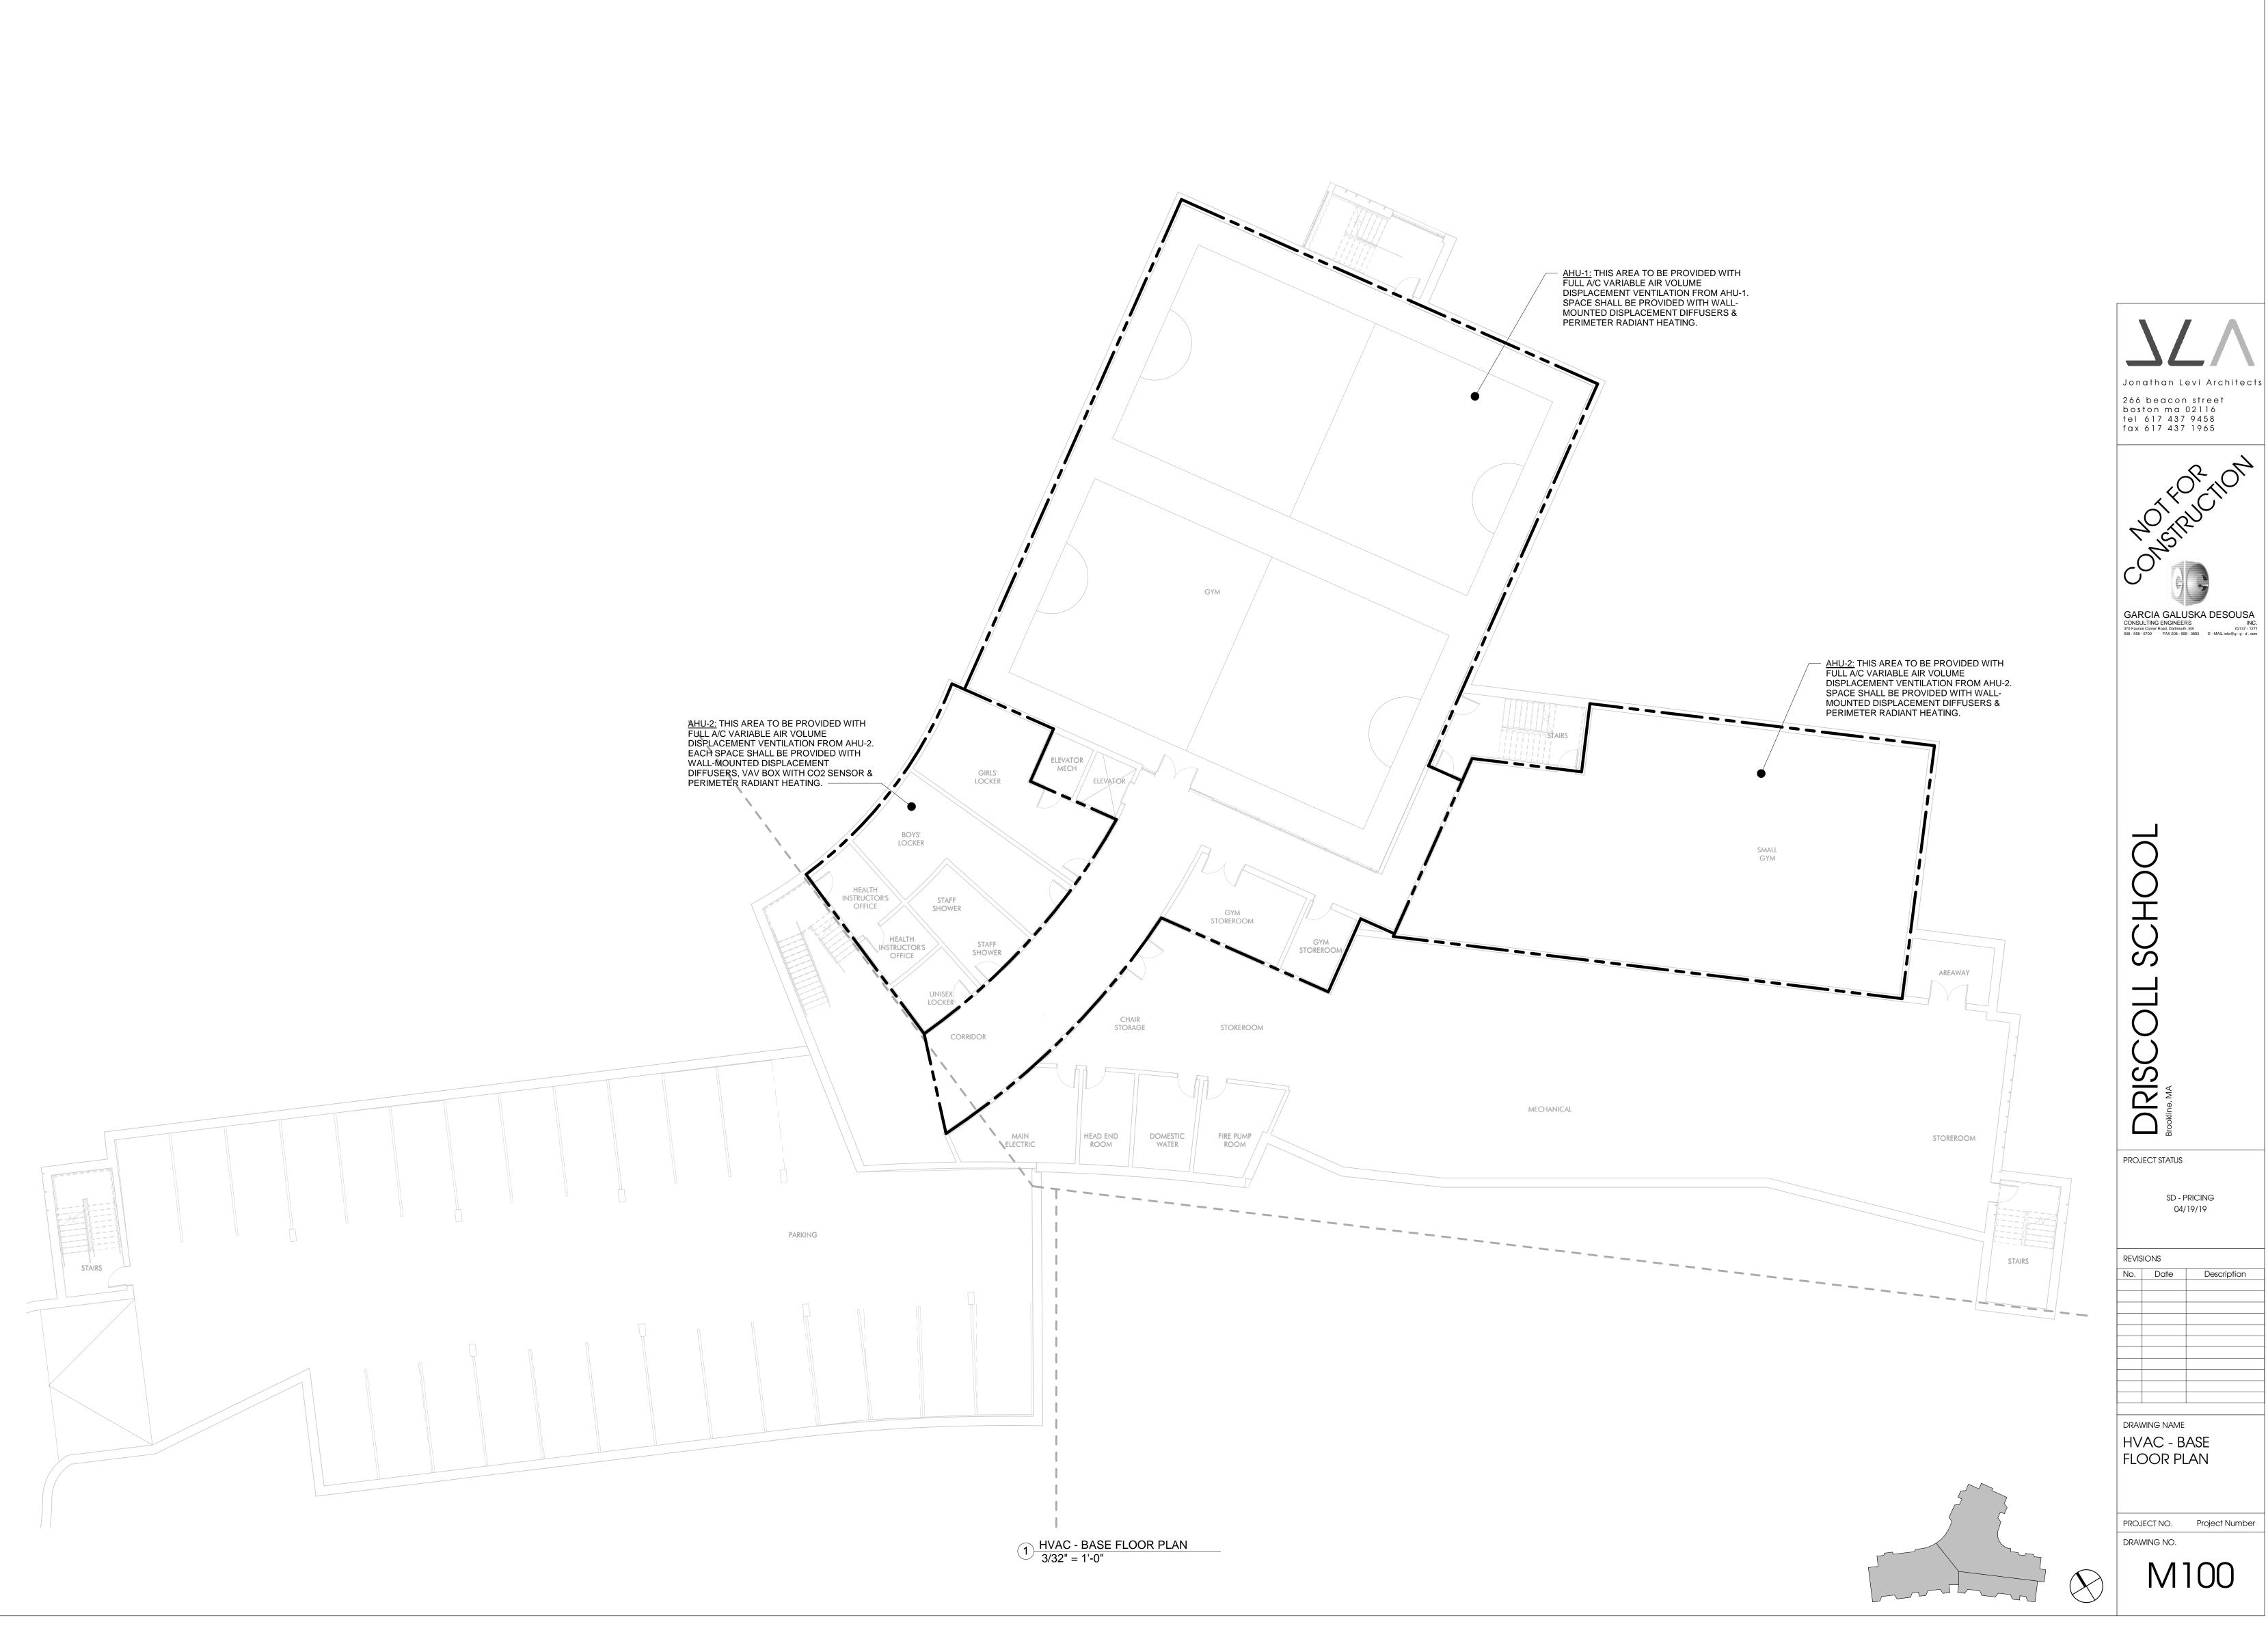


 
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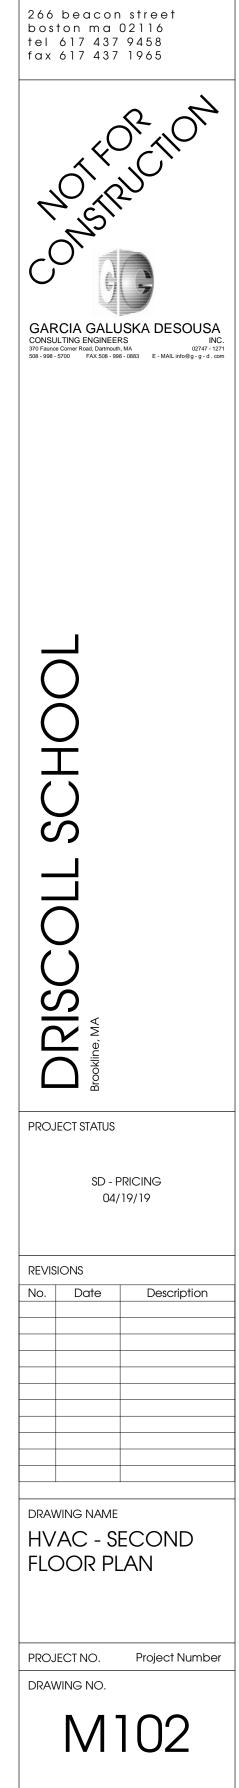
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 D SCHO \_\_\_\_ **D** DRISCO PROJECT STATUS SD - PRICING 04/19/19 REVISIONS No. Date Description DRAWING NAME ROOF PLAN -PLUMBING PROJECT NO. Project Number DRAWING NO. P106
















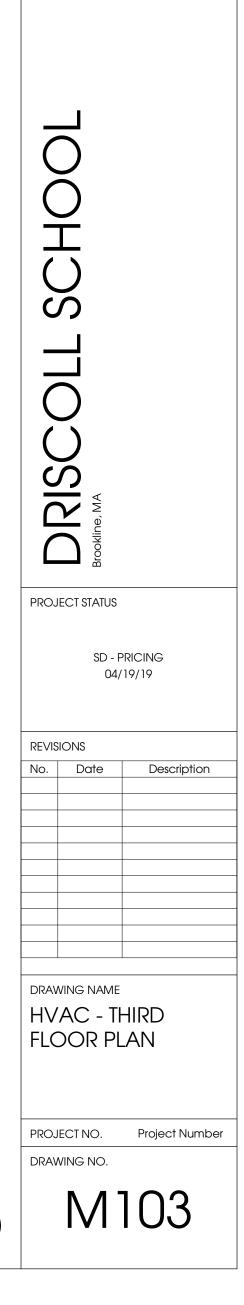


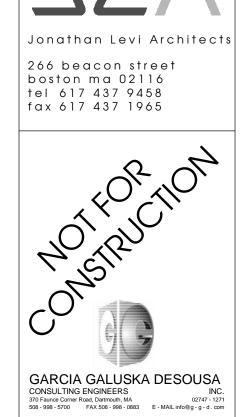

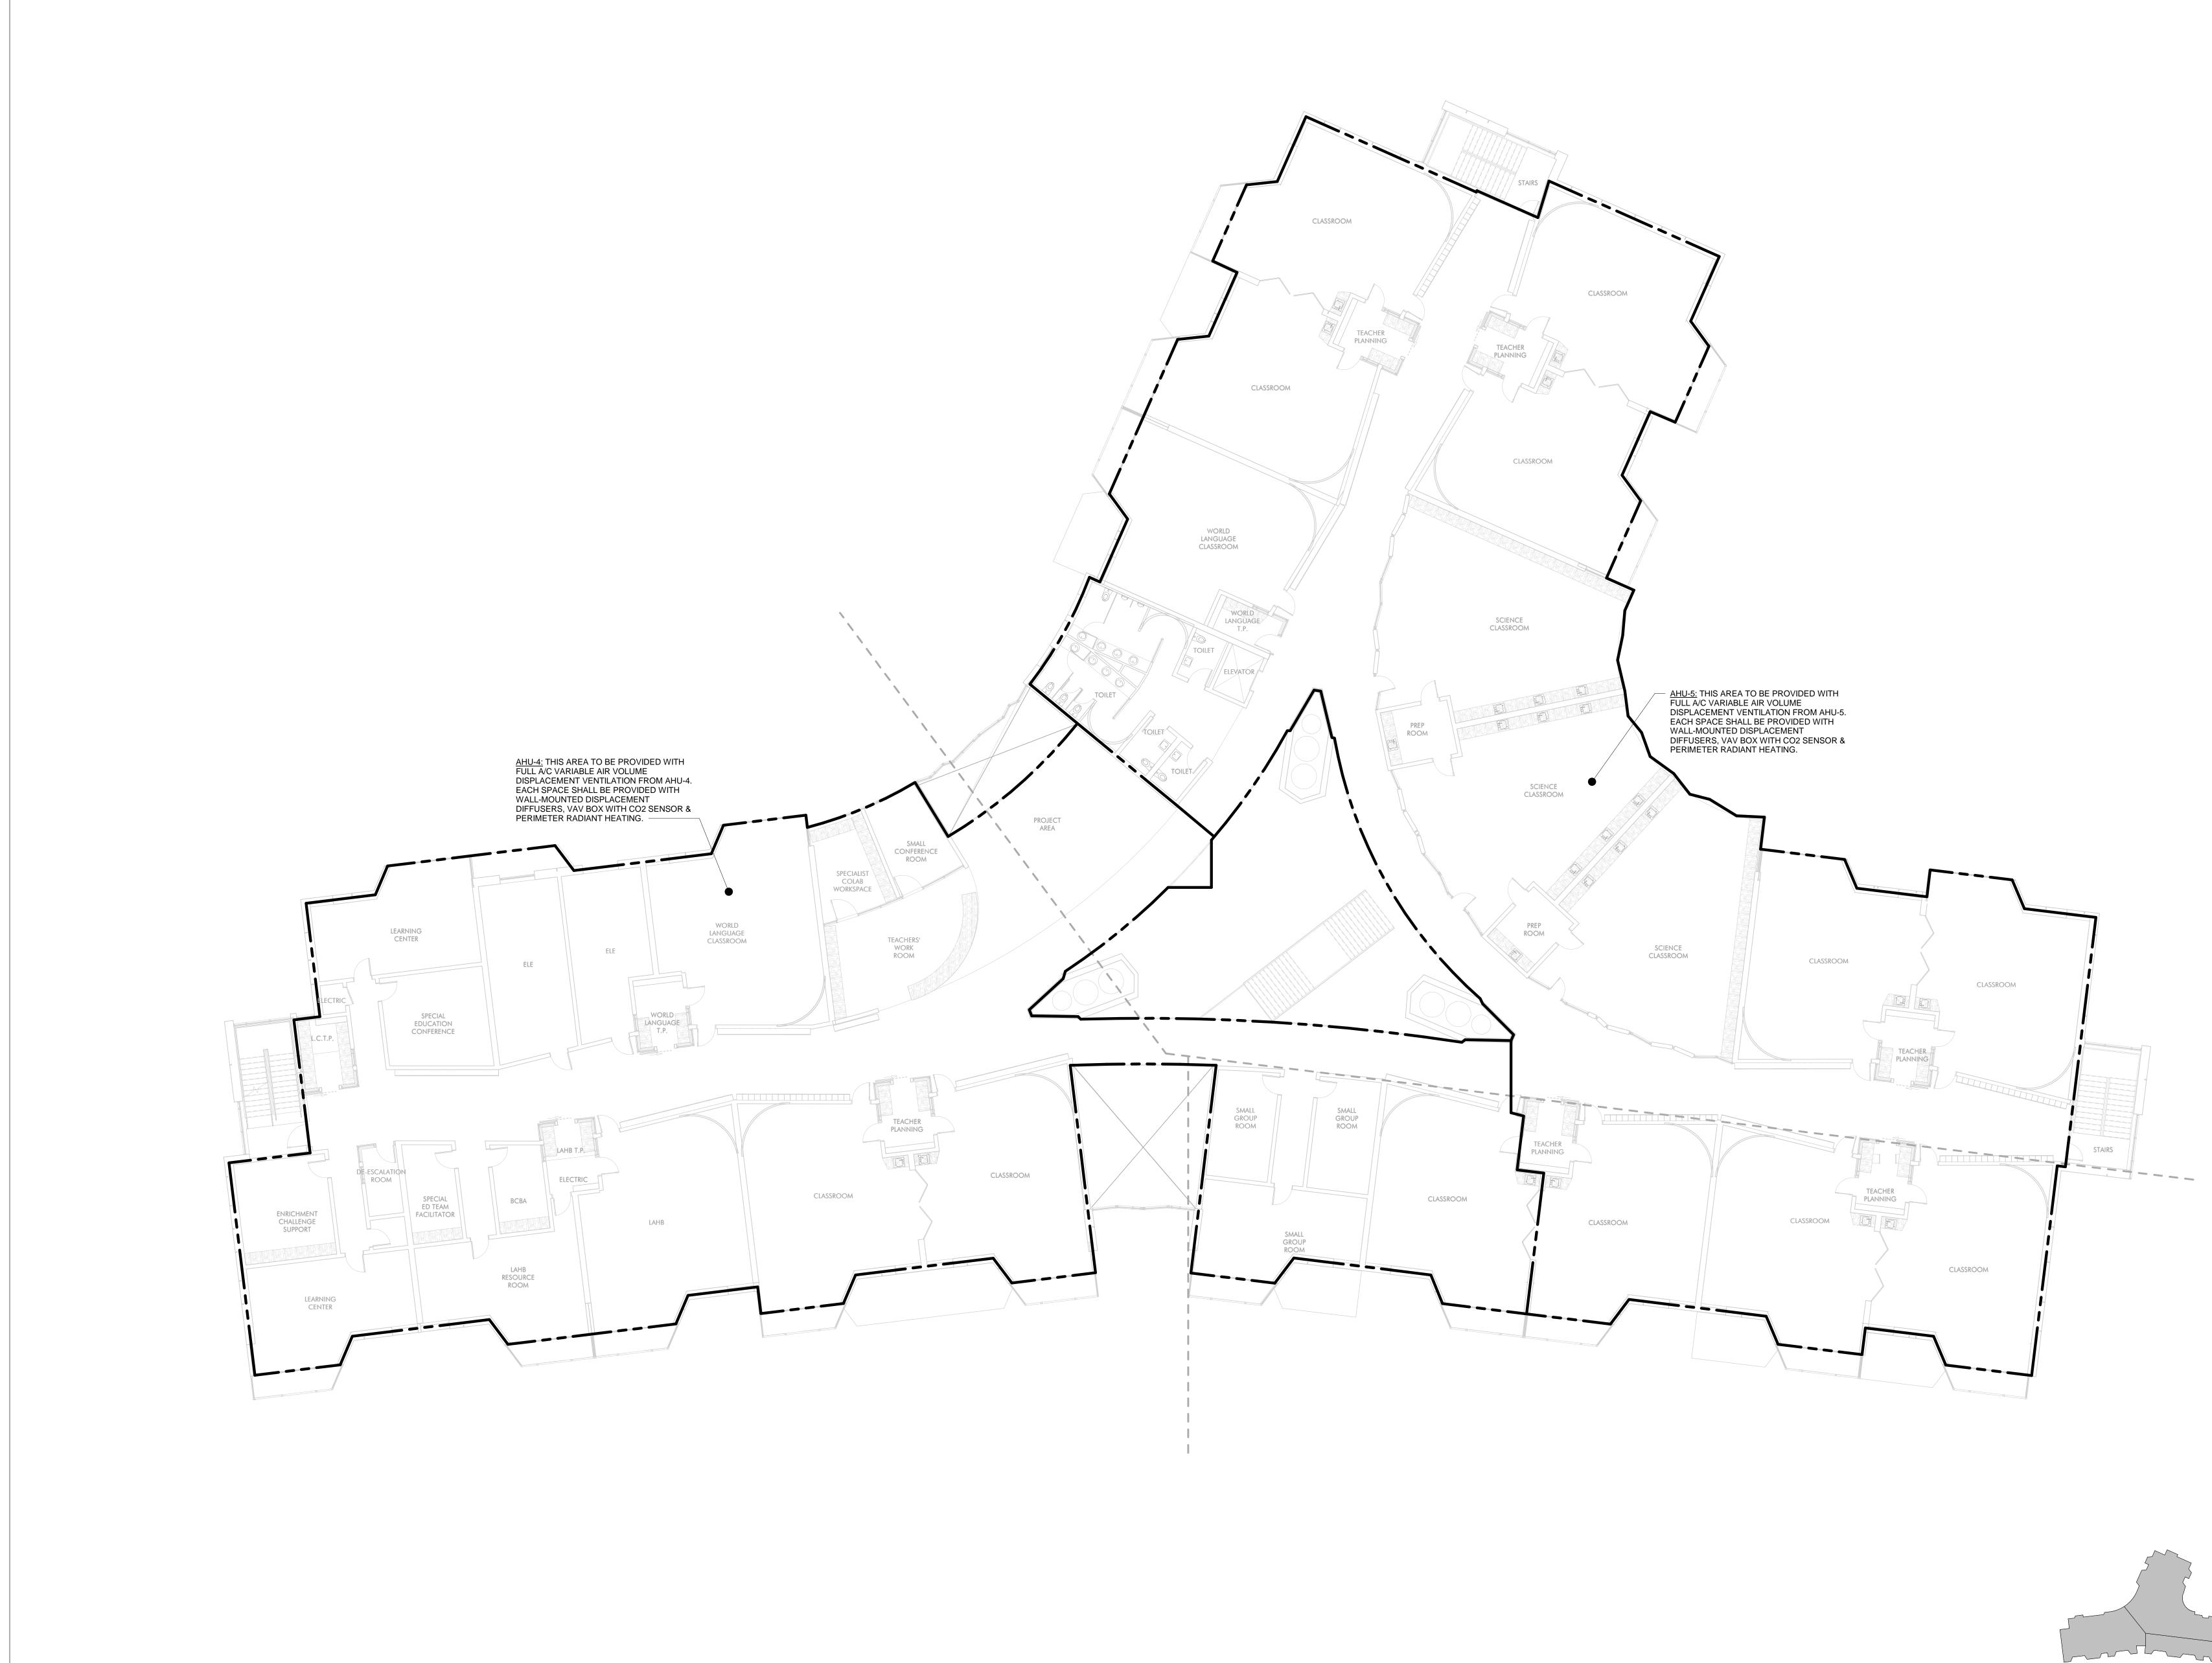






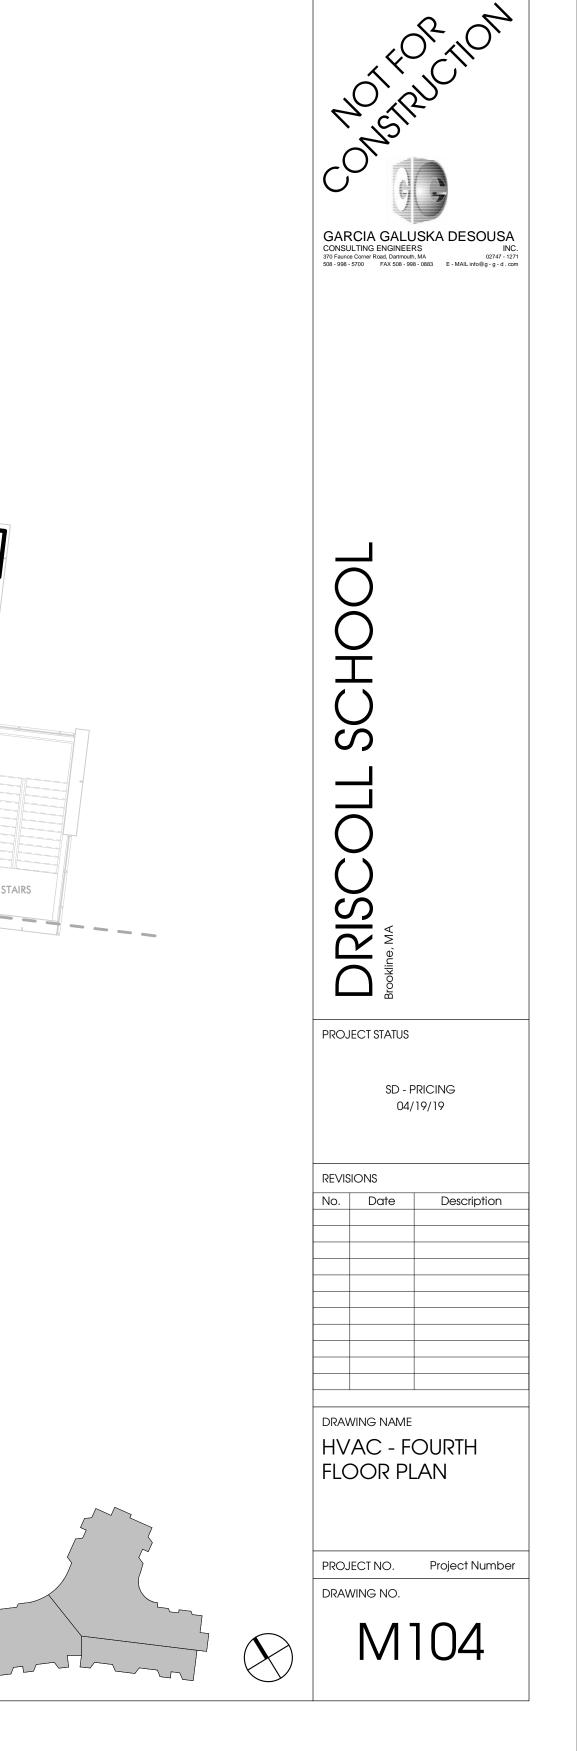

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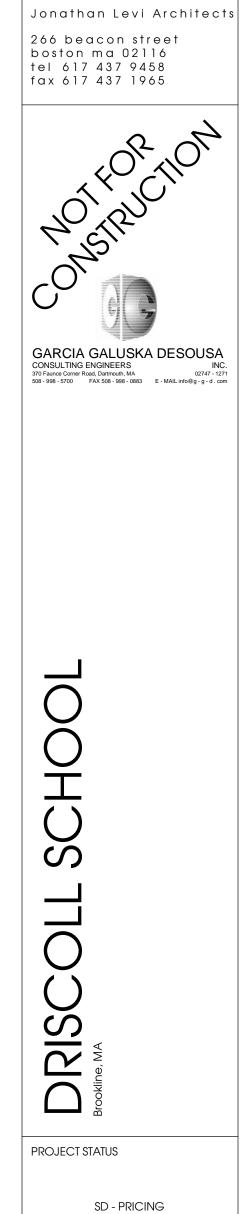
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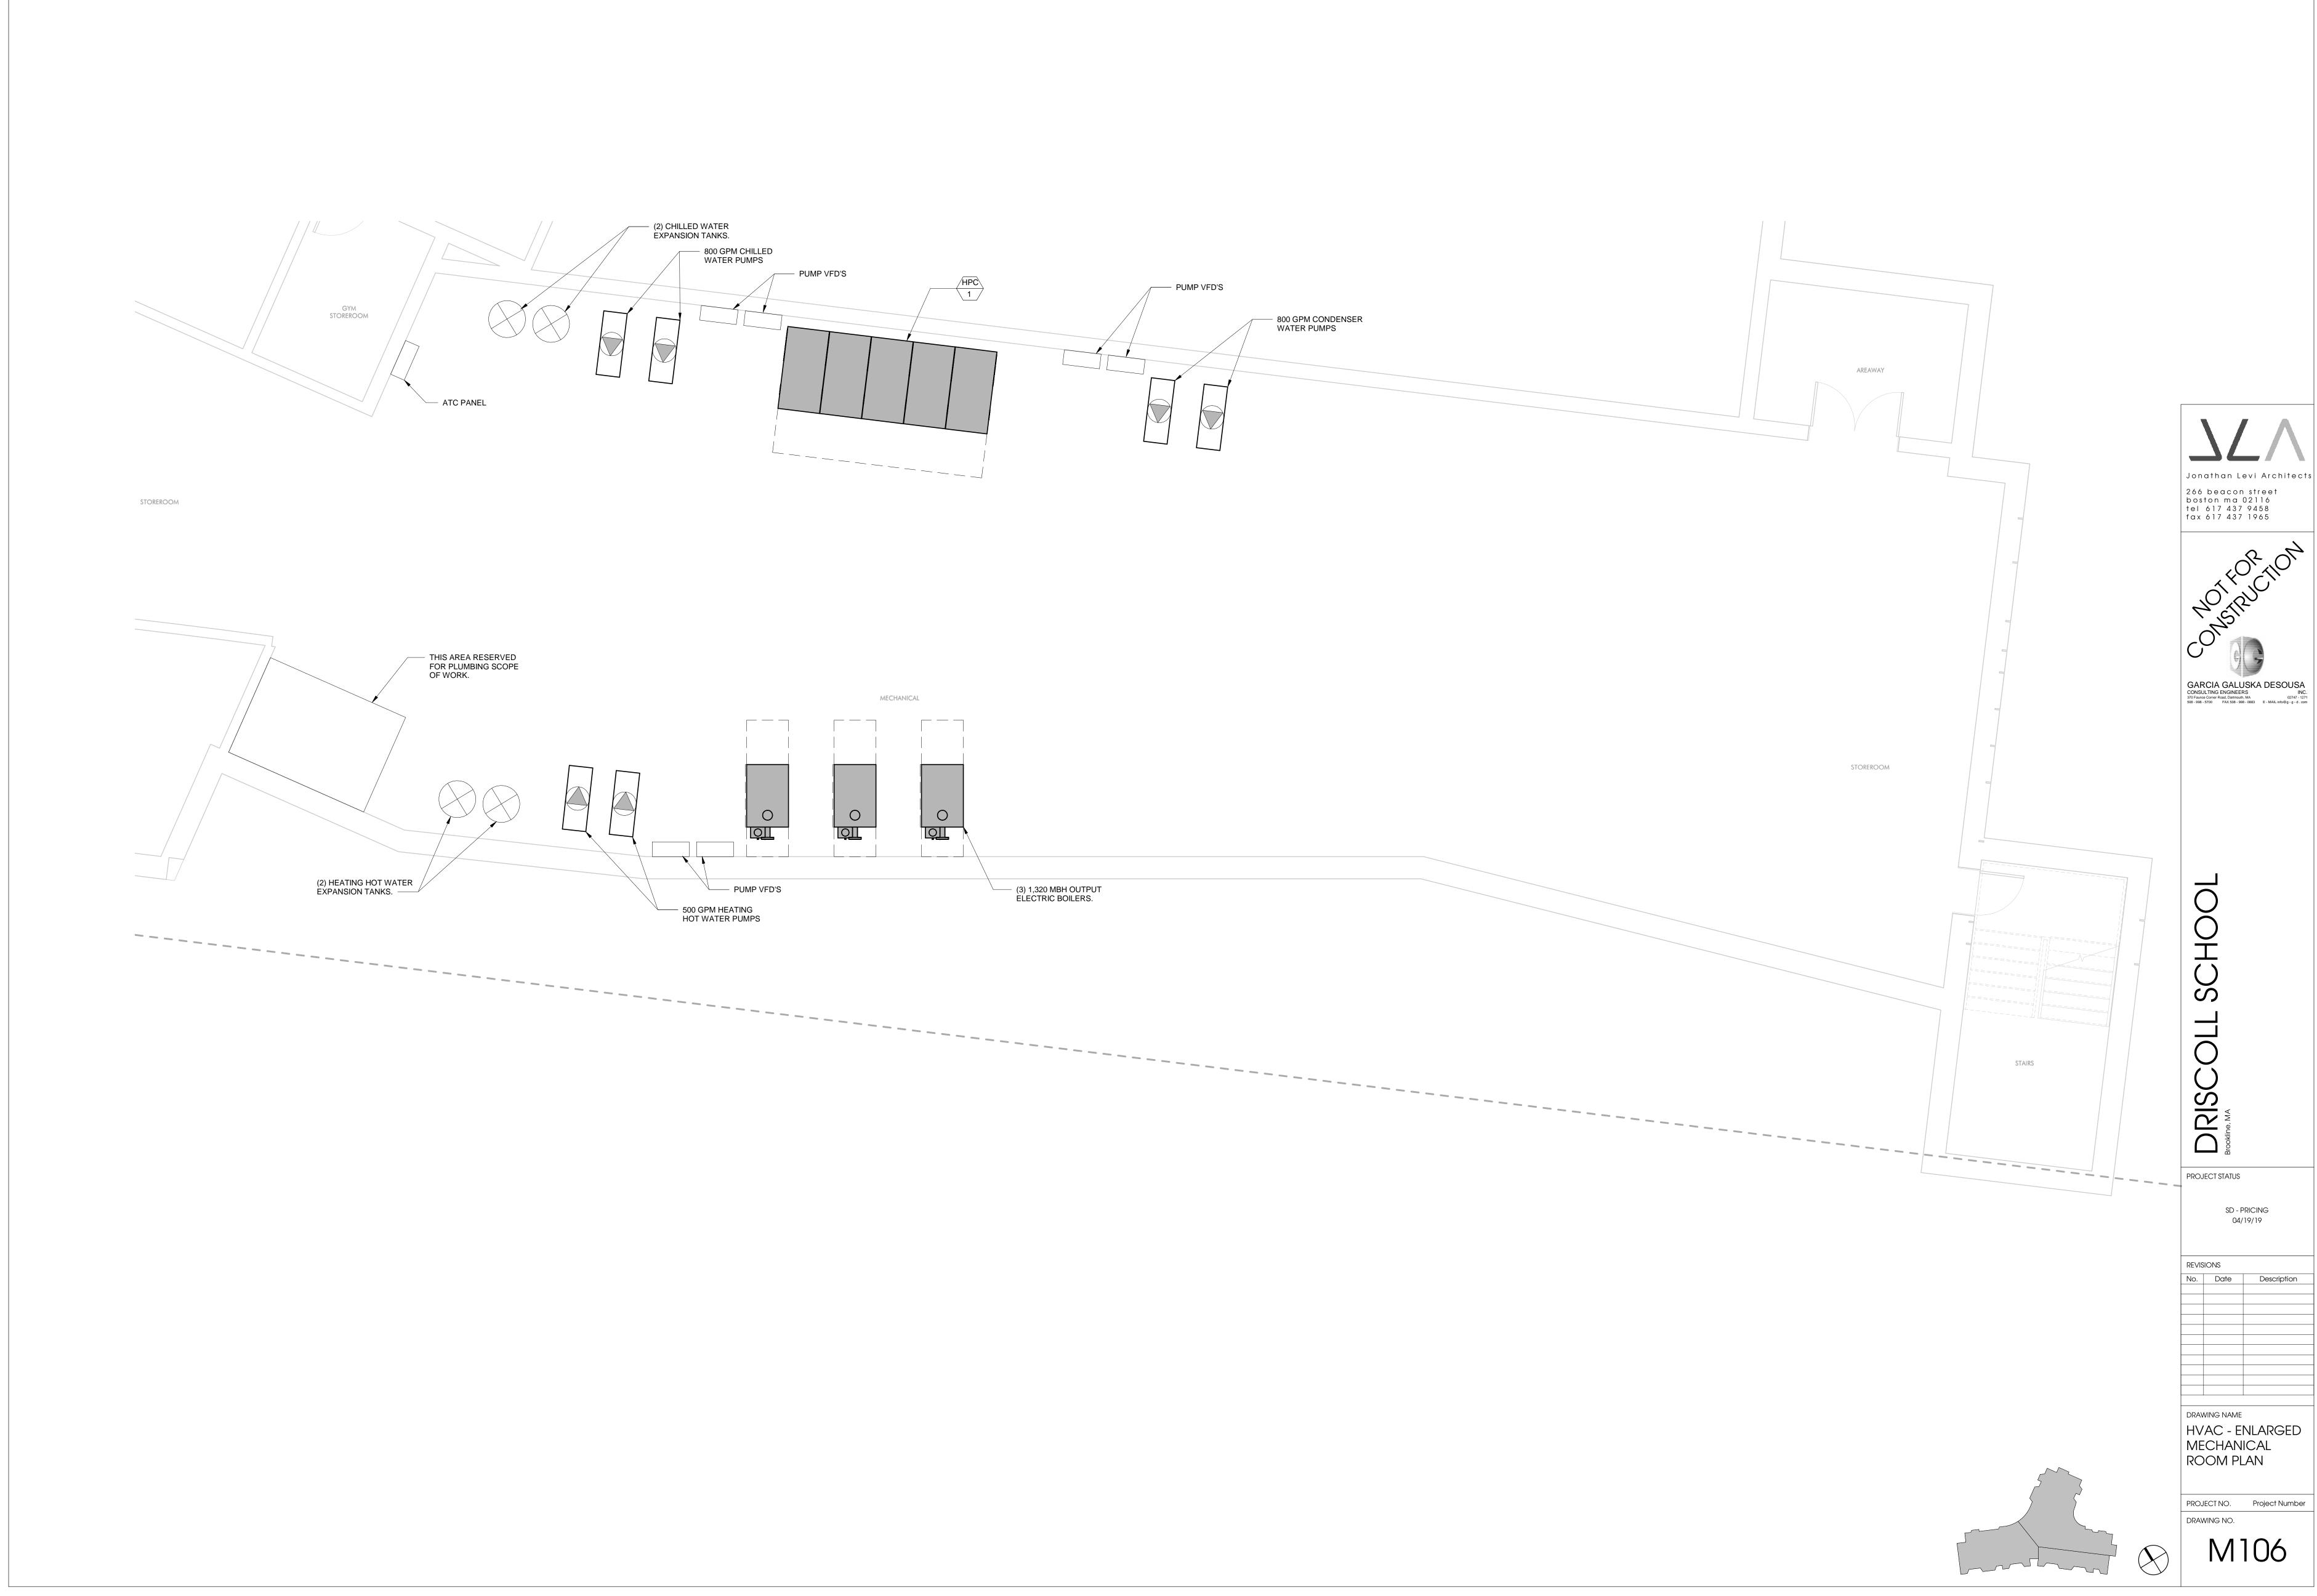




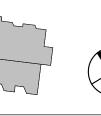



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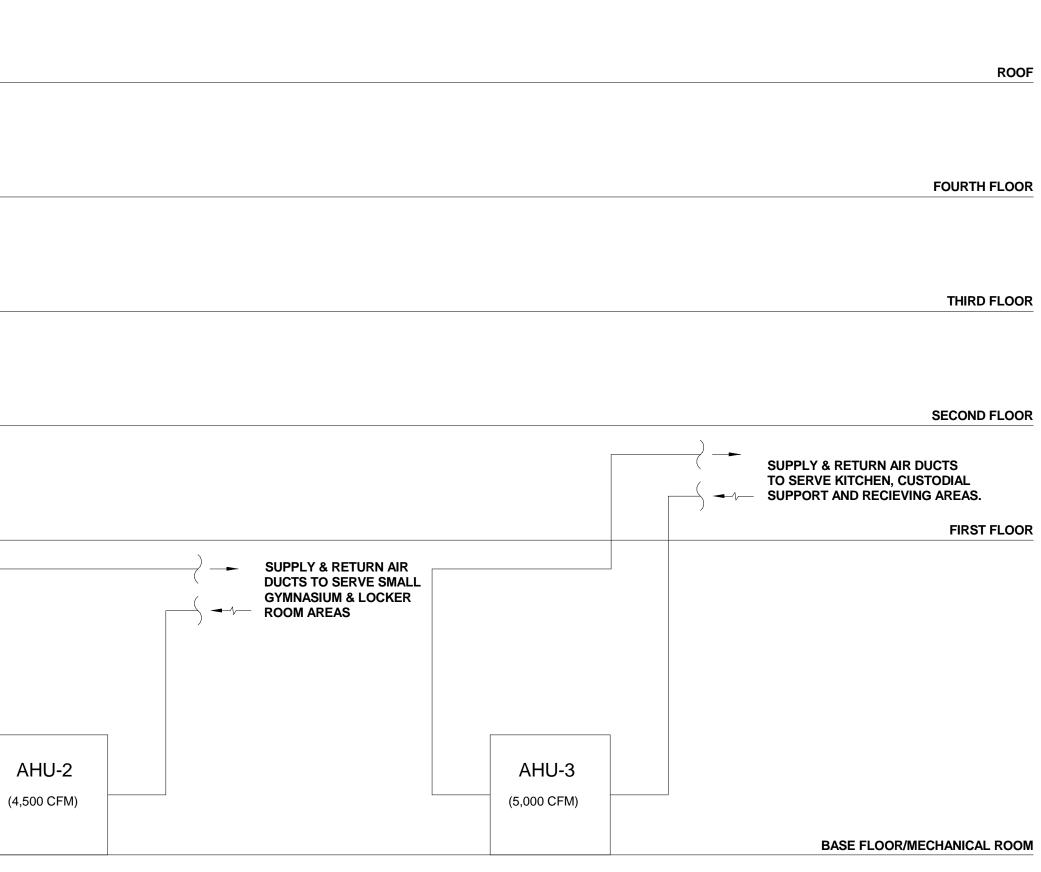








RETURN AIR DUCTS FOURTH FLOOR WEST OMS, ADMINISTRATION ORT AREAS			SUPPLY & RETURN AIR D TO SERVE FOURTH FLOC CLASSROOMS AND SUPF	DR EAST		
RETURN AIR DUCTS THIRD FLOOR WEST OMS AND SUPPORT AR	REAS		SUPPLY & RETURN AIR D TO SERVE THIRD FLOOR CLASSROOMS AND SUPF	EAST		
RETURN AIR DUCTS SECOND FLOOR WEST OMS AND SUPPORT AR			SUPPLY & RETURN AIR D TO SERVE SECOND FLOC CLASSROOMS AND SUPF	DR EAST		
RETURN AIR DUCTS FIRST FLOOR WEST OMS, ADMINISTRATION NTER AND SUPPORT A		 	SUPPLY & RETURN AIR D TO SERVE FIRST FLOOR CLASSROOMS, DINING C MULTI-PURPOSE AND SU	EAST OMMONS,	SUPPLY & RETURN TO SERVE GYMNAS	
	AHU-5 (55,000 CFM)			AHU-1 (6,000 CFM)		
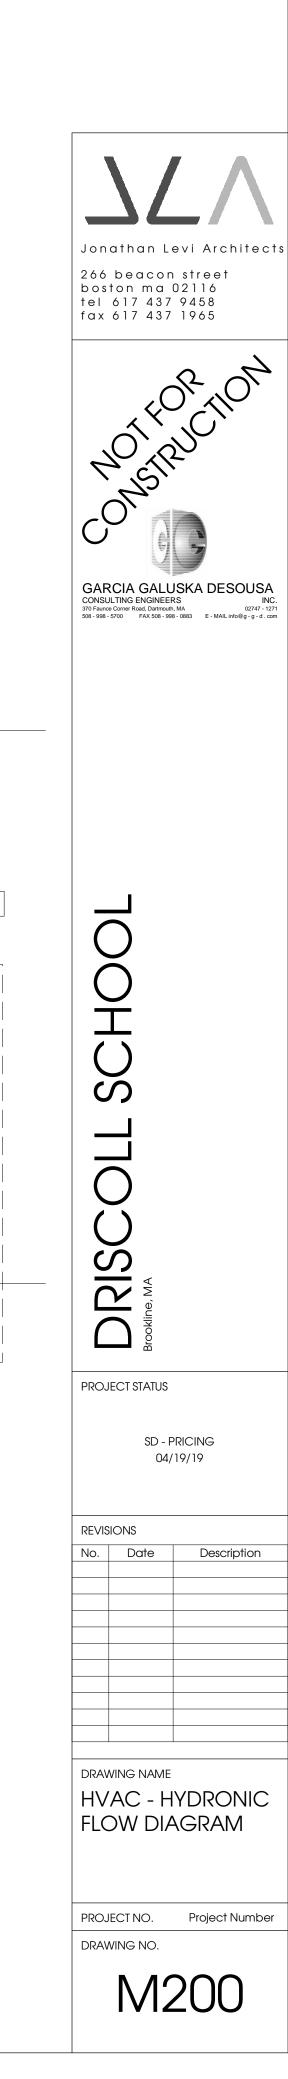
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			<u> </u>    [	
AHU-5		AHU-1		А
				~
(55,000 CFM)		(6,000 CFM)		(4,5

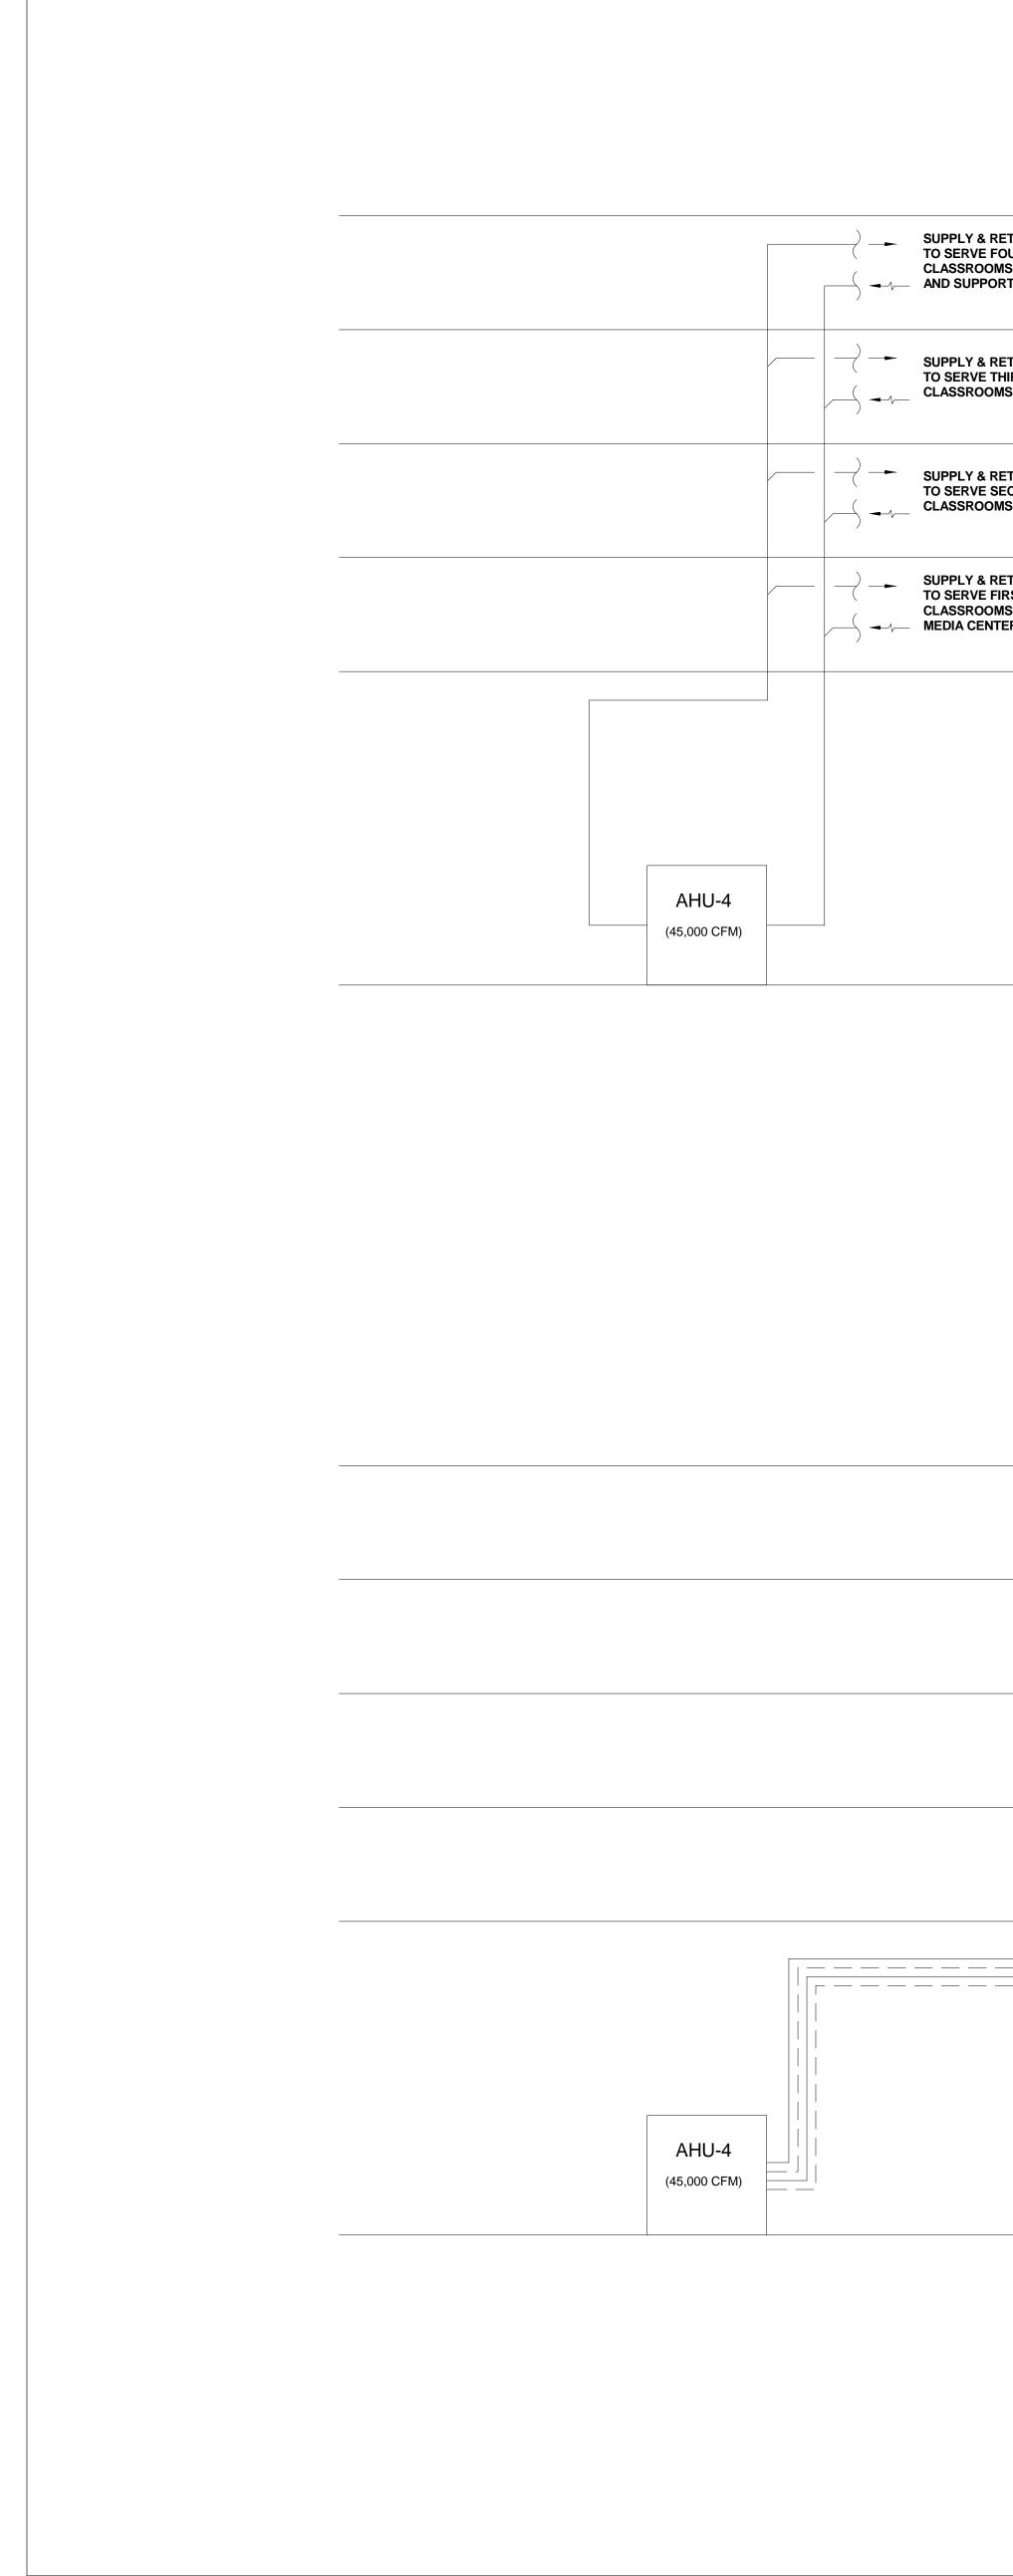

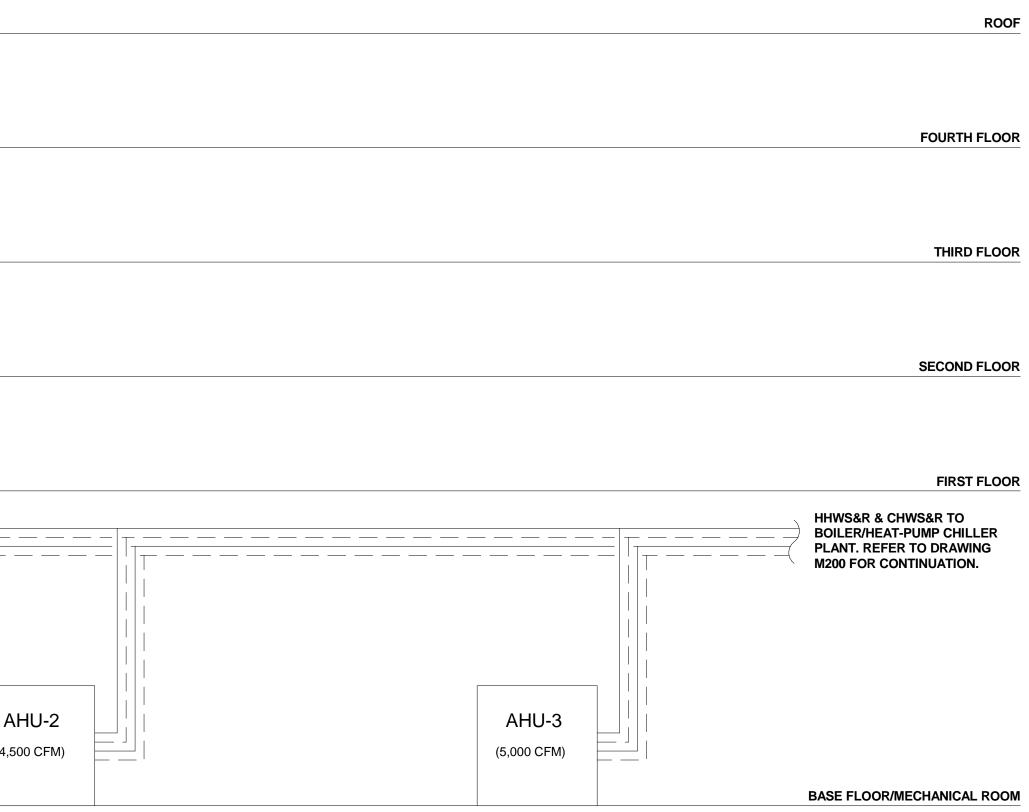

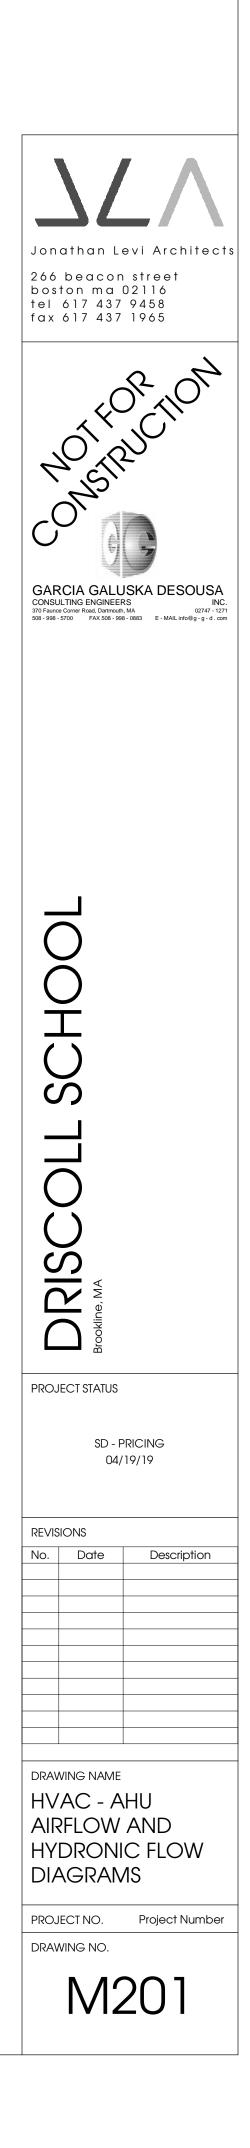

	LIGHTING FIXTURES (see lighting fixture schedule)
	FLUORESCENT LIGHT FIXTURE, CEILING MOUNTED SURFACE OR RECESSED.
	FIXTURE WIRED TO NORMAL/EMERGENCY CIRCUIT.
	FLUORESCENT BARE LAMP CHANNEL STRIP OR
$\overline{\mathbf{X}}$	INDUSTRIAL STRIP. SINGLE FACE INTERNALLY LIT EXIT SIGN, DIRECTIONAL INDICATORS
	OF THE 'CHEVRON' TYPE AS INDICATED ON DRAWINGS. DOUBLE FACE INTERNALLY LIT EXIT SIGN, DIRECTIONAL INDICATORS
	OF THE 'CHEVRON' TYPE AS INDICATED ON DRAWINGS.
	CEILING MOUNTED FIXTURE-RECESSED, SURFACE OR PENDANT.
$\Box$ $\Diamond$	
A1	FIXTURE KEYING SYSTEM A1 = FIXTURE TYPE 32= CIRCUIT #, b= SWITCH CONTROL
32b	
EB	EMERGENCY BATTERY UNIT WITH INTEGRAL HEADS.
	TRACK MOUNTED FIXTURES-LENGTH OF TRACK AS INDICATED ON DRAWINGS.
	POLE MOUNTED FIXTURE-DOUBLE OR SINGLE HEAD.
-	SWITCHES (typically mtd 48" AFF & u.n.o)
	SINGLE POLE SWITCH-"a" DESIGNATES SWITCH CONTROL
$S_2$	(LOWER CASE). TWO POLE SWITCH
	THREE-WAY SWITCH. SINGLE POLE SWITCH WITH PILOT LIGHT-GLOWS IN "OFF"
	POSITION WHEN IN VIEW OF LIGHTS. GLOWS IN "ON" POSITION WHEN REMOTE FROM LIGHTS.
4	FOUR-WAY SWITCH.
ດັ	DIMMER SWITCH; 0-10V TYPE. KEY OPERATED SWITCH.
S <sub>T</sub>	TIMER SWITCH-DIGITAL PROGRAMMABLE TYPE.
SWP	WEATHERPROOF SINGLE POLE SWITCH. EXPLOSION PROOF SINGLE POLE SWITCH.
S <sub>DT</sub>	SINGLE POLE/DOUBLE THROW SWITCH.
— F	FAN SPEED SWITCH. THREE POSITION MOMENTARY CONTACT SWITCH-UP/DOWN/CENTER OFF.
S <sub>MC</sub>	THREE FOSTION MOMENTARY CONTACT SWITCH-OF/DOWN/CENTER OFF.
L	IGHTING CONTROLS
SSU	ALCS SYSTEM SERVER UNIT - REFER TO ALCS ONE-LINE DIAGRAM.
ECU	ALCS ENERGY CONTROL UNIT - REFER TO ALCS ONE-LINE DIAGRAM.
	ALCS NETWORK ETHERNET SWITCH - REFER TO ALCS ONE-LINE DIAGRAM.
	ALCS LOCAL SWITCHING / DIMMING STATION - REFER TO ALCS RISER DIAGRAM
	ALCS KEYED LOCAL SWITCHING STATION - REFER TO ALCS RISER DIAGRAM
	ALCS VANDAL RESISTANT LOCAL SWITCHING STATION - REFER TO ALCS RISER DIAGRAM
Μ	ALCS MASTER SWITCHING / DIMMING STATION - REFER TO ALCS RISER DIAGRAM
	ALCS MASTER TOUCH SCREEN - REFER TO ALCS ONE-LINE DIAGRAM.
	ALCS LOCAL TOUCH SCREEN - REFER TO ALCS ONE-LINE DIAGRAM. ALCS DMX512 CONTROL INTERFACE - REFER TO ALCS ONE-LINE DIAGRAM.
	ALCS EXTERIOR PHOTOCELL - REFER TO ALCS ONE-LINE DIAGRAM.
(OS)	ALCS CEILING OCCUPANCY SENSOR - REFER TO ALCS ONE-LINE DIAGRAM.
PS	ALCS CEILING PHOTO SENSOR - REFER TO ALCS ONE-LINE DIAGRAM.
	ALCS WALL OCCUPANCY SENSOR - REFER TO ALCS ONE-LINE DIAGRAM.
	ALCS INPUT/OUTPUT MODULE - REFER TO ALCS ONE-LINE DIAGRAM. EMERGENCY BY-PASS RELAY - REFER TO EMERGENCY SUPERVISORY
	BY-PASS RELAY DETAIL PHASE CUT DIMMING MODULE - REFER TO ALCS ONE-LINE DIAGRAM
	PHASE COT DIMINING MODULE - REPER TO ALCS ONE-LINE DIAGRAM
	<u>SECURITY SYSTEM</u>
	REFER TO DWG. E500 FOR SECURITY SYMBOL LIST
	WIRE AND RACEWAYS
	WIRING AND RACEWAY - NO. OF DIAGONAL LINES INDICATES NO. #12 AWG CONDUCTORS. ABSENCE OF DIAGONAL LINES INDICATES 2
	#12 AWG+#12AWG GROUND UNLESS NOTED OTHERWISE. GROUND WIRE IS NOT SHOWN IN COUNT BUT SHALL BE PROVIDED.
	HOMERUN TO PANEL - NO. OF ARROWS INDICATES NO. OF 20 AMP/1 POLE CIRCUITS TO PANEL - UNLESS NOTED
	OTHERWISE.
NE	NORMAL/EMERGENCY WIRING - MIN. 2#10 AWG + #10 AWG GROUND. RUN IN SEPARATE RACEWAY.
———— 4F —	FIRE ALARM WIRING - "4F" INDICATES 4 #14 THHN SOLID IN
—— E —	3/4" MIN. SIZE CONDUIT. —— EMERGENCY ONLY WIRING-MINIMUM 2#10 AWG IN SEPARATE RACEWAY.
——— P ——	
SE	
CTV -	
—— F —	
E	4" CONDUIT SLEEVE THRU-WAY, ACROSS CORRIDOR OR BETWEEN         ROOMS FOR TEL/DATA - LOCATE ABOVE CEILING.
E	ROOMS FOR TEL/DATA - LOCATE ABOVE CEILING.
	CONDUIT SLEEVE EXTENDED TO NEAREST ACCESSIBLE CEILING- TERMINATE WITH INSULATED BUSHING.
$\sim$	FLEXIBLE CONNECTION TO EQUIPMENT
	CABLE TRAY-CONCEALED ABOVE CEILING IN FINISHED AREAS. PROVIDE LATERAL SUPPORT AS REQUIRED.
	MECHANICAL EQUIPMENT (REFER TO MECHANICAL EQUIPMENT SCHEDULE)
	BB
	AND WIRED BY EC. CABINET HEATER - F & I BY HVAC, WIRED BY E.C.
	UNIT HEATER - F & I BY HVAC, WIRED BY E.C.
(EF)	EXHAUST FAN - F & I BY HVAC, WIRED BY E.C.
	J CONNECTION TO CARBON MONOXIDE MONITOR
	MIN. 3#14 AWG. PER MONITOR.
	TERMINAL BOX-F&I BY HVAC WIRED BY E.C.
	FS D MOTORIZED FIRE/SMOKE DAMPER-F&I BY HVAC, WIRED BY E.C. TO POWER & FIRE ALARM SYSTEM.
	2 MOTOR - NUMERAL INDICATES HORSEPOWER
	Y

т	ECHNOLOGY	SYMBOL LIST	ONE LINE POWER	ABBREVIATIONS
₩ <b>▼</b>	VOICE OUTLET - AT 18" A.F.F., UNO - DOUBLE GANG BOX WITH	LEGEND NOTES:	LOAD-BREAK SWITCH.     CIRCUIT BREAKER.	A AMPERE AL ALUMINUM
•	SINGLE GANG PLASTER RING AND PULL LINE IN A 1" CONDUIT TO CABLE TRAY. MOUNTING DESIGNATIONS: "C"=ABOVE	A. THIS SHEET IS A GENERAL LIST OF SYMBOLS AND ABBREVIATIONS AND SHALL BE USED AS A DICTIONARY TO DEFINE ITEMS INDICATED ON DRAWINGS. NOT ALL SYMBOLS OR ABBREVIATIONS ARE NECESSARILY USED		AF AMP, FRAME AFF ABOVE FINISHED FLOOR
	COUNTER, "W" WALL PHONE AT 48" A.F.F. WIRING AND JACKS BY I.T. SUBCONTRACTOR	ON THIS PROJECT. ALL EQUIPMENT IS TO BE PROVIDED UNDER THIS SECTION UNLESS SPECIFICALLY INDICATED OTHERWISE.	$\rightarrow$ $\leftarrow$ POTENTIAL TRANSFORMER. $\rightarrow$ $\rightarrow$ $\rightarrow$ $\rightarrow$ $\downarrow$ LIGHTNING ARRESTER AND GROUNDING TO PROTECT ALL PHASES.	AFG ABOVE FINISHED GRADE AIC INTERRUPTING CAPACITY
$\mathbf{V}$	VOICE/DATA OUTLET - AT 18" A.F.F., UNO - DOUBLE GANG BOX WITH	RECEPTACLES (typically mtd. at 18" a.f.f., uno)	$\begin{array}{c}$	ALCS AUTOMATED LIGHTING CONTROL SYSTEM
	SINGLE GANG PLASTER RING AND PULL LINE IN A 1" CONDUIT TO CABLE TRAY. MOUNTING DESIGNATIONS: "C"=ABOVE COUNTER. WIRING AND JACKS BY I.T. SUBCONTRACTOR.		CONTACT, NORMALLY CLOSED (NC).	ARCH ARCHITECT AT AMP TRIP
×		"a" =SWITCHED OUTLET, "a" - INDICATES SWITCH CONTROL. "C" = MOUNTED 6" ABOVE COUNTER OR 42" AFF. COORDINATE EXACT	ST       SHUNT TRIP COIL.         CUSTOMER METERING, ELECTRONIC SOLID STATE,	ATC AUTO-TEMP CONTROL CONTRACTOR ATS AUTOMATIC TRANSFER SWITCH
$\bowtie$	DATA OUTLET - AT 18" A.F.F. UNO-DOUBLE GANG BOX WITH SINGLE GANG PLASTER RING AND PULL LINE IN A 1" CONDUIT TO CABLE TRAY. MOUNTING DESIGNATIONS: "C"=ABOVE COUNTER,	MOUNTING HEIGHT WITH ARCHITECTURAL DRAWINGS. "F" =FURNITURE MTD, COORDINATE EXACT LOCATION WITH FURNITURE PLANS.	CUSTOMER METERING, ELECTRONIC SOLID STATE, UNLESS OTHERWISE INDICATED.	AWG AMERICAN WIRE GAUGE C CONDUIT (GENERIC TERM FOR
	"AN"=WIRELESS ACCESS POINT MTD. AT 8' -6" A.F.F. U.N.O. JACKS AND WIRING BY I.T. SUBCONTRACTOR.	"GFC" =GROUND FAULT INTERRUPTER TYPE MOUNTED AT 42" AFF.	$\begin{array}{ccc} & & & \\ & & & \\ & & & \\ \neg & & & \\ \neg & & \\ \neg & & \\ \neg & & \\ \neg & & \\ \hline \end{array}$	RACEWAY. PROVIDE AS SPECIFIED) CATV CABLE TELEVISION
	DATA OUTLET FLUSH FLOOR MOUNTED - PROVIDE FLOOR BOX	"GFI" = GROUND FAULT INTERRUPTER TYPE. "H" =HORIZONTALLY MOUNTED.	(GF) GROUND FAULT SENSOR & RELAY.	CB CIRCUIT BREAKER CKT CIRCUIT
	WITH SINGLE GANG OPENING WITH 1"C. WITH PULL LINE TO NEAREST ACCESSIBLE CEILING OF SAME FLOOR. WIRING AND	"IG" = ISOLATED GROUND RECEPTACLE WITH SEPARATE GREEN GROUND CONDUCTOR WITH YELLOW STRIPE TO ISOLATED GROUND BUS IN PANEL.	400A	CLG CEILING CM CONSTRUCTION MANAGER
	JACKS BY I.T. SUBCONTRACTOR. CLOCK, WALL MOUNTED - 120V PIGTAIL CONNECTOR FURNISHED	"M" = MODULAR FURNITURE SERVICE - PROVIDE FLEXIBLE CONNECTION, COORDINATE EXACT LOCATION WITH FURNITURE PLANS.	300A SWITCH AND FUSE "400A" - INDICATES AMPERE SWITCH SIZE. "300A" - INDICATES AMPERE FUSE SIZE.	CU COPPER G_ CENTERLINE
Ŷ	BY I.T. SUBCONTRACTOR AND CONNECTED BY E.C. COORDINATE M.H. WITH I.T. SUBCONTRACTOR. CONNECT TO NEAREST 120V RECEPTACLE CIRCUIT OR AS SHOWN ON DRAWINGS. CLOCK	"SP" = SURGE PROTECTION RECEPTACLE		DEP DEPARTMENT OF ENVIRONMENTAL PROTECTION
<b>\</b>	FURNISHED & INSTALLED BY I.T. SUBCONTRACTOR.	"T" = TAMPER RESISTANT SAFETY RECEPTACLE. "TL" = TWIST LOCK TYPE.	SYSTEM GROUND OR EQUIPMENT GROUND.	DP DEEP EPA ENVIRONMENTAL PROTECTION AGENCY
CR 🏳	DATA OUTLET FOR DATA CORD REEL - MTD AT UNI-STRUT GRID UNO. SINGLE GANG OPENING WITH SINGLE GANG PLASTER RING AND PULL LINE TO NEAREST ACCESSIBLE CEILING SPACE. DATA	"WP" = WEATHERPROOF RECEPTACLE WITH "NRTL" LISTED COVERPLATE FOR WET LOCATION WITH GFI TYPE RECEPTACLE INSTALLED	AUTOMATIC TRANSFER SWITCH.	DWG DRAWING EC ELECTRICAL CONTRACTOR
	WIRING AND JACK BY I.T. SUBCONTRACTOR. REFER TO FLOOR PLANS. DATA CORD REEL PROVIDED BY E.C.	IN NEMA 4 ENCLOSURE W/KEY LOCK. "CD" = CABLE DROP RECEPTACLE- REFER TO CABLE DROP DETAIL.	(K1) KIRK-KEY INTERLOCK	EWCELECTRIC WATER COOLEREMTELECTRIC METALLIC TUBING
	VIDEO OUTLET & (2) 20AMP 120VOLT DUPLEX RECEPTACLE OUTLET PROVIDE WIREMOLD SERIES EFSB4 WALL BOX MODEL# EFSB4 OR EQUAL- AT 54"A.F.F.,	"CR" = CORD REEL - REFER TO FLOOR PLANS AND CORD REEL DETAIL.	MISCELLANEOUS-DEVICES	FAFIRE ALARMFPCFIRE PROTECTION SYSTEM CONTRACTOR
	UNO-WITH (1)1"C. FOR DATA AND (1)2"C FOR FUTURE A/V WIRING WITH PULL LINE TO CABLE TRAY. DATA WIRING AND JACK BY I.T. SUBCONTRACTOR. SEE DETAIL 3/E306	"P" = PEDESTAL MOUNTED ON CASEWORK WITH GFI RECEPTACLE. COORDINATE WITH EQUIPMENT DRAWINGS FOR EXACT LOCATION.	EMERGENCY POWER SHUNT TRIP - RED MUSHROOM HEAD WITH EXTENDED	F&I FURNISHED AND INSTALLED G,GND GROUND
	VIDEO OUTLET & (2) 20AMP 120VOLT DUPLEX RECEPTACLE OUTLET PROVIDE	"E" = RECEPTACLE CONNECTED TO NORMAL/EMERGENCY CIRCUIT. "G" = OUTLET FOR GOGGLE CABINET, MOUNTED 6'-6" A.F.F. (REFER TO ARCHITECTURAL ELEVATIONS)	(EPO)       NAMEPLATE INDICATING LOAD CONTROLLED "B" - INDICATES BREAK GLASS         STATION WITH HAMMER SUPPORT CLIP AND FIVE REPLACEMENT DISCS STORED	CM GENERAL CONTRACTOR  CONSTRUCTION GFI GROUND FAULT INTERRUPTER
	WIREMOLD SERIES EFSB4 WALL BOX MODEL# EFSB4 OR EQUAL- AT 54"A.F.F., UNO-WITH (1)1"C. FOR DATA AND (1)2"C FOR FUTURE A/V WIRING WITH PULL LINE TO CABLE TRAY. DATA WIRING AND JACK BY I.T. SUBCONTRACTOR.	$\Phi$ 20AMP, 120 VOLT SINGLE RECEPTACLE	INSIDE BOX SUPPORTING DEVICE.	HVAC HEATING, VENTILATING, AND AIR CONDITIONING CONTRACTOR
	SEE DETAIL 3/E306	$ \bigcirc 20 $ AMP, 120 VOLT DUPLEX RECEPTACLE; "2" INDICATES CIRCUIT NUMBER.	4"SQ X 2 1/2"DP JB AND 1"C WITH PULL LINE TO ELECTRIC DOOR OPERATOR.	HP HORSEPOWER IG ISOLATED GROUND
Ţ	VOICE/DATA OUTLET - AT 18" A.F.F., UNO - (2)DOUBLE GANG OPENING AND (2) 4"SQ.X4"DEEP J.B. WITH (4) 1"C. WITH PULL LINE T TO CABLE TRAY. (1) SINGLE GANG OPENINGS AND (1) 4"SQ. X 2 1/2"DP J.B. WITH (2) 1"C. WITH PULL LINE TO CABLE	<ul> <li>20AMP, 120 VOLT DOUBLE DUPLEX RECEPTACLE.</li> <li>20 AMP, 120 VOLT DUPLEX RECEPTACLE INTENDED FOR SWITCHED POWER.</li> </ul>	SVSOLENOID VALVE - F&I BY P.C., WIRED BY E.C.TCTIMECLOCK - 7 DAY DIGITAL WITH BATTERY BACK-UP.	IMCINTERMEDIATE METALLIC CONDUITITINFORMATION TECHNOLOGY CONTRACTOR
	TRAY. MOUNTING DESIGNATIONS: "C"=ABOVE COUNTER. WIRING AND JACKS BY I.T. SUBCONTRACTOR.	<ul> <li>COLOR OF OUTLET TO BE SELECTED BY OWNER.</li> <li>SPECIAL PURPOSE OUTLET - RATING AS INDICATED ON DRAWINGS.</li> </ul>	EFS EYE WASH FLOW SWITCH-F&I BY P.C., WIRED TO SECURITY SYSTEM BY E.C.	JB JUNCTION BOX KCMIL THOUSAND CIRCULAR MILS
<u>T2</u>	VOICE/DATA OUTLET - AT 18" A.F.F., UNO - (1)DOUBLE GANG OPENING AND (2)	EXAMPLE; ELECTRIC DRYER= 30A, 125/250V, 3 POLE, 4 WIRE, NEMA 14-30R ELECTRIC RANGE= 50A, 125/250V, 3 POLE, 4 WIRE, NEMA 14-50R	TPD TEMPERATURE SENSOR - CONNECT TO SECURITY SYSTEM.	KES KITCHEN EQUIPMENT SUPPLIER KVA KILO-VOLT AMPERE
V	4"SQ.X4"DEEP J.B. WITH (2) 1"C. WITH PULL LINE TO CABLE TRAY. (2) SINGLE GANG OPENINGS AND (2) 4"SQ. X 2 1/2"DP J.B. WITH (2) 1"C. WITH PULL LINE TO CABLE TRAY MOUNTING DESIGNATIONS: "C"=ABOVE COUNTER. WIRING AND JACKS BY I.T.	20 AMP, 120 VOLT DUPLEX RECEPTACLE FLUSH FLOOR MOUNTED WITH COVER.	LSLIMIT SWITCH.BODOOR BELL-COORDINATE MH WITH ARCHITECT.	KW KILO-WATT LTG LIGHTING
	SUBCONTRACTOR.	20 AMP, 120 VOLT DOUBLE DUPLEX RECEPTACLE FLUSH FLOOR MOUNTED WITH COVER. EWC J DEWC ELECTRIC WATER COOLER OUTLET OR BOTTLE FILLING STATION - 20 AMP, 120 VOLT.	LOW VOLTAGE PUSHBUTTON.	MCB MAIN CIRCUIT BREAKER MCC MOTOR CONTROL CENTER
S	CEILING FLUSH MOUNTED SPEAKER. BACKBOX FURNISHED BY IT SUBCONTRACTOR, INSTALLED BY E.C.	PROVIDE GROUND FAULT INTERRUPTER TYPE CIRCUIT BREAKER.	DETAIL IDENTIFIER-INDICATES DETAIL #1 ON DWG. E-3.	MDP MAIN DISTRIBUTION PANEL
⊢S	FLUSH MOUNTED WALL MOUNTED SPEAKER. BACKBOX FURNISHED BY IT SUBCONTRACTOR, INSTALLED BY E.C.	20AMP, 120VOLT DUPLEX RECEPTACLE CONNECTED TO NORMAL/ EMERGENCY CIRCUIT.	GROUND BAR 24W" X 1/8" THICK X 18" LONG COPPER BUS, U.N.O.	MH MOUNTING HEIGHT MLO MAIN LUGS ONLY
⊢S WP	FLUSH MOUNTED EXTERIOR SPEAKER - BACKBOX FURNISHED BY I.T. CONTRACTOR, INSTALLED BY E.C.	SURFACE RACEWAY WITH BASE, COVER, AND DIVIDER "B,C&D". IVORY FINISH. PROVIDE FIBER READY 2" RADIUS FITTINGS. SOLID END INDICATES RISE TO ABOVE ACCESSIBLE CEILING SPACE WITH B,C&D.	1 A A SECTION IDENTIFIER- INDICATES SECTION A-A, DETAIL #2 ON DWG. E-3.	MTD MOUNTED MTG MOUNTING
$(\mathbf{S})$	CEILING SURFACE MOUNTED SPEAKER. BACKBOX FURNISHED BY	20 AMP, 120 VOLT GFI, HORIZONTALLY MOUNTED ON FURNITURE DUPLEX RECEPTACLE	E-3 K2 EQUIPMENT TAG NUMBER, REFER TO EQUIPMENT SCHEDULE, "K" INDICATES KITCHEN "C" INDICATES COMPLIER	
۳	IT SUBCONTRACTOR, INSTALLED BY E.C.	<ul> <li>INTENDED FOR COMPUTER USE. COLOR OF OUTLET TO BE SELECTED BY OWNER.</li> <li>20 AMP, 120 VOLT DUPLEX RECEPTACLE INTENDED FOR COMPUTER USE.</li> </ul>	<ul> <li>"C" INDICATES COMPUTER.</li> <li>KEYED SHEET NOTE SYMBOL, "1" INDICATES TO REFER TO NOTE #1</li> </ul>	NO,# NUMBER NTS NOT TO SCALE
V	WALL MOUNTED VOLUME CONTROL OUTLET AS DESIGNATED- SINGLE GANG JB WITH SINGLE GANG PLASTER RING AND PULL LINE IN A 1" CONDUIT TO CABLE TRAY.	COLOR OF OUTLET TO BE SELECTED BY OWNER.	3 CIRCUIT SIZE NUMBER, REFER TO "CIRCUIT SIZE SCHEDULE".	P POLE(S) PB PULL BOX
	MOUNTING HEIGHT AT 48" A.F.F. UNLESS OTHERWISE NOTED. WIRING AND JACKS BY I.T. SUBCONTRACTOR.	20AMP, 120VOLT DOUBLE DUPLEX RECEPTACLE INTENDED FOR COMPUTER USE. COLOR OF OUTLET TO BE SELECTED BY OWNER.	SB SCOREBOARD CONTROL OUTLET - WALL MOUNTED AT 18"	PC PLUMBING CONTRACTOR PH, PHASE
SRP	SMART RESCUE PHONE. CUSTOM BACK BOX FURNISHED BY IT SUBCONTRACTOR AND INSTALL BY E.C. 1" CONDUIT W/PULL STRING TO CABLE TRAY BY E.C DEVICE AND WIRING BY I.T. SUBCONTRACTOR.	→       ●	4"SQ. X 2 1/2"DP J.B. WITH 1"C. WIRING AND JACKS BY I.T. CONTRACTOR.	PVCPOLY-VINYL CHLORIDE CONDUITPWRPOWER
	AREA OF RESCUE ASSISTANCE BUTTON. CUSTOM BACK BOX FURNISHED BY IT	FOR (4) RJ45 JACKS EQUAL TO WIREMOLD #RFB4-XX - FPCTCBS (CARPET), FPBTCBS (WOOD FLOOR). PROVIDE 1"C FOR TEL/DATA TO NEAREST ACCESSIBLE CEILING SPACE.	ADA CS ADA "CALL STATION", HANDS FREE. MOUNT AT 48"AFF.	REF REFRIGERATOR RGS RIGID GALVANIZED STEEL CODUIT
ARA	SUBCONTRACTOR AND INSTALL BY E.C. 1" CONDUIT W/PULL STRING TO CABLE TRAY BY E.C., DEVICE AND WIRING BY I.T. SUBCONTRACTOR.	RECESSED FLOOR BOX WITH (2) 20A, 120V DUPLEX RECEPTACLES AND PROVISIONS FOR (4) RJ45 JACKS EQUAL TO WIREMOLD #RFB8S-XX - FPCTCBS (CARPET), FPBTCBS	ADA [MCS] ADA "MASTER CALL STATION", HANDS FREE. MOUNT AT 48"AFF.	SNSOLID NEUTRALSWBDSWITCHBOARD
IC	INTERCOM CALL SWITCH - AT 48" A.F.F., - SINGLE GANG JB AND 4"SQ. X 2 1/2"DP J.B. WITH 1"C. WITH PULL LINE TO CABLE TRAY. MOUNTING WIRING AND JACKS BY I.T.	(WOOD FLOOR). PROVIDE (6)1"C FOR TEL/DATA TO NEAREST ACCESSIBLE CEILING SPACE.	H P EMERGENCY CALL STATION - LOCATE WITHIN 3' OF WATER CLOSET WITH PULL CORD EXTENDING TO WITHIN 12" OF THE FLOOR.	TEL/DATA TELEPHONE/DATA TGP TELECOMMUNICATIONS GROUND BUS
	SUBCONTRACTOR	FLUSH MOUNTED 2 HOUR RATED POKE-THRU ASSEMBLY WITH (2) DUPLEX RECEPTACLES & (4) COMMUNICATION DEVICES EQUAL TO WIREMOLD EVOLUTION 6AT	AUDIO/VISUAL SIGNAL FOR SINGLE TOILETS. MOUNT OVER DOOR.	TYP TYPICAL UNO UNLESS NOTED OTHERWISE
(M)-	MICROPHONE OUTLET AS DESIGNATED- SINGLE GANG FACE PLATE AND 4"SQ.X2 1/2"DPJ. BOX. E.C. SHALL PROVIDE 1"C. WITH PULL LINE TO	<ul> <li>SERIES WITH SOLID BRASS FINISH RING OR EQUAL. REQUIRES 6" CORED HOLE.</li> <li>RECESSED 2HR RATED FLOOR BOX WITH (2) 20A, 120V DUPLEX RECEPTACLES AND</li> </ul>	ELECTRIC DOOR-OPERATOR. FURN. & INST. BY GC, WIRED BY EC.	WG WIRE GUARD WP WEATHERPROOF
	ACCESSIBLE CEILING SPACE. OR DIRECTLY TO AMPLIFIER WHERE EXPOSED STRUCTURE OR NON-ACCESSIBLE CLG. WIRING AND JACKS BY IT SUBCONTRACTOR.	PROVISIONS FOR (4) RJ45 JACKS EQUAL TO WIREMOLD #RFB8S-FC - FPCTCBS (CARPET), FPBTCBS (WOOD FLOOR). PROVIDE (6)1"C FOR TEL/DATA TO NEAREST ACCESSIBLE	LIMIT SWITCH FURNISHED BY SYSTEM SUPPLIER, WIRED BY E.C.	XFMR TRANSFORMER XP EXPLOSION PROOF
AMP	SOUND SYSTEM AMPLIFIER SYSTEM FURNISHED BY IT SUBCONTRACTOR, INSTALLED AND WIRED BY EC.	CEILING SPACE. CR CORD REEL - REFER TO FLOOR PLANS AND CORD REEL DETAIL.		@72" MOUNT 72 INCHES TO CENTERLINE ABOVE FINISHED FLOOR OR GRADE
A/J	AUDIO OUTLET AS DESIGNATED- SINGLE GANG FACE PLATE	<u>POWER</u>	FIRE ALARM SYSTEM	
	AND 4"SQ.X2 1/2"DPJ. BOX. E.C. SHALL PROVIDE 1"C. WITH PULL LINE TO ACCESSIBLE CEILING SPACE. OR DIRECTLY TO AMPLIFIER WHERE EXPOSED STRUCTURE OR	120/208 VOLT, 3 PHASE, 4 WIRE PANELBOARD.	FMANUAL PULL STATION - MTD 48" AFF TO Q.FFITTTTT	RE FIGHTERS PHONE (PHONE AND CABINET).
	NON-ACCESSIBLE CLG. WIRING AND JACKS BY IT SUBCONTRACTOR.	277/480 VOLT, 3 PHASE, 4 WIRE, PANELBOARD.		OST INDICATOR VALVE-F&I BY FPC, WIRED BY EC. /ALL MOUNTED CARBON MONOXIDE DETECTOR, MOUNTING
⊢ <mark>S</mark> WP	FLUSH WALL MOUNTED LOCAL SOUND SYSTEM SPEAKER. BACKBOX FURNISHED BY IT SUBCONTRACTOR, INSTALLED BY E.C. 1" CONDUIT WITH PULL LINE & RUN TO AMPLIFIER BY E.C	120/208 VOLT, 3 PHASE, 4 WIRE NORMAL/EMERGENCY SYSTEM PANELBOARD.	FCOHF(S)SPEAKER/VISUAL "ADA" COMPLIANT SIGNAL - MTD 80" $\Box$ O	EIGHT PER MANUFACTURERS RECOMMENDATION. PROVIDE NE MONITOR MODULE PER SENSOR.
S	CEILING MOUNTED LOCAL SOUND SYSTEM SPEAKER.	277/480 VOLT 3 PHASE, 4 WIRE NORMAL/EMERGENCY SYSTEM PANELBOARD.	(F) SPEAKER/VISUAL "ADA" COMPLIANT SIGNAL - CEILING MTD.	ALL MOUNTED COMBUSTIBLE GAS DETECTOR (CH4) . PROVIDE FIRE ALARM CONTROL MODULE PER DETECTOR FOR
Lo	BACKBOX FURNISHED BY IT SUBCONTRACTOR, INSTALLED BY E.C. 1" CONDUIT WITH PULL LINE & RUN TO AMPLIFIER BY E.C	PANELBOARD FLUSH MOUNTED.		ONITORING BY THE FACP. MOUNT 1' BELOW CEILING. IRE ALARM ELECTRIC BELL (120 VOLTS), MOUNTED ABOVE
GS	CEILING MOUNTED GYMNASIUM LOUDSPEAKER. BACKBOX FURNISHED BY IT SUBCONTRACTOR, INSTALLED BY E.C. PROVIDE 1" CONDUIT WITH PULL LINE TO AMPLIFIER.	T5 T DRY TYPE TRANSFORMER - REFER TO TRANSFORMER SCHEDULE FOR RATINGS "T5"-INDICATES 45KVA TRANSFORMER. "K13" INDICATES TRANSFORMER WITH A K13 RATING.	SE SMOKE DETECTOR ALSO USED FOR ELEVATOR RECALL.	IRE DEPARTMENT SPRINKLER CONNECTION. FURNISHED BY P.C., INSTALLED & WIRED BY E.C.
HA1	ANTENNA WALL PLATE - AT 10'-6" A.F.F. UNO-SINGLE GANG OPENING AND 4"SQ. X 2 1/2"DP J.B. WITH 1" CONDUIT WITH PULL	E ELECTRIC MANHOLE	State       DUCT TYPE SMOKE DETECTOR WITH SAMPLING TUBE.         D       FURNISHED BY EC, INSTALLED BY HVAC, WIRED BY EC.	
	LINE & RUN TO AMPLIFIER BY E.C JACKS AND WIRING BY I.T. SUBCONTRACTOR.	TELEPHONE MANHOLE	S DUCT TYPE SMOKE DETECTOR WITH SAMPLING TUBE	
$\vdash (A)$	AUDIO INPUT PLATE - AT 15" A.F.F. UNO-SINGLE GANG OPENING AND 4"SQ. X 2 1/2"DP J.B. WITH 1" CONDUIT WITH PULL LINE & RUN		FURNISHED BY EC, INSTALLED BY HVAC, WIRED BY EC.Spot type smoke detector used to initiate atrium smoke control	
	TO AMPLIFIER BY E.C JACKS AND WIRING BY I.T. SUBCONTRACTOR.	METER SOCKET J J JUNCTION BOX - SIZE AS REQUIRED.	$F(\hat{H})_{135^{\circ}}$ THERMAL DETECTOR - 135°F FIXED TEMPERATURE AND	
ACS	AUDIO CONTROL STATION - AT 46" A.F.F. UNO-FIVE GANG OPENING AND 12 1/4"W X 4 1/2"H X 2 1/2"D J.B. WITH (3)1" CONDUIT WITH PULL LINE & RUN TO AMPLIFIER BY E.C JACKS AND WIRING BY I.T.	DW (J)~_ JUNCTION BOX - WITH FLEXIBLE CONNECTION TO EQUIPMENT-"DW" DENOTES	$\bigcirc$ RATE OF RISE. "F" INDICATES FIXED TEMPERATURE ONLY. H 200° THERMAL DETECTOR - 200°F FIXED TEMPERATURE.	
	SUBCONTRACTOR.	DISHWASHER, "H" HOOD, "WO" WALL OVEN, "D" DISPOSER, "HD" HAND DRYER.		
ALS	ASSISTIVE LISTENING SYSTEM. F & I BY I.T. CONTRACTOR.	$\frac{20}{30} - \text{INDICATES TIME DELAY FUSE SIZE.}$	T BD BEAM SMOKE DETECTOR -"T" DESIGNATES TRANSMITTER, "R" RECEIVER.	
R	PRIORITY RELAY. F & I BY I.T. CONTRACTOR.	- 3R UNFUSED DISCONNECT SWITCH HEAVY DUTY TYPE-"3R" INDICATES NEMA 3R	RTKEY OPERATED REMOTE TEST STATION WITH LED-LABEL.FSSPRINKLER FLOW SWITCH - F&I BY F.P.C. WIRED BY E.C.	
		RV MAGNETIC MOTOR STARTER, "RV" INDICATES REDUCED VOLTAGE.	TSSPRINKLER TAMPER SWITCH - F&I BY F.P.C. WIRED BY E.C.	
			PS   SPRINKLER PRESSURE SWITCH - F&I BY F.P.C. WIRED BY E.C.	
		TS       HORSEPOWER RATED THERMAL SWITCH WITH PILOT LIGHT         VFD       VARIABLE FREQUENCY DRIVE.	LPS       SPRINKLER LOW PRESSURE SWITCH - F&I BY F.P.C. WIRED BY E.C.         FSD       FIRE SMOKE DAMPER - F&I BY HVAC CONTRACTOR, WIRED BY E.C. CONTROL	
		C MULTI-POLE CONTACTOR IN NEMA I ENCLOSURE-RATINGS AND NUMBER OF	MODULE AND FIRE ALARM INTERLOCK WIRED BY ELECTRICAL CONTRACTOR. ■ DH MAGNETIC DOOR HOLDER - MTD 80" AFF TO Q.	
		POLES AS REQUIRED.         CP       EQUIPMENT CONTROL PANEL.	$\square DC$ ELECTRIC DOOR CLOSER-F&I BY HARDWARE, WIRED BY EC.	
		UCP UTILITY CONTROL PANEL (LABS)	FACP FIRE ALARM CONTROL PANEL.	
		ATS AUTOMATIC TRANSFER SWITCH.	ANN FIRE ALARM ANNUNCIATOR.	
		HOA HAND-OFF-AUTOMATIC SELECTOR SWITCH.	RRED FIRE ALARM BEACON-WEATHERPROOF.WWHITE FIRE ALARM BEACON-WEATHERPROOF.	
		••• THREE FUNCTION PUSHBUTTON SWITCH (UP/DOWN/STOP)-FURNISHED BY EQUIPMENT SUPPLIER, INST. & WIRED BY EC.	FRED FIRE ALARM LIGHT OVER MASTER BOX-WEATHERPROOF.IMMMONITOR MODULE	
		ON/OFF PUSHBUTTON SWITCH.	CM CONTROL MODULE	
		70AT 100AFCBENCLOSED CIRCUIT BREAKER-"70AT" INDICATES 70 AMP TRIP; "100AF" INDICATES 100 AMP FRAME.	IM     ISOLATION MODULE       K     KEY REPOSITORY BOX (KNOX BOX)	
		PB     PULL BOX-SIZE AS REQUIRED.       G     GENERATOR.	FATCFIRE ALARM TERMINAL CABINETEVACFIRE ALARM VOICE EVACUATION PANEL.	
			FCC     FIRE COMMAND CENTER	

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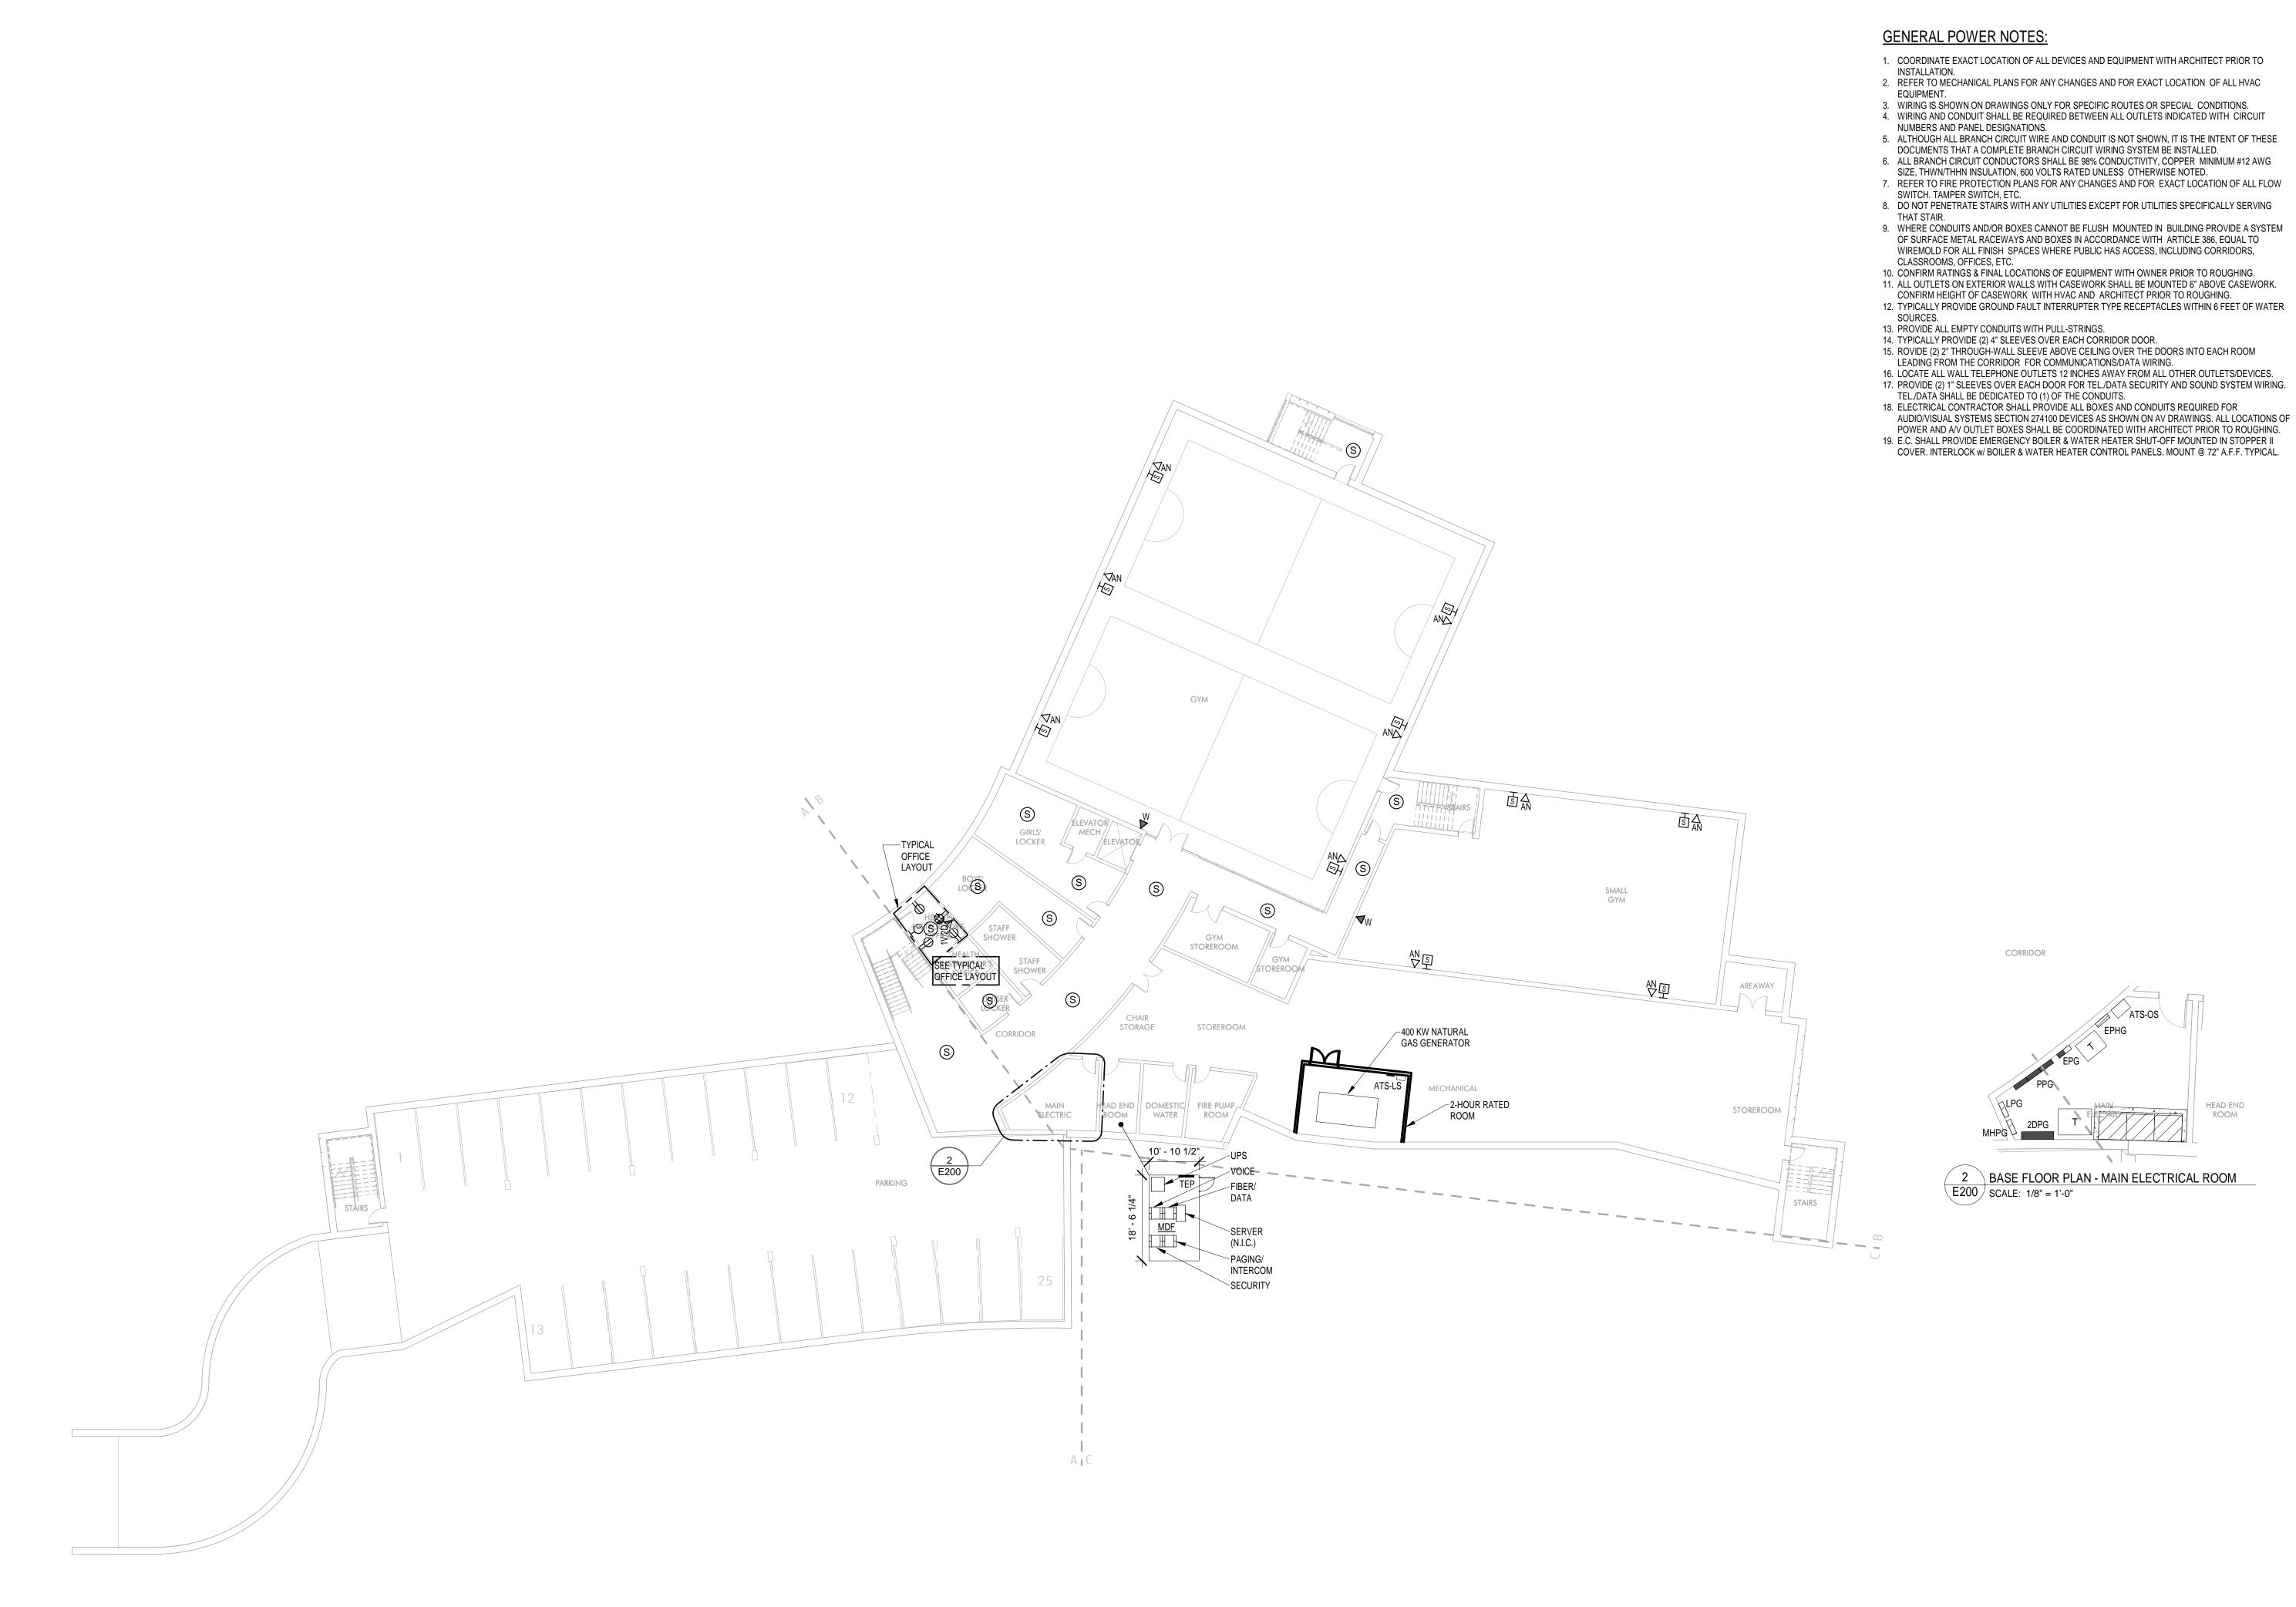
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 SCHOOL DRISC PROJECT STATUS SD - PRICING 04/19/19 REVISIONS No. Date Description DRAWING NAME ELECTRICAL SYMBOL LIST

Jonathan Levi Architects

PROJECT NO. Project Number DRAWING NO.


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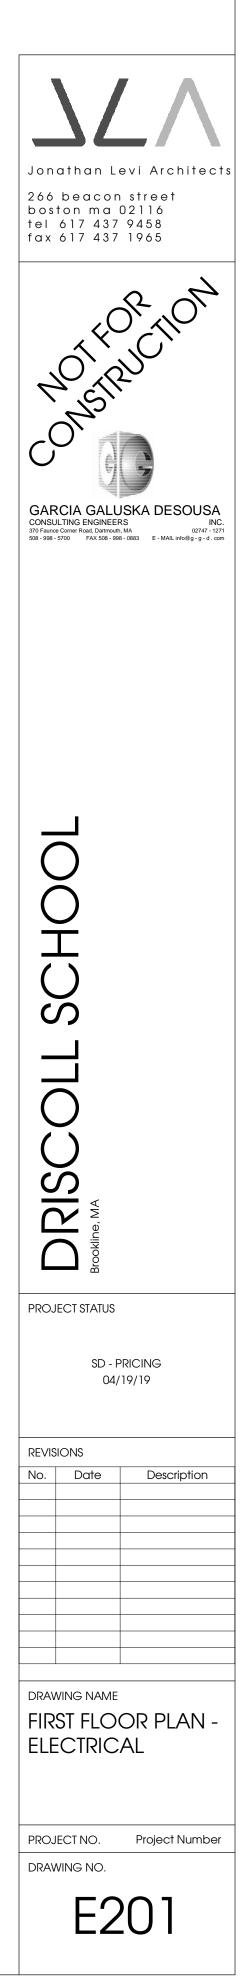
1 BASE FLOOR PLAN - ELECTRICAL E200 SCALE: 1/16" = 1'-0"

HEAD END ROOM







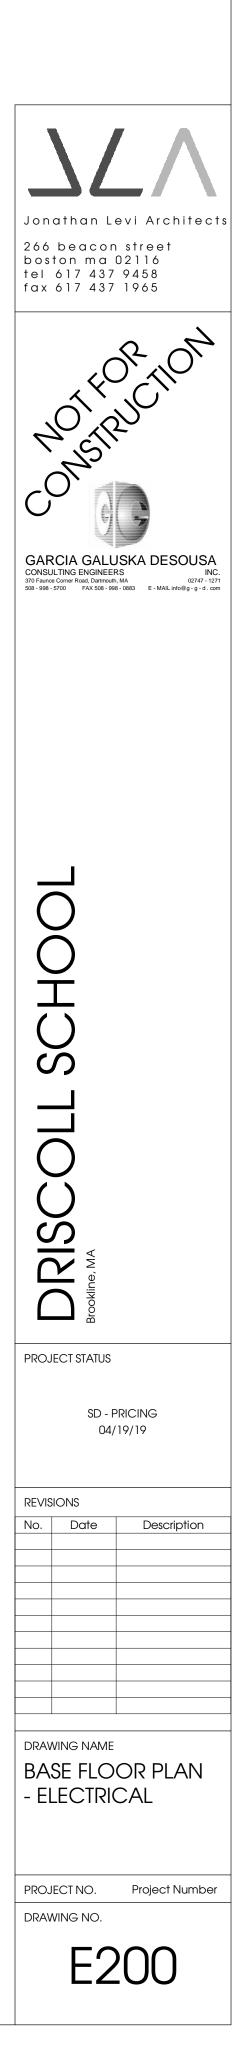













GENERAL POWER NOTES:

- COORDINATE EXACT LOCATION OF ALL DEVICES AND EQUIPMENT WITH ARCHITECT PRIOR TO INSTALLATION.
- 2. REFER TO MECHANICAL PLANS FOR ANY CHANGES AND FOR EXACT LOCATION OF ALL HVAC EQUIPMENT. 3. WIRING IS SHOWN ON DRAWINGS ONLY FOR SPECIFIC ROUTES OR SPECIAL CONDITIONS.
- 4. WIRING AND CONDUIT SHALL BE REQUIRED BETWEEN ALL OUTLETS INDICATED WITH CIRCUIT NUMBERS AND PANEL DESIGNATIONS.
- 5. ALTHOUGH ALL BRANCH CIRCUIT WIRE AND CONDUIT IS NOT SHOWN, IT IS THE INTENT OF THESE DOCUMENTS THAT A COMPLETE BRANCH CIRCUIT WIRING SYSTEM BE INSTALLED. 6. ALL BRANCH CIRCUIT CONDUCTORS SHALL BE 98% CONDUCTIVITY, COPPER MINIMUM #12 AWG
- SIZE, THWN/THHN INSULATION, 600 VOLTS RATED UNLESS OTHERWISE NOTED. 7. REFER TO FIRE PROTECTION PLANS FOR ANY CHANGES AND FOR EXACT LOCATION OF ALL FLOW SWITCH. TAMPER SWITCH, ETC.
- 8. DO NOT PENETRATE STAIRS WITH ANY UTILITIES EXCEPT FOR UTILITIES SPECIFICALLY SERVING THAT STAIR. 9. WHERE CONDUITS AND/OR BOXES CANNOT BE FLUSH MOUNTED IN BUILDING PROVIDE A SYSTEM
- OF SURFACE METAL RACEWAYS AND BOXES IN ACCORDANCE WITH ARTICLE 386, EQUAL TO WIREMOLD FOR ALL FINISH SPACES WHERE PUBLIC HAS ACCESS, INCLUDING CORRIDORS, CLASSROOMS, OFFICES, ETC.
- 10. CONFIRM RATINGS & FINAL LOCATIONS OF EQUIPMENT WITH OWNER PRIOR TO ROUGHING. 11. ALL OUTLETS ON EXTERIOR WALLS WITH CASEWORK SHALL BE MOUNTED 6" ABOVE CASEWORK. CONFIRM HEIGHT OF CASEWORK WITH HVAC AND ARCHITECT PRIOR TO ROUGHING.
- 12. TYPICALLY PROVIDE GROUND FAULT INTERRUPTER TYPE RECEPTACLES WITHIN 6 FEET OF WATER SOURCES. PROVIDE ALL EMPTY CONDUITS WITH PULL-STRINGS.
   TYPICALLY PROVIDE (2) 4" SLEEVES OVER EACH CORRIDOR DOOR.
- 15. ROVIDE (2) 2" THROUGH-WALL SLEEVE ABOVE CEILING OVER THE DOORS INTO EACH ROOM LEADING FROM THE CORRIDOR FOR COMMUNICATIONS/DATA WIRING.
- 16. LOCATE ALL WALL TELEPHONE OUTLETS 12 INCHES AWAY FROM ALL OTHER OUTLETS/DEVICES. 17. PROVIDE (2) 1" SLEEVES OVER EACH DOOR FOR TEL./DATA SECURITY AND SOUND SYSTEM WIRING. TEL./DATA SHALL BE DEDICATED TO (1) OF THE CONDUITS.
- 18. ELECTRICAL CONTRACTOR SHALL PROVIDE ALL BOXES AND CONDUITS REQUIRED FOR AUDIO/VISUAL SYSTEMS SECTION 274100 DEVICES AS SHOWN ON AV DRAWINGS. ALL LOCATIONS OF
- POWER AND A/V OUTLET BOXES SHALL BE COORDINATED WITH ARCHITECT PRIOR TO ROUGHING. 19. E.C. SHALL PROVIDE EMERGENCY BOILER & WATER HEATER SHUT-OFF MOUNTED IN STOPPER II COVER. INTERLOCK w/ BOILER & WATER HEATER CONTROL PANELS. MOUNT @ 72" A.F.F. TYPICAL.

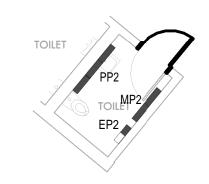

2 SECOND FLOOR PLAN - ELECTRICAL ROOM E202 SCALE: 1/8" = 1'-0"

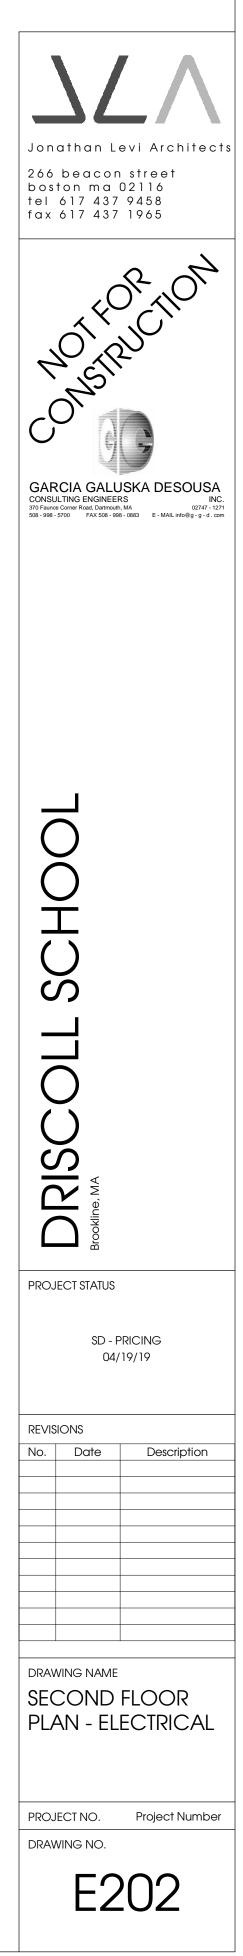








1 THIRD FLOOR PLAN - ELECTRICAL E203 SCALE: 1/16" = 1'-0"

**GENERAL POWER NOTES:** 

- 1. COORDINATE EXACT LOCATION OF ALL DEVICES AND EQUIPMENT WITH ARCHITECT PRIOR TO INSTALLATION.
- 2. REFER TO MECHANICAL PLANS FOR ANY CHANGES AND FOR EXACT LOCATION OF ALL HVAC EQUIPMENT. 3. WIRING IS SHOWN ON DRAWINGS ONLY FOR SPECIFIC ROUTES OR SPECIAL CONDITIONS.
- 4. WIRING AND CONDUIT SHALL BE REQUIRED BETWEEN ALL OUTLETS INDICATED WITH CIRCUIT NUMBERS AND PANEL DESIGNATIONS.
- 5. ALTHOUGH ALL BRANCH CIRCUIT WIRE AND CONDUIT IS NOT SHOWN, IT IS THE INTENT OF THESE DOCUMENTS THAT A COMPLETE BRANCH CIRCUIT WIRING SYSTEM BE INSTALLED. 6. ALL BRANCH CIRCUIT CONDUCTORS SHALL BE 98% CONDUCTIVITY, COPPER MINIMUM #12 AWG
- SIZE, THWN/THHN INSULATION, 600 VOLTS RATED UNLESS OTHERWISE NOTED. 7. REFER TO FIRE PROTECTION PLANS FOR ANY CHANGES AND FOR EXACT LOCATION OF ALL FLOW SWITCH. TAMPER SWITCH, ETC.
- 8. DO NOT PENETRATE STAIRS WITH ANY UTILITIES EXCEPT FOR UTILITIES SPECIFICALLY SERVING THAT STAIR. 9. WHERE CONDUITS AND/OR BOXES CANNOT BE FLUSH MOUNTED IN BUILDING PROVIDE A SYSTEM
- OF SURFACE METAL RACEWAYS AND BOXES IN ACCORDANCE WITH ARTICLE 386, EQUAL TO WIREMOLD FOR ALL FINISH SPACES WHERE PUBLIC HAS ACCESS, INCLUDING CORRIDORS, CLASSROOMS, OFFICES, ETC.
- 10. CONFIRM RATINGS & FINAL LOCATIONS OF EQUIPMENT WITH OWNER PRIOR TO ROUGHING. 11. ALL OUTLETS ON EXTERIOR WALLS WITH CASEWORK SHALL BE MOUNTED 6" ABOVE CASEWORK. CONFIRM HEIGHT OF CASEWORK WITH HVAC AND ARCHITECT PRIOR TO ROUGHING.
- 12. TYPICALLY PROVIDE GROUND FAULT INTERRUPTER TYPE RECEPTACLES WITHIN 6 FEET OF WATER SOURCES. 13. PROVIDE ALL EMPTY CONDUITS WITH PULL-STRINGS.
- 14. TYPICALLY PROVIDE (2) 4" SLEEVES OVER EACH CORRIDOR DOOR. 15. ROVIDE (2) 2" THROUGH-WALL SLEEVE ABOVE CEILING OVER THE DOORS INTO EACH ROOM LEADING FROM THE CORRIDOR FOR COMMUNICATIONS/DATA WIRING.
- 16. LOCATE ALL WALL TELEPHONE OUTLETS 12 INCHES AWAY FROM ALL OTHER OUTLETS/DEVICES. 17. PROVIDE (2) 1" SLEEVES OVER EACH DOOR FOR TEL./DATA SECURITY AND SOUND SYSTEM WIRING. TEL./DATA SHALL BE DEDICATED TO (1) OF THE CONDUITS.
- 18. ELECTRICAL CONTRACTOR SHALL PRÓVIDE ALL BOXES AND CONDUITS REQUIRED FOR AUDIO/VISUAL SYSTEMS SECTION 274100 DEVICES AS SHOWN ON AV DRAWINGS. ALL LOCATIONS OF
- POWER AND A/V OUTLET BOXES SHALL BE COORDINATED WITH ARCHITECT PRIOR TO ROUGHING. 19. E.C. SHALL PROVIDE EMERGENCY BOILER & WATER HEATER SHUT-OFF MOUNTED IN STOPPER II COVER. INTERLOCK w/ BOILER & WATER HEATER CONTROL PANELS. MOUNT @ 72" A.F.F. TYPICAL.

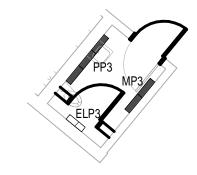

2 THIRD FLOOR PLAN - ELECTRICAL ROOM E203 SCALE: 1/8" = 1'-0"

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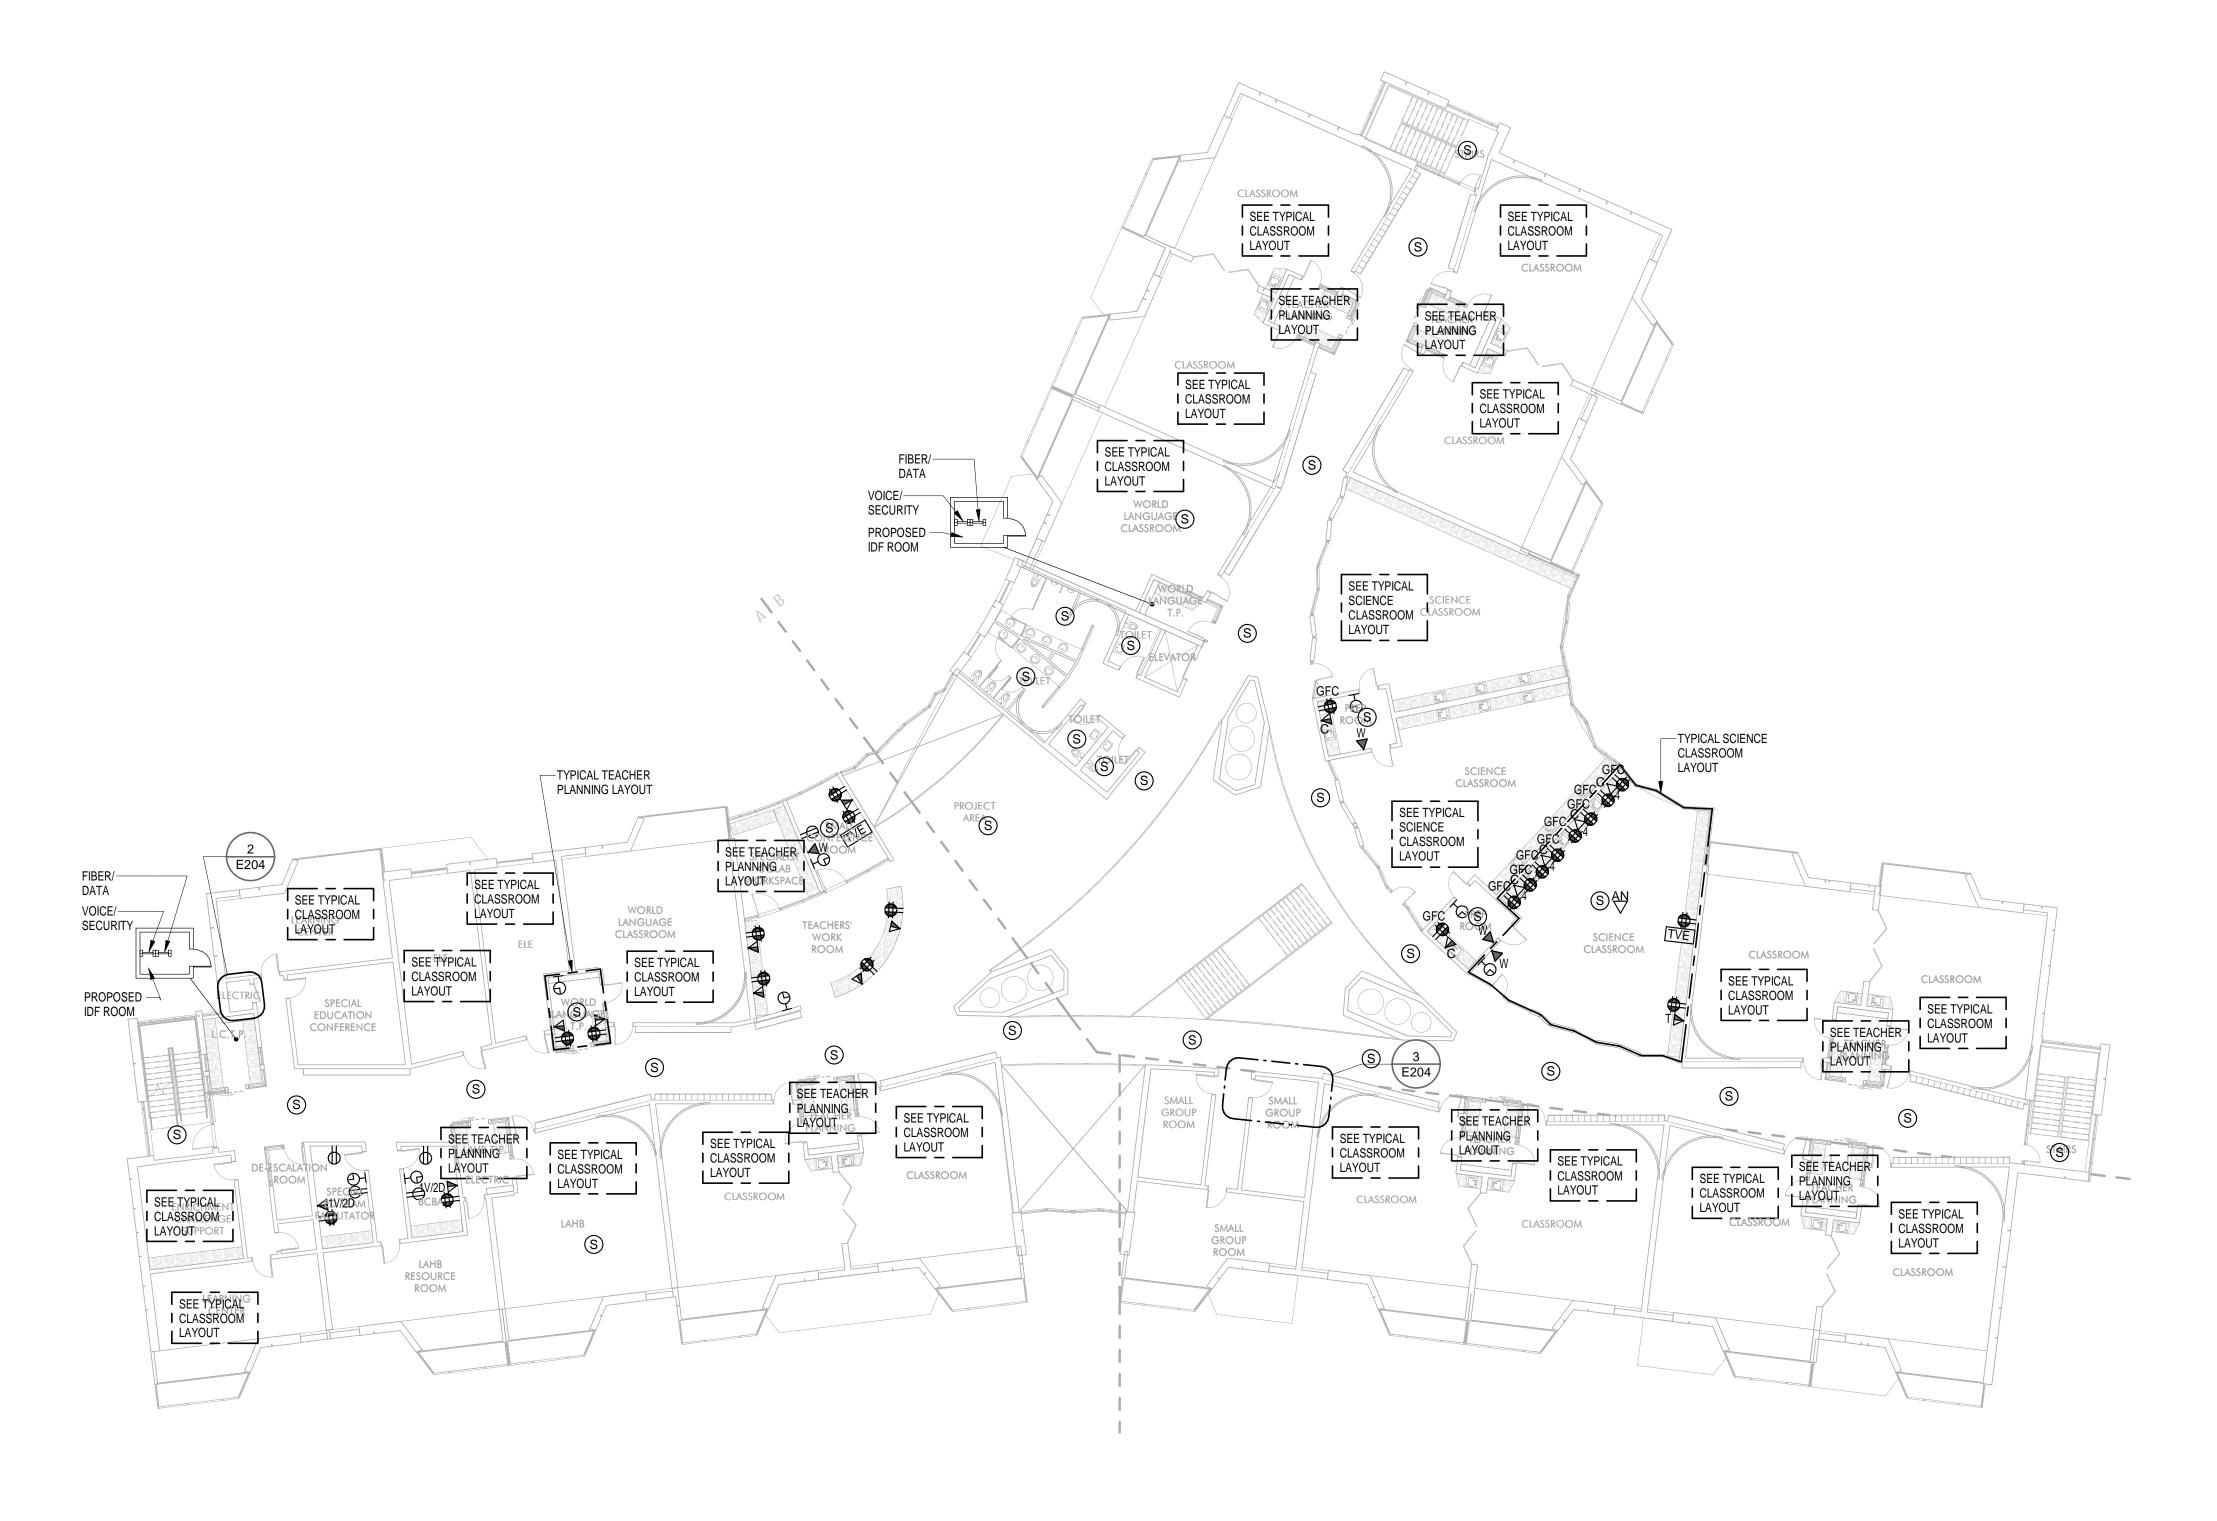
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 SCHO DRISC PROJECT STATUS SD - PRICING 04/19/19 REVISIONS No. Date Description DRAWING NAME THIRD FLOOR PLAN - ELECTRICAL PROJECT NO. Project Number DRAWING NO. E203









1 FOURTH FLOOR PLAN - ELECTRICAL E204 SCALE: 1/16" = 1'-0"

## **GENERAL POWER NOTES:**


- 1. COORDINATE EXACT LOCATION OF ALL DEVICES AND EQUIPMENT WITH ARCHITECT PRIOR TO INSTALLATION. 2. REFER TO MECHANICAL PLANS FOR ANY CHANGES AND FOR EXACT LOCATION OF ALL HVAC
- EQUIPMENT. 3. WIRING IS SHOWN ON DRAWINGS ONLY FOR SPECIFIC ROUTES OR SPECIAL CONDITIONS.
- 4. WIRING AND CONDUIT SHALL BE REQUIRED BETWEEN ALL OUTLETS INDICATED WITH CIRCUIT NUMBERS AND PANEL DESIGNATIONS. 5. ALTHOUGH ALL BRANCH CIRCUIT WIRE AND CONDUIT IS NOT SHOWN, IT IS THE INTENT OF THESE
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- 7. REFER TO FIRE PROTECTION PLANS FOR ANY CHANGES AND FOR EXACT LOCATION OF ALL FLOW SWITCH. TAMPER SWITCH, ETC. 8. DO NOT PENETRATE STAIRS WITH ANY UTILITIES EXCEPT FOR UTILITIES SPECIFICALLY SERVING
- THAT STAIR. 9. WHERE CONDUITS AND/OR BOXES CANNOT BE FLUSH MOUNTED IN BUILDING PROVIDE A SYSTEM OF SURFACE METAL RACEWAYS AND BOXES IN ACCORDANCE WITH ARTICLE 386, EQUAL TO
- WIREMOLD FOR ALL FINISH SPACES WHERE PUBLIC HAS ACCESS, INCLUDING CORRIDORS, CLASSROOMS, OFFICES, ETC. 10. CONFIRM RATINGS & FINAL LOCATIONS OF EQUIPMENT WITH OWNER PRIOR TO ROUGHING. 11. ALL OUTLETS ON EXTERIOR WALLS WITH CASEWORK SHALL BE MOUNTED 6" ABOVE CASEWORK.
- CONFIRM HEIGHT OF CASEWORK WITH HVAC AND ARCHITECT PRIOR TO ROUGHING. 12. TYPICALLY PROVIDE GROUND FAULT INTERRUPTER TYPE RECEPTACLES WITHIN 6 FEET OF WATER SOURCES.
- 13. PROVIDE ALL EMPTY CONDUITS WITH PULL-STRINGS. 14. TYPICALLY PROVIDE (2) 4" SLEEVES OVER EACH CORRIDOR DOOR. 15. ROVIDE (2) 2" THROUGH-WALL SLEEVE ABOVE CEILING OVER THE DOORS INTO EACH ROOM
- LEADING FROM THE CORRIDOR FOR COMMUNICATIONS/DATA WIRING. 16. LOCATE ALL WALL TELEPHONE OUTLETS 12 INCHES AWAY FROM ALL OTHER OUTLETS/DEVICES. 17. PROVIDE (2) 1" SLEEVES OVER EACH DOOR FOR TEL./DATA SECURITY AND SOUND SYSTEM WIRING.
- TEL./DATA SHALL BE DEDICATED TO (1) OF THE CONDUITS. 18. ELECTRICAL CONTRACTOR SHALL PROVIDE ALL BOXES AND CONDUITS REQUIRED FOR AUDIO/VISUAL SYSTEMS SECTION 274100 DEVICES AS SHOWN ON AV DRAWINGS. ALL LOCATIONS OF
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2 FOURTH FLOOR PLAN - ELECTRICAL ROOM AREA A E204 SCALE: 1/8" = 1'-0"

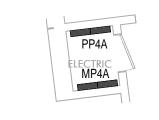


3 FOURTH FLOOR PLAN - ELECTRICAL ROOM AREA C E204 SCALE: 1/8" = 1'-0"

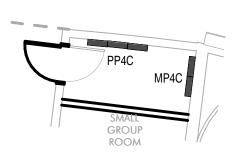



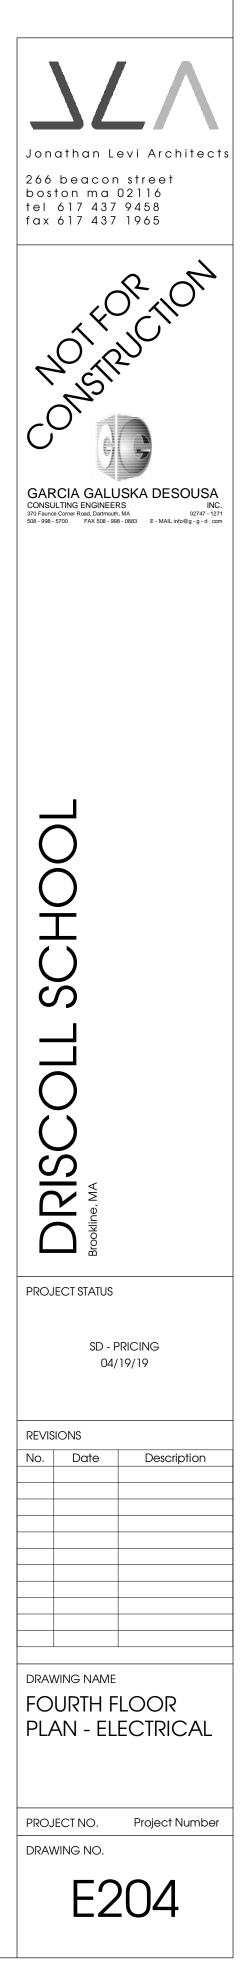



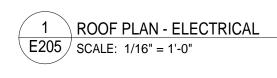

### GENERAL POWER NOTES:

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   TYPICALLY PROVIDE (2) 4" SLEEVES OVER EACH CORRIDOR DOOR.
- 15. ROVIDE (2) 2" THROUGH-WALL SLEEVE ABOVE CEILING OVER THE DOORS INTO EACH ROOM LEADING FROM THE CORRIDOR FOR COMMUNICATIONS/DATA WIRING. 16. LOCATE ALL WALL TELEPHONE OUTLETS 12 INCHES AWAY FROM ALL OTHER OUTLETS/DEVICES.
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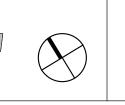
17. PROVIDE (2) 1" SLEEVES OVER EACH DOOR FOR TEL./DATA SECURITY AND SOUND SYSTEM WIRING.


Jonathan Levi Architects 266 beacon street boston ma 02116 tel 617 437 9458 fax 617 437 1965 KOR X NSI'  $\mathcal{O}$  
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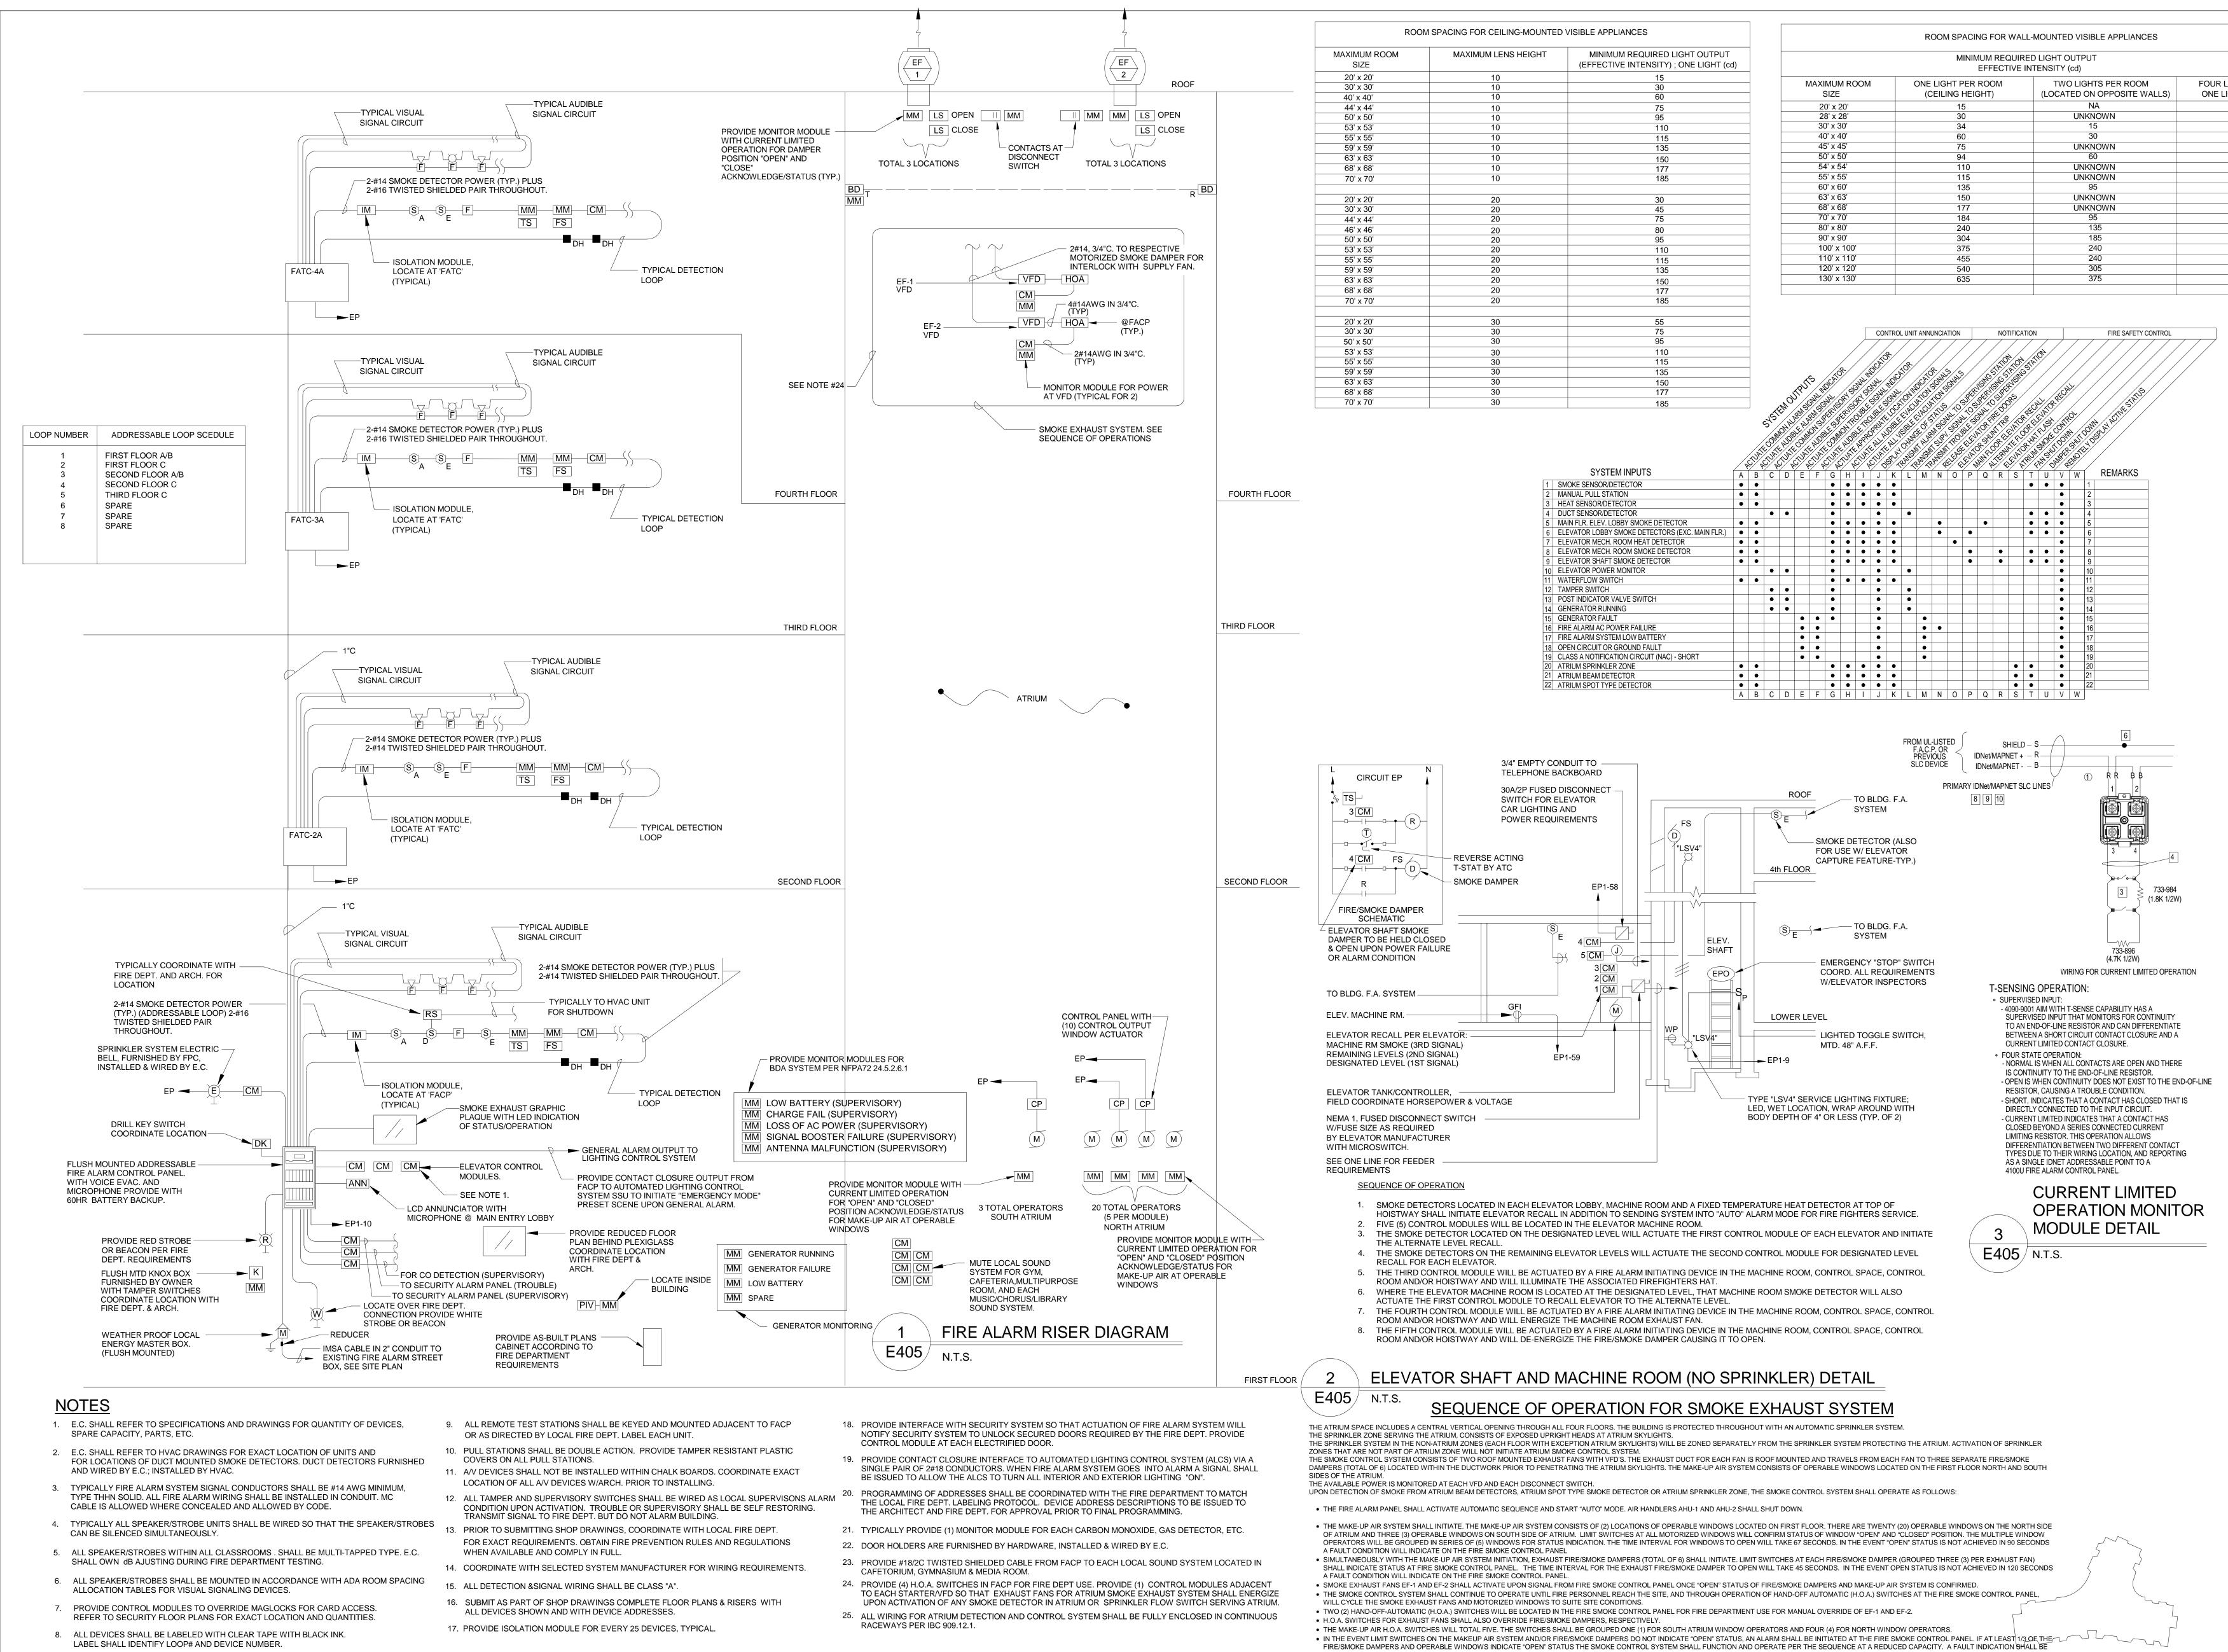
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 E - MAIL info@g-g-d.com
 CHO S **DRIS** PROJECT STATUS SD - PRICING 04/19/19 REVISIONS No. Date Description \_\_\_\_\_ DRAWING NAME ROOF PLAN -ELECTRICAL PROJECT NO. Project Number DRAWING NO. E205









M ROOM	MAXIMUM LENS HEIGHT	MINIMUM REQUIRED LIGHT OUTPUT (EFFECTIVE INTENSITY) ; ONE LIGHT (cd)	
0'	10	15	
0'	10	30	MAX
0'	10	60	
4'	10	75	2
0'	10	95	2
3'	10	110	3
5'	10	115	4
9'	10	135	4
3'	10	150	5
8'	10	177	5
'O'	10	185	5
			6
0'	20	30	6
0'	20	45	6
4'	20	75	7
6'	20	80	8
0'	20	95	9
3'	20	110	1
5'	20	115	1
9'	20	135	1
3'	20	150	1
8'	20	177	
<b>'</b> 0'	20	185	
0'	30	55	
0'	30	75	
0'	30	95	
3'	30	110	
5'	30	115	
9'	30	135	
3'	30	150	ENOUTPUTS IN SUM
8'	30	177	APV / I
0'	30	185	O'

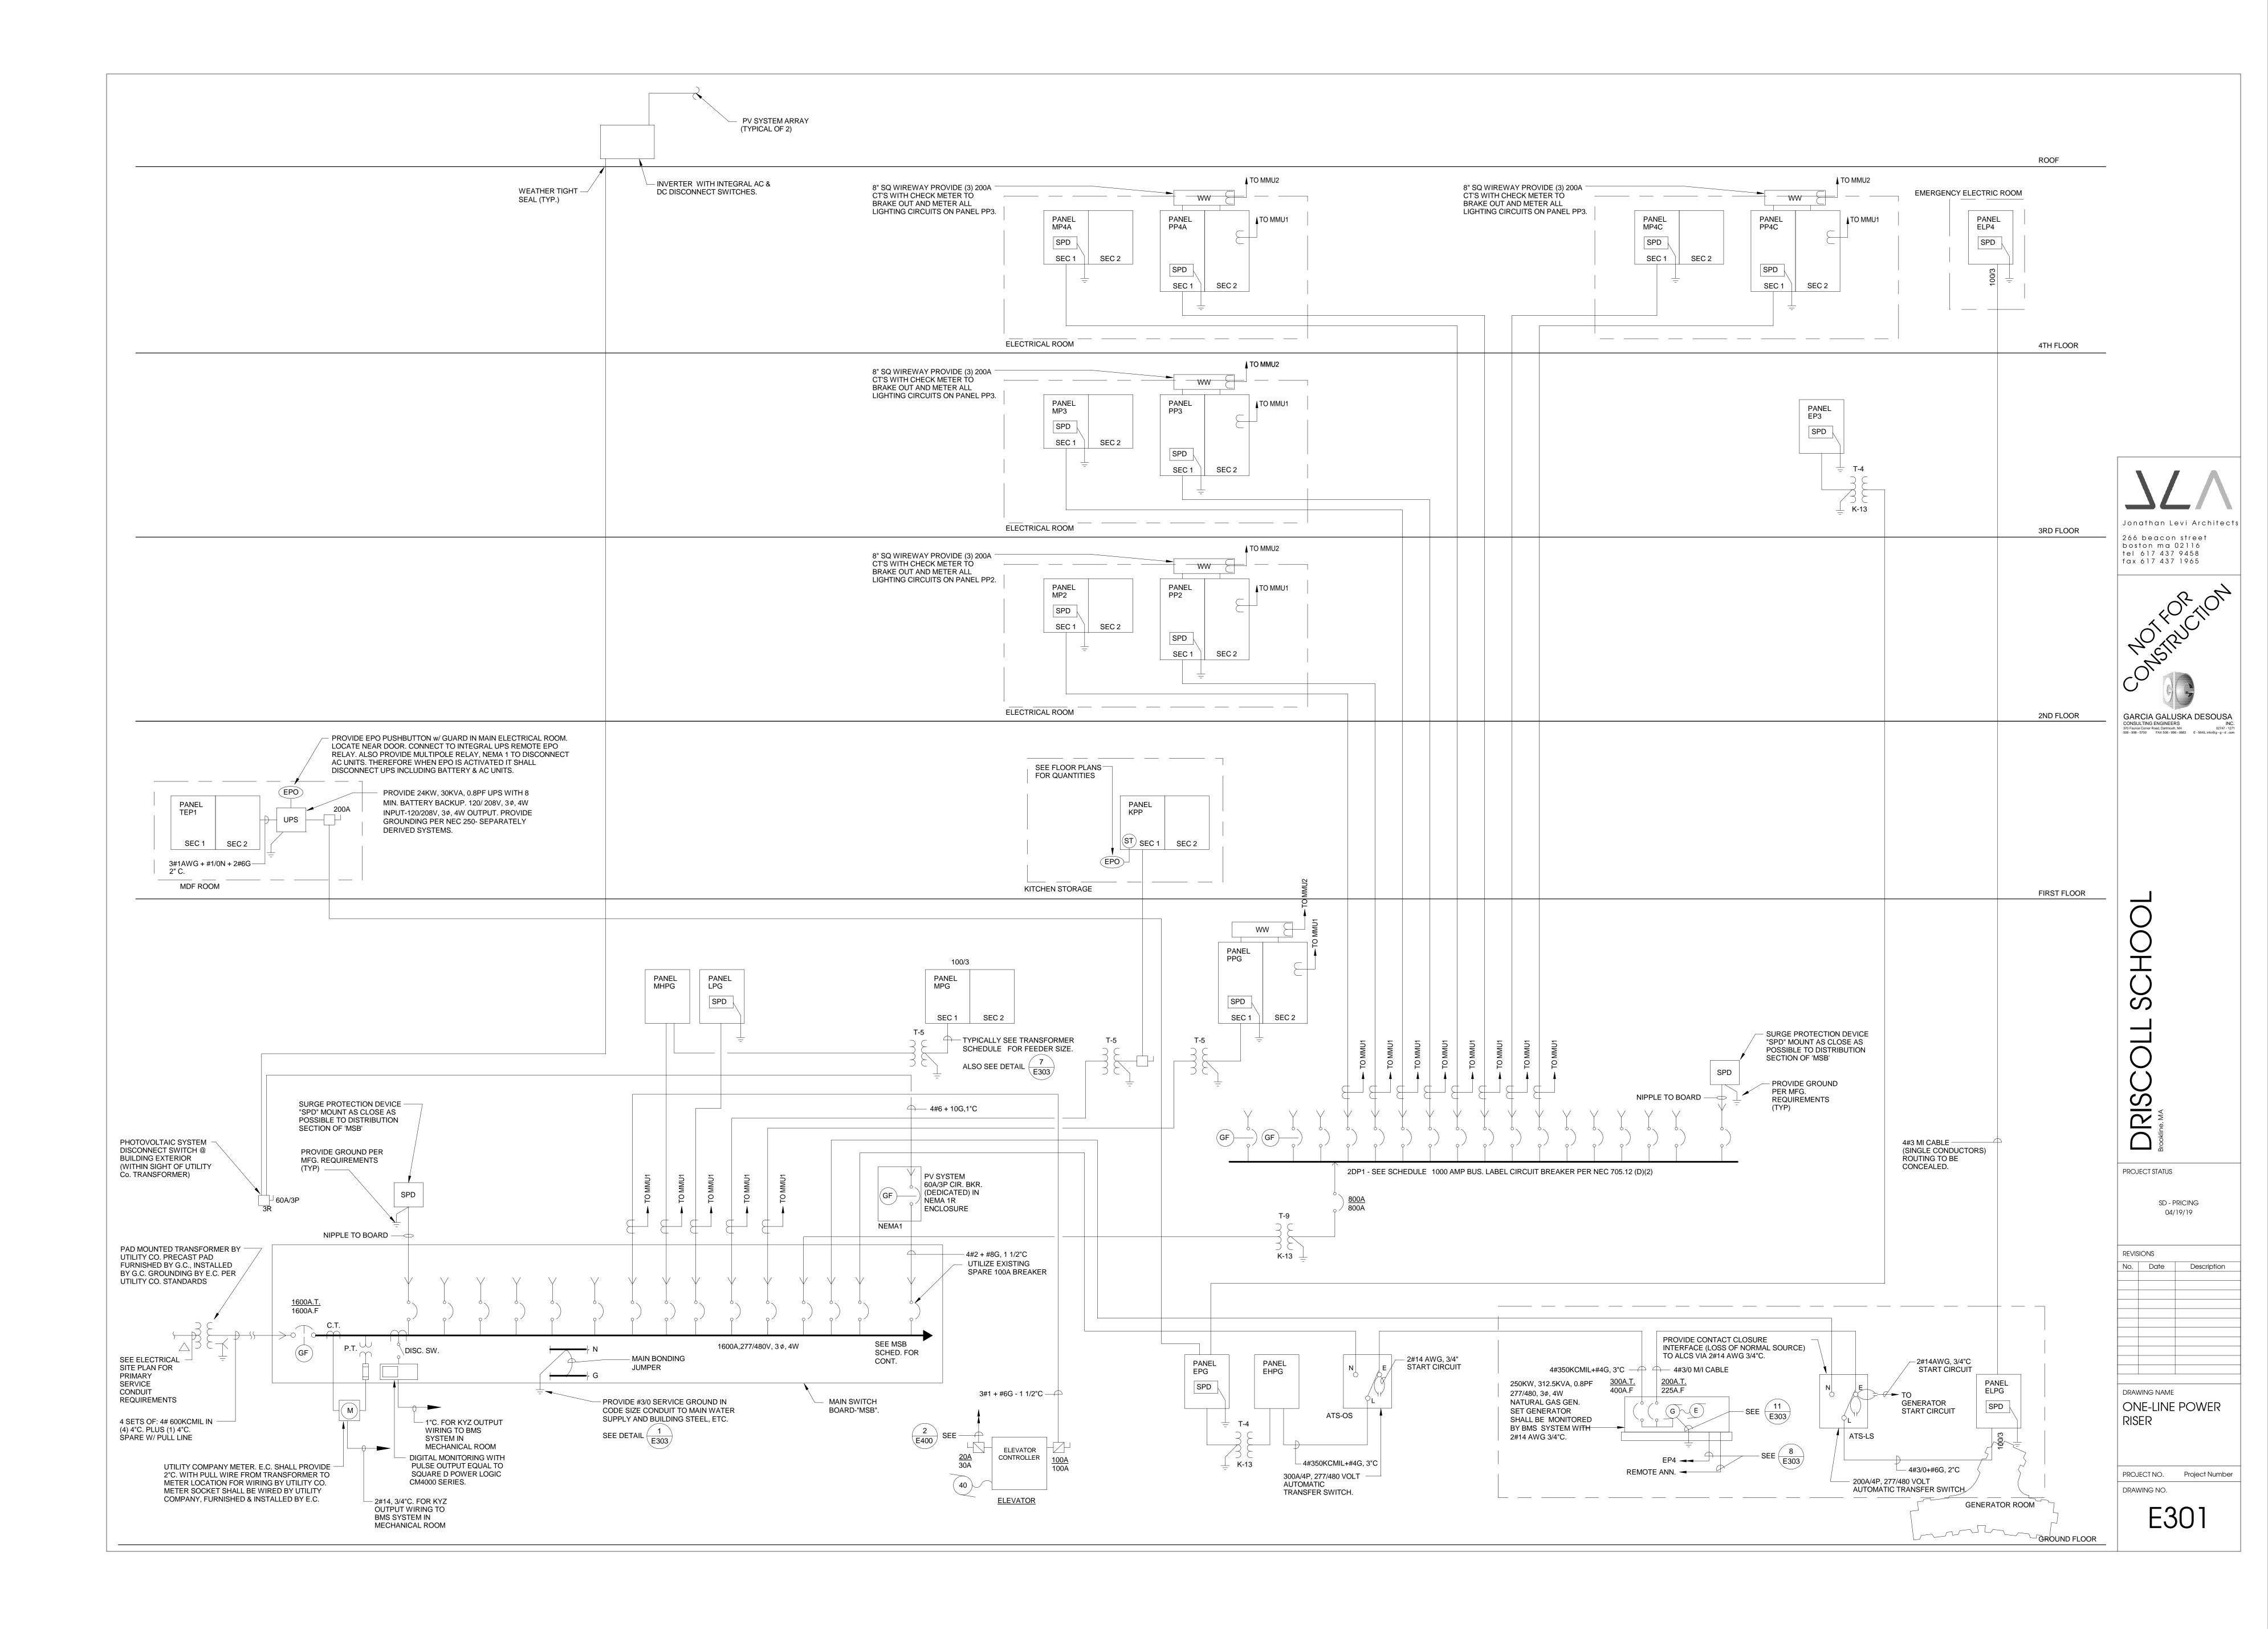	ROOM SPACING FOR WALL-MOUNTED VISIBLE APPLIANCES					
MINIMUM REQUIRED LIGHT OUTPUT EFFECTIVE INTENSITY (cd)						
MAXIMUM ROOM SIZE	ONE LIGHT PER ROOM (CEILING HEIGHT)	TWO LIGHTS PER ROOM (LOCATED ON OPPOSITE WALLS)	FOUR LIGHTS PER ROOM ONE LIGHT PER WALLS			
20' x 20'	15	NA	NA			
28' x 28'	30	UNKNOWN	NA			
30' x 30'	34	15	NA			
40' x 40'	60	30	15			
45' x 45'	75	UNKNOWN	19			
50' x 50'	94	60	30			
54' x 54'	110	UNKNOWN	30			
55' x 55'	115	UNKNOWN	28			
60' x 60'	135	95	30			
63' x 63'	150	UNKNOWN	37			
68' x 68'	177	UNKNOWN	43			
70' x 70'	184	95	60			
80' x 80'	240	135	60			
90' x 90'	304	185	95			
100' x 100'	375	240	95			
110' x 110'	455	240	135			
120' x 120'	540	305	135			
130' x 130'	635	375	185			

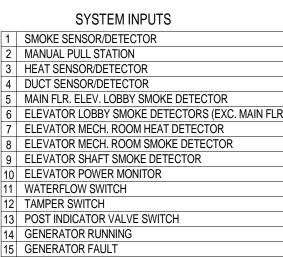

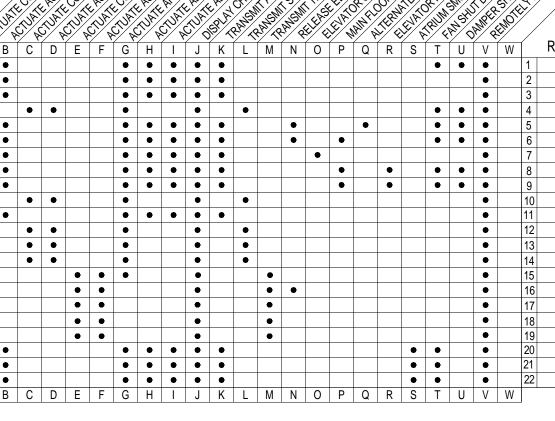

TRANSMITTED TO THE FIRE SMOKE CONTROL PANEL IF EACH GROUP OF WINDOWS DO NOT PROVE "OPEN" WITHIN 90 SECONDS INDICATE "FAULT" STATUS.

